



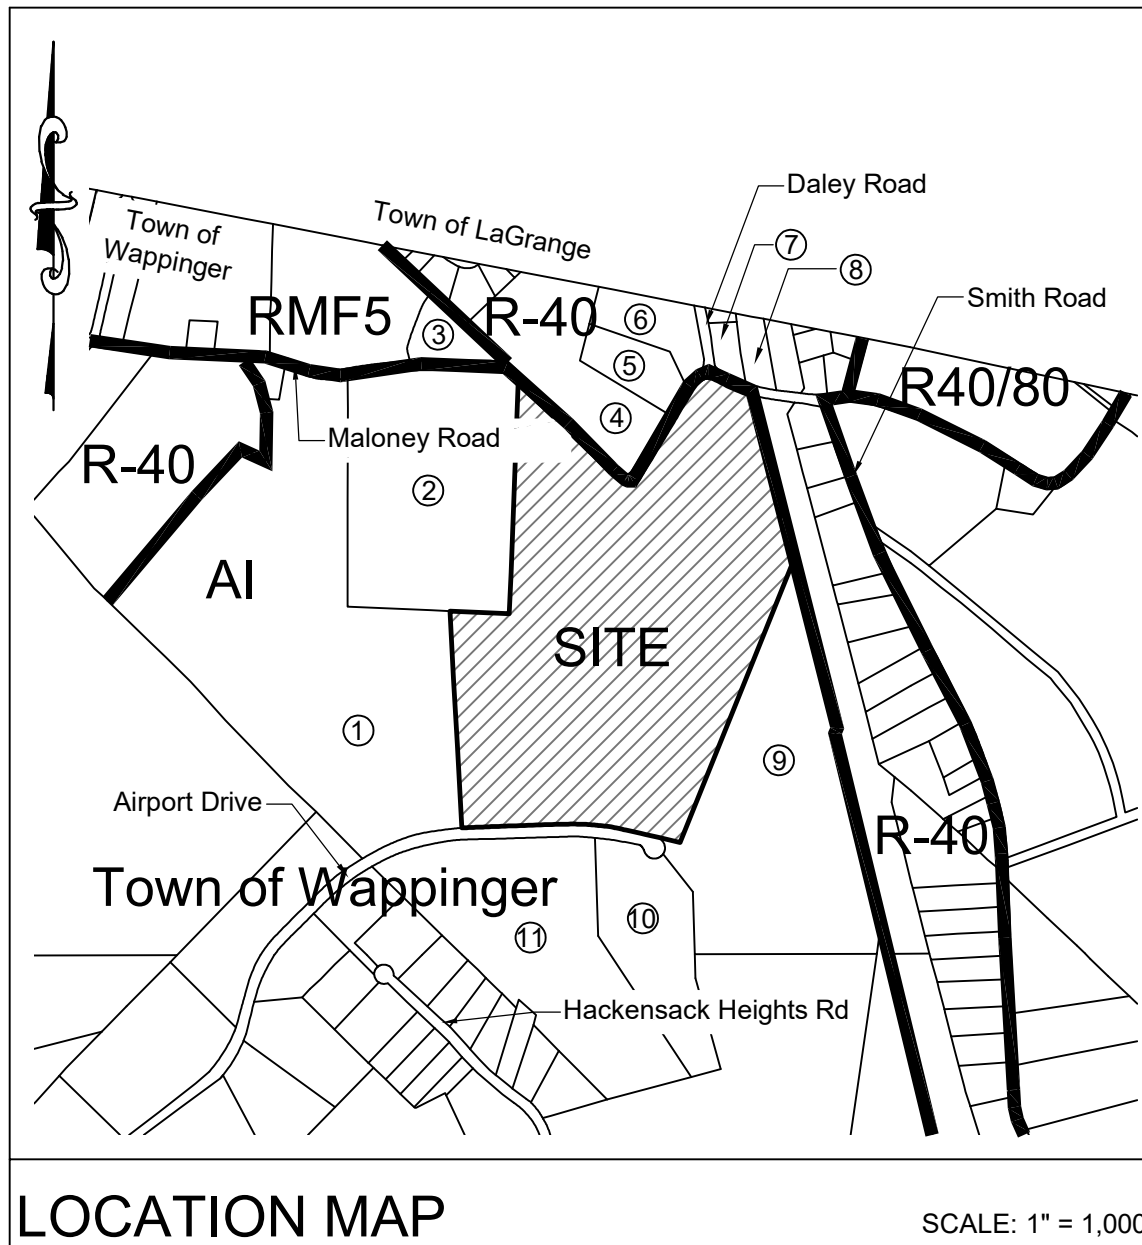
AMENDED SITE PLAN FOR HUDSON VALLEY LIGHTING

Tax Map No. 135689-6259-02-841673 151 Airport Road Town of Wappinger

PREPARED FOR
Jaleli, LLC
151 Airport Road
Wappingers Falls, NY 12590

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- | | | | |
|---|---|---|--|
| 1. HP Coolidge Maloney Road
4 W Red Oak Lane
White Plains, NY 10640
For Property:135689-6259-02-681675 | 4. Robert Hammond
450 Maloney Road
Poughkeepsie, NY 12603
For Property:135689-6259-02-818820 | 7. Thomas Lasko
404 Maloney Road
Poughkeepsie, NY 12603
For Property:135689-6259-02-903818 | 10. Alfred Rabasco
478 Rossway Road
Pleasant Valley, NY 12569
For Property:135689-6259-04-870494 |
| 2. HP Coolidge Maloney Road
4 W Red Oak Lane
White Plains, NY 10640
For Property:135689-6259-02-753743 | 5. Nicola Mastrantuono
410 Maloney Road
Wappingers Falls, NY 125900
For Property:135689-6259-02-858806 | 8. Dutchess County
22 Market Street
Poughkeepsie, NY 12601
For Property:135689-6359-03-075290 | 11. N.A.C. Industries Inc.
154 East Boston Post Road
Mamaroneck, NY 10543
For Property: 135689-6259-04-815490 |
| 3. Robert Quaranto
909 Beekman Road
Hopewell Junction, NY 12533
For Property:135689-6259-02-760823 | 6. Pier DiCamillo
162 Daley Road
Poughkeepsie, NY 12603
For Property:135689-6259-02-865829 | 9. Global Satellite, LLC
3 Nancy Court
Wappingers Falls, NY 12590
For Property:135689-6259-02-908414 | |

Zoning & Bulk Regulations

Zone Classification	AI - Airport Industry Warehouse		
Tax Map Parcel No	135689-6259-02-841673		
Topographic Datum	NAVD 88		
Total Acreage:	67.00 +/- Ac.		
Water Supply:	Private Water Supply		
Sewage Disposal:	Private Sewage Disposal System		
240 Attachment 4			
Schedule of Dimensional Regulation - Nonresidential Districts			
<u>Bulk Regulations:</u>	<u>Required</u>	<u>Existing</u>	<u>Proposed</u>
Minimum Area	2 Ac	67 Ac.	67 Ac.
Minimum Lot Width (feet)	200'	1354'	1354'
Minimum Depth (feet)	200'	1135.33'	1135.33'
Minimum street frontage (feet)	150'	2115.58'	2115.58'
Minimum Front Yard (feet) from:			
County/State Highway	75'	N/A	N/A
Front Lot Line of other Street	100	199.6'	199.6'
Minimum Side Yard ³ (feet)	50'	245.5'	245.5'
Side Yard R-40	25'	1132.1'	1127'
Accessory Building <15 feet high	50'	N/A	N/A
Minimum Rear Yard ⁴ (feet)	50'	1153.8'	802.6'
Rear Yard R-40	50'	1153.8'	802.6'
Accessory Building <15 feet high	50'	N/A	N/A
Maximum Building Height (stories/feet)	2.5/35'	2/<35'	2/<35'
Maximum Building Coverage (percent)	20%	8.3%	13.3%
Maximum Floor Area Ratio	0.3	0.083	0.13
Maximum Impervious Surface (%)	75%	14.59%	22.1%
Minimum Landscaped Open Space	25%	44.16%*	38.7%*
Minimum parking setback (feet) From:			
Front Lot Line	--	--	--
Side and rear lot line	--	--	--

³ Where a lot abuts land in a residential district, the most restrictive side yard setback requirement of either district shall govern.

⁴ Where a lot abuts land in a residential district, the most restrictive rear yard setback requirement of either district shall govern.

*Percentage of area of development.

Off-street Parking Calculations

§240-97 Off-Street Parking and Loading

Use	Square Feet Existing	Square Feet Proposed	Existing	Required	Proposed
Warehouse	244,393 S.F.	142,500 S.F.	227	244	
Landbanked spaces		386,893 S.F.Total		143	200
			Total:	387	387

Use Warehouse, storage, utility or other similar commercial use
Minimum Off-street Parking 1 per employee but not less than 1 per 1000 square feet of gross floor area

GENERAL SITE NOTES

- THE CONTRACTOR IS TO VISIT THE SITE AND THOROUGHLY ACQUAINT HIMSELF WITH ALL EXISTING CONDITIONS. TO CHECK AND VERIFY ALL CONDITIONS, DIMENSIONS, ETC. AND REPORT TO THE ARCHITECT ANY ERRORS, OMISSIONS, OR VARIATION FROM INTENT OF THE PLANS, PRIOR TO THE START OF WORK.
 - DRAWINGS ARE NOT TO BE SCALED. USE DIMENSIONS ONLY.
 - CONTRACTOR TO OBTAIN AND PAY FOR ALL REQUIRED LOCAL PERMITS. NO WORK IS TO COMMENCE UNTIL ALL PERMITS ARE OBTAINED.
 - THOSE ITEMS NOT NOTED, BUT IMPLIED AS NECESSARY FOR THE PERFORMANCE OF THE CONTRACT ARE CONSIDERED PART OF THE WORK.
 - ALL MATERIAL AND WORKMANSHIP IS TO BE GUARANTEED BY THE CONTRACTOR TO BE FREE OF DEFECTS FOR A PERIOD OF ONE YEAR. THE CONTRACTOR AGREES TO CORRECT, WITHOUT CHARGE, SUCH CONDITIONS AS MAY OCCUR DURING THE GUARANTEE PERIOD.
 - ALL WORK IS TO BE EXECUTED BY MECHANICS SKILLED IN THEIR TRADES.
 - ALL CHANGES AND/OR SUBSTITUTIONS ARE TO BE APPROVED IN WRITING BEFORE BEING INCORPORATED INTO THE WORK.
 - ALL TRADES TO COOPERATE WITH EACH OTHER TO FACILITATE THE PROGRESS OF THE ENTIRE JOB.
 - CONTRACTOR SHALL VERIFY WITH LOCAL UTILITY COMPANY THE POSSIBILITY OF ANY UNDERGROUND UTILITIES PRIOR TO ANY EXCAVATION.
 - CONTRACTOR IS TO REMOVE ALL RUBBISH FROM THE SITE RESULTING FROM HIS WORK DURING THE PROGRESS OF CONSTRUCTION AND SHALL LEAVE THE PREMISES IN A CONDITION SATISFACTORY TO THE OWNER PRIOR TO THE FINAL PAYMENT.
 - ALL MATERIALS, ASSEMBLIES, CONSTRUCTION AND EQUIPMENT SHALL CONFORM TO THE REGULATIONS OF THE BUILDING CODE OF NEW YORK STATE AND SHALL CONFORM TO GENERALLY ACCEPTED STANDARDS.
- BOUNDARY AND TOPOGRAPHICAL INFORMATION PER SURVEY PREPARED BY MILLMAN NATIONAL LAND SERVICES, PROJECT NUMBER 27481.

IT IS A VIOLATION OF NEW YORK STATE EDUCATION LAW FOR ANY PERSONS TO ALTER THESE PLANS, SPECIFICATIONS, OR REPORTS IN ANY WAY, UNLESS ACTING UNDER THE DIRECTION OF A LICENSED PROFESSIONAL ENGINEER OR LAND SURVEYOR.

Mark A. Day, PE	
Revision	
Project No.	2020.077
License No.	069646
<h2>DAY STOKOSA</h2> <p>ENGINEERING P.C.</p>	
3 Van Wyck Lane Suite 2 Wappingers Falls, New York 12590 (845) 223-3202	
<h3>Hudson Valley Lighting</h3> <p>Town of Wappinger Dutchess County, New York</p>	
<h1>Title Sheet</h1>	
SCALE	AS NOTED
DRAWN BY	ALB
DATE	03-09-2020
CHECKED BY	MAD
<h2>TB-1</h2> <p>1 of 8</p>	

Dutchess County Dept. of Health

Owner/Applicant

Hudson Valley Lighting
151 Airport Road
Wappingers Falls, NY 12590

Owner's Consent Note

THE UNDERSIGNED OWNER OF THIS PROPERTY HEREON STATES THAT HE IS FAMILIAR WITH THIS MAP, ITS CONTENTS AND ITS LEGENDS AND HEREBY CONSENTS TO ALL SAID TERMS AND CONDITIONS AS STATED HEREON

Authorized Agent of Hudson Valley Lighting DATE

Town of Wappinger Planning Board

APPROVED BY RESOLUTION OF THE PLANNING BOARD OF THE TOWN OF WAPPINGER, NEW YORK ON THE _____ DAY OF _____, 2020 SUBJECT TO ALL REQUIREMENTS AND CONDITIONS OF SAID RESOLUTION. ANY CHANGE, ERASURE, MODIFICATION OR REVISION OF THIS PLAN, AS APPROVED SHALL VOID THIS APPROVAL.

TOWN OF WAPPINGER PLANNING BOARD

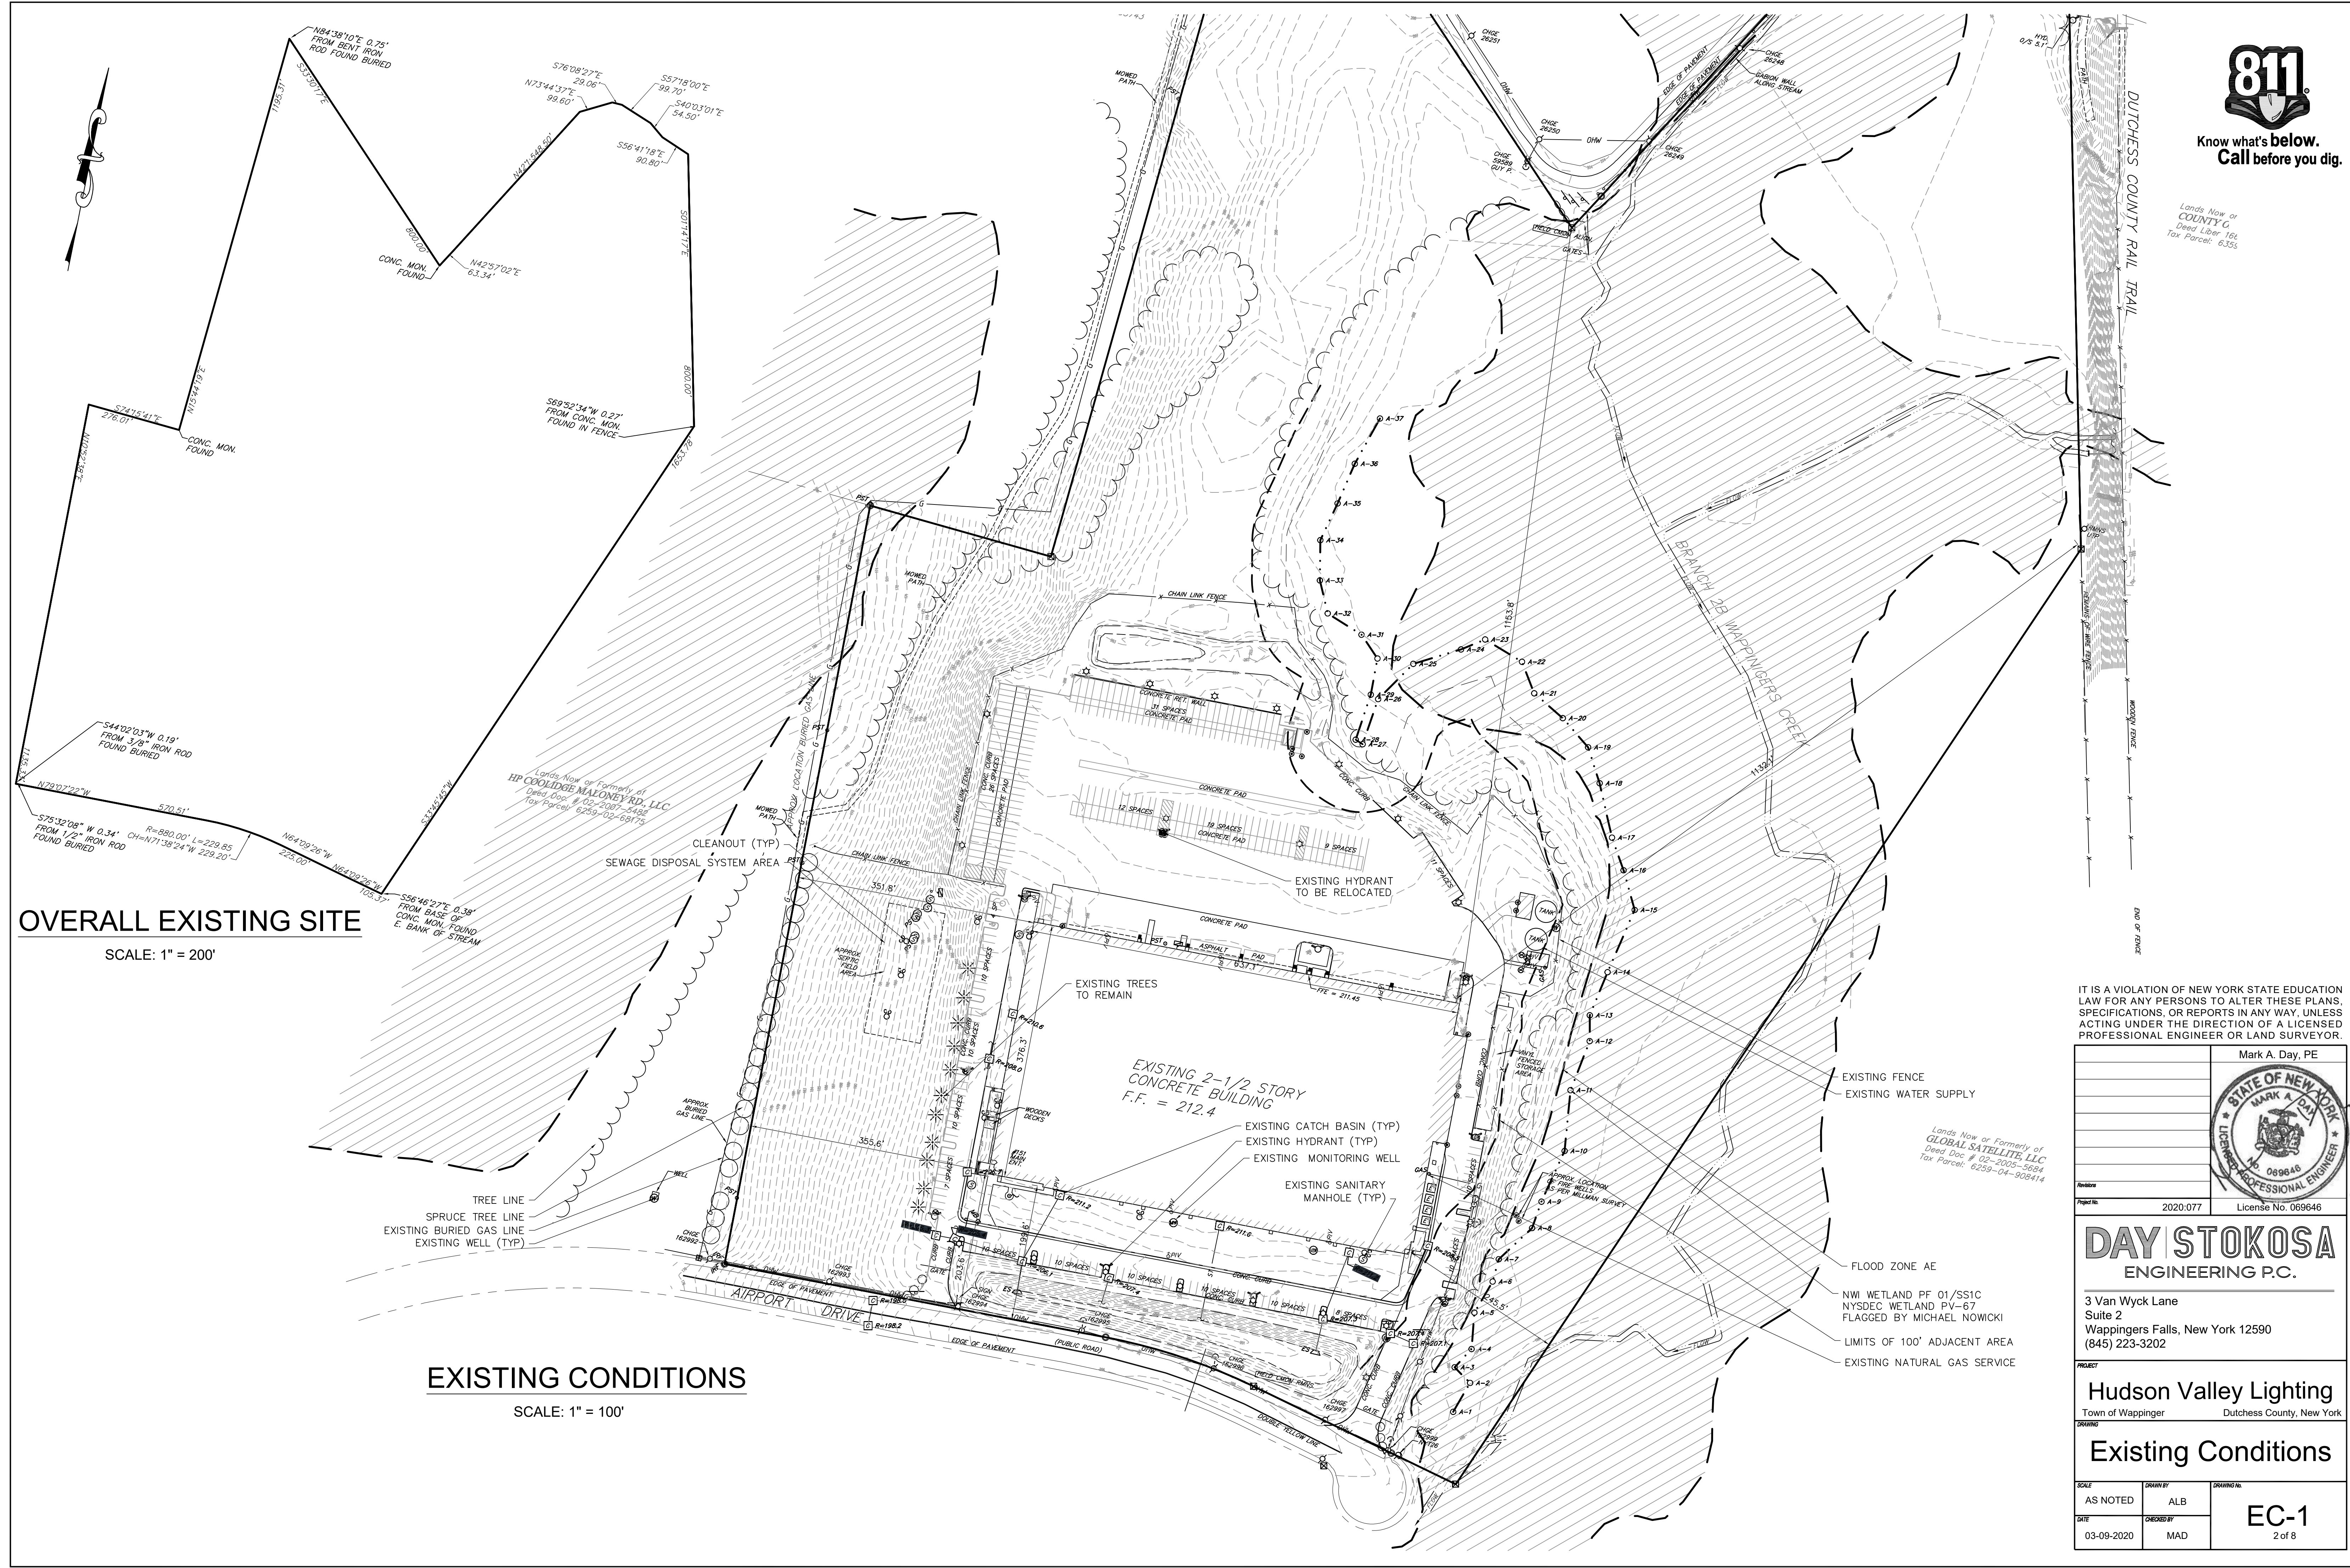
SIGNED THIS _____ DAY OF _____, 2020

Bruce Flower, TOWN OF WAPPINGER PLANNING BOARD CHAIR



Know what's below.
Call before you dig.

Lands Now or
Formerly of
COUNTY G
Deed Liber. 161
Tax Parcel: 6.356



OVERALL EXISTING SITE
SCALE: 1" = 200'

EXISTING CONDITIONS
SCALE: 1" = 100'

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ENGINEERING P.C.

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(845) 223-3202

Hudson Valley Lighting
Town of Wappinger Dutchess County, New York


Existing Conditions		
SCALE	DRAWN BY	DRAWING NO.
AS NOTED	ALB	EC-1
DATE	CHECKED BY	2 of 8
03-09-2020	MAD	

SITE PLAN

SCALE: 1" = 120'



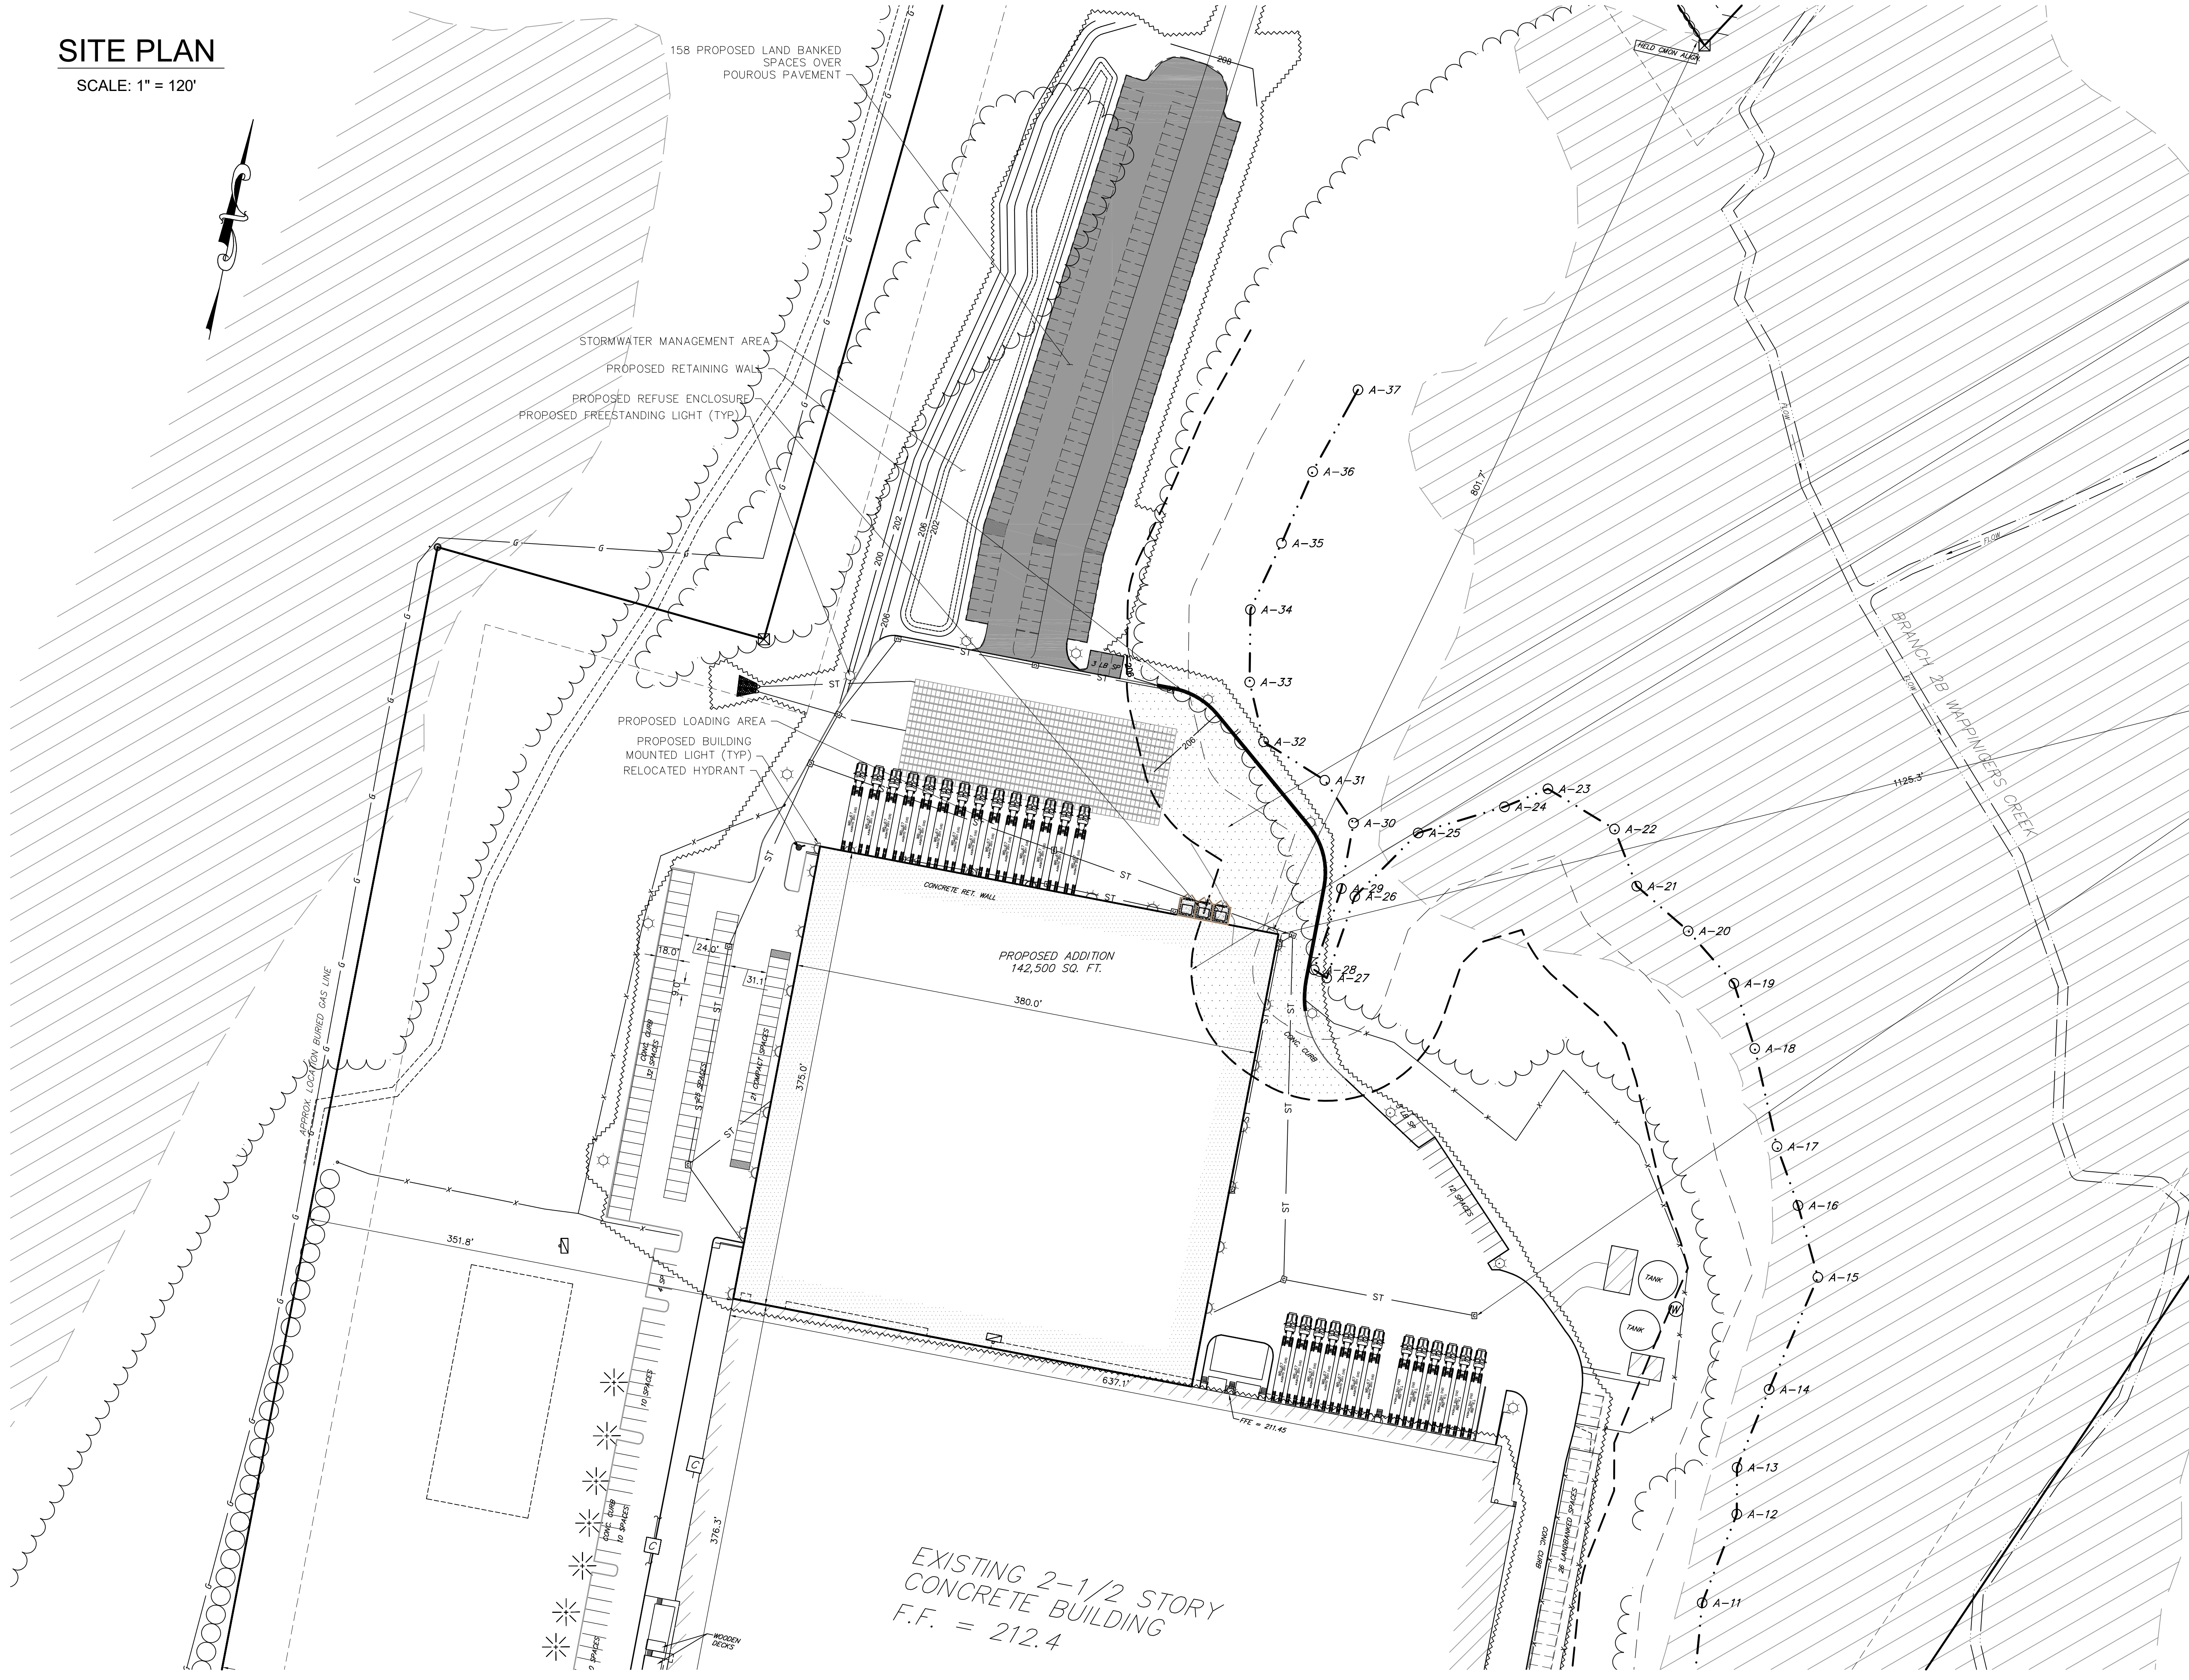Know what's below.
Call before you dig.



158 PROPOSED LAND BANKED SPACES OVER POUROUS PAVEMENT

STORMWATER MANAGEMENT AREA
PROPOSED RETAINING WALL
PROPOSED REFUSE ENCLOSURE
PROPOSED FREESTANDING LIGHT (TYP)

PROPOSED LOADING AREA
PROPOSED BUILDING MOUNTED LIGHT (TYP)
RELOCATED HYDRANT

PROPOSED ADDITION
142,500 SQ. FT.

EXISTING 2-1/2 STORY CONCRETE BUILDING
F.F. = 212.4

PROPOSED ADJACENT AREA DISTURBANCE = 0.82 ACRES

NW WETLAND PF 01/SS1C
NYSDEC WETLAND PV-67
FLAGGED BY MICHAEL NOWICKI

LIMITS OF 100' ADJACENT AREA

PROPOSED STORMWATER CATCH BASIN (TYP)

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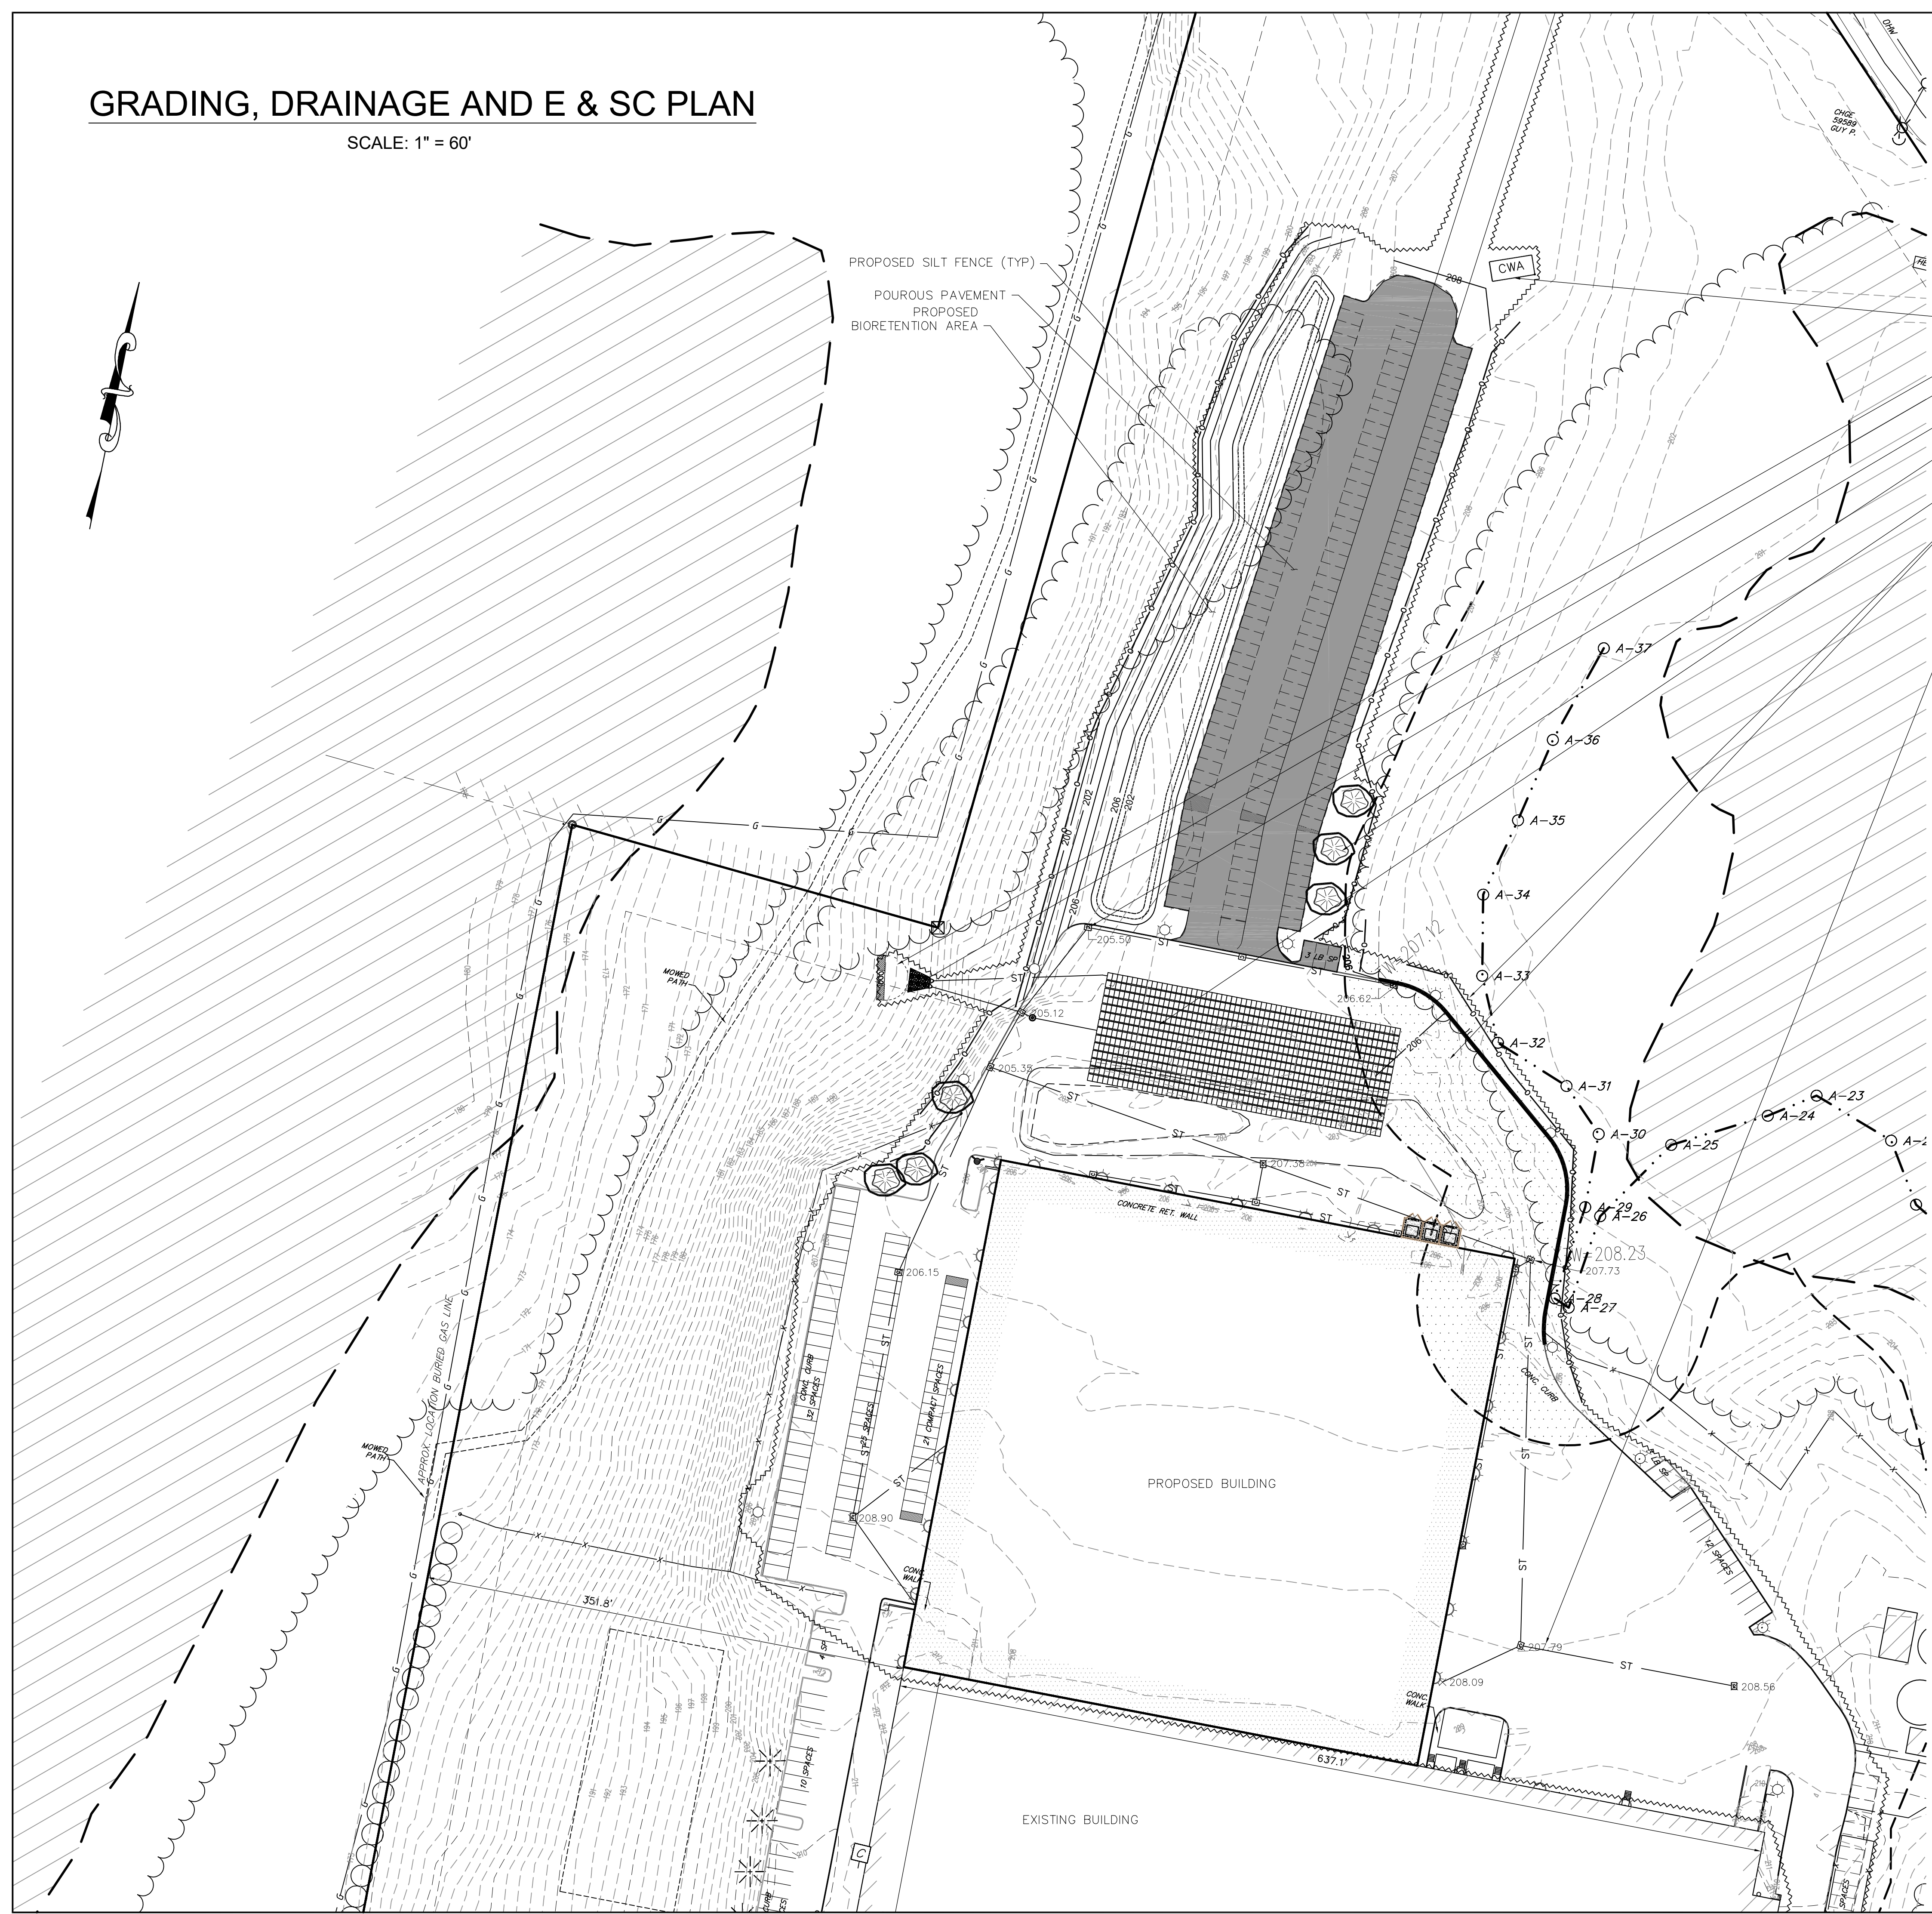
Mark A. Day, PE	
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<h2>DAY STOKOSA</h2> <p>ENGINEERING P.C.</p>	
3 Van Wyck Lane Suite 2 Wappingers Falls, New York 12590 (845) 223-3202	
<p>Hudson Valley Lighting Town of Wappingers Dutchess County, New York</p>	
<h3>Site Plan</h3>	
SCALE	AS NOTED
DRAWN BY	ALB
DATE	03-09-2020
CHECKED BY	MAD
<h2>SP.1</h2> <p>3 of 8</p>	

GRADING, DRAINAGE AND E & SC PLAN

SCALE: 1" = 60'



Know what's below.
Call before you dig.



- PROPOSED CONSTRUCTION ENTRANCE TO BE INSTALLED AT MALONEY ROAD
- CONCRETE WASHOUT
- PROPOSED TEMP. SEDIMENT TRAP (TYP)
- PROPOSED FLARED END SECTION TO RIPRAP
- PROPOSED CATCH BASIN (TYP)
- SOIL STOCKPILE (TYP)
- PROPOSED INFILTRATORS
- LIMIT OF DISTURBANCE - 10.6 ACRES
(0.82 ACRES OF WHICH ARE IN ADJACENT AREA - DEPICTED WITH HATCHING)
- PROPOSED SPOT ELEVATION (TYP)

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Town of Wappinger, Dutchess County, New York


**Grading, Drainage
Erosion & Sediment Control Plan**

SCALE	AS NOTED	DRAWN BY	ALB	DATE	03-09-2020	CHECKED BY	MAD	PROJECT NO.	GD.1	SHEET NO.	5 of 8
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Know what's below.
Call before you dig.

RSX Area Luminaire Size 2 P1 Lumen Package 3000K CCT Type R3S Distribution with EGVF Shield



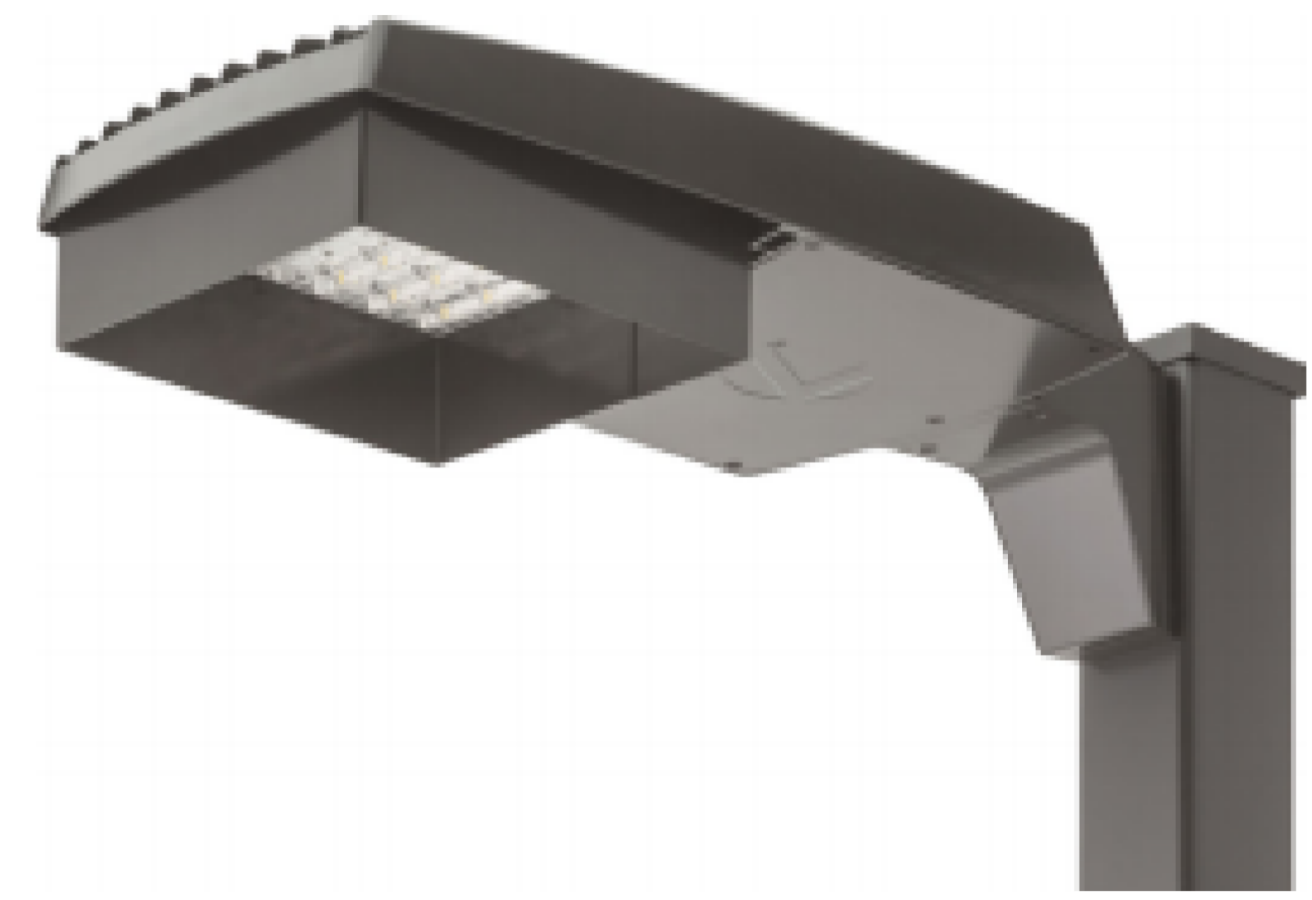
External 360 Full Visor

2 LITHONIA RSX2 LED AREA LUMINAIRE WITH FULL VISOR - MOUNTING HEIGHT 18'
LP.1 SCALE: NOT TO SCALE




12"Wx8.79"Hx12.5"D
21.5 LBS
Design is Protected
by U.S. Patent No.
D740,997 and D752,274

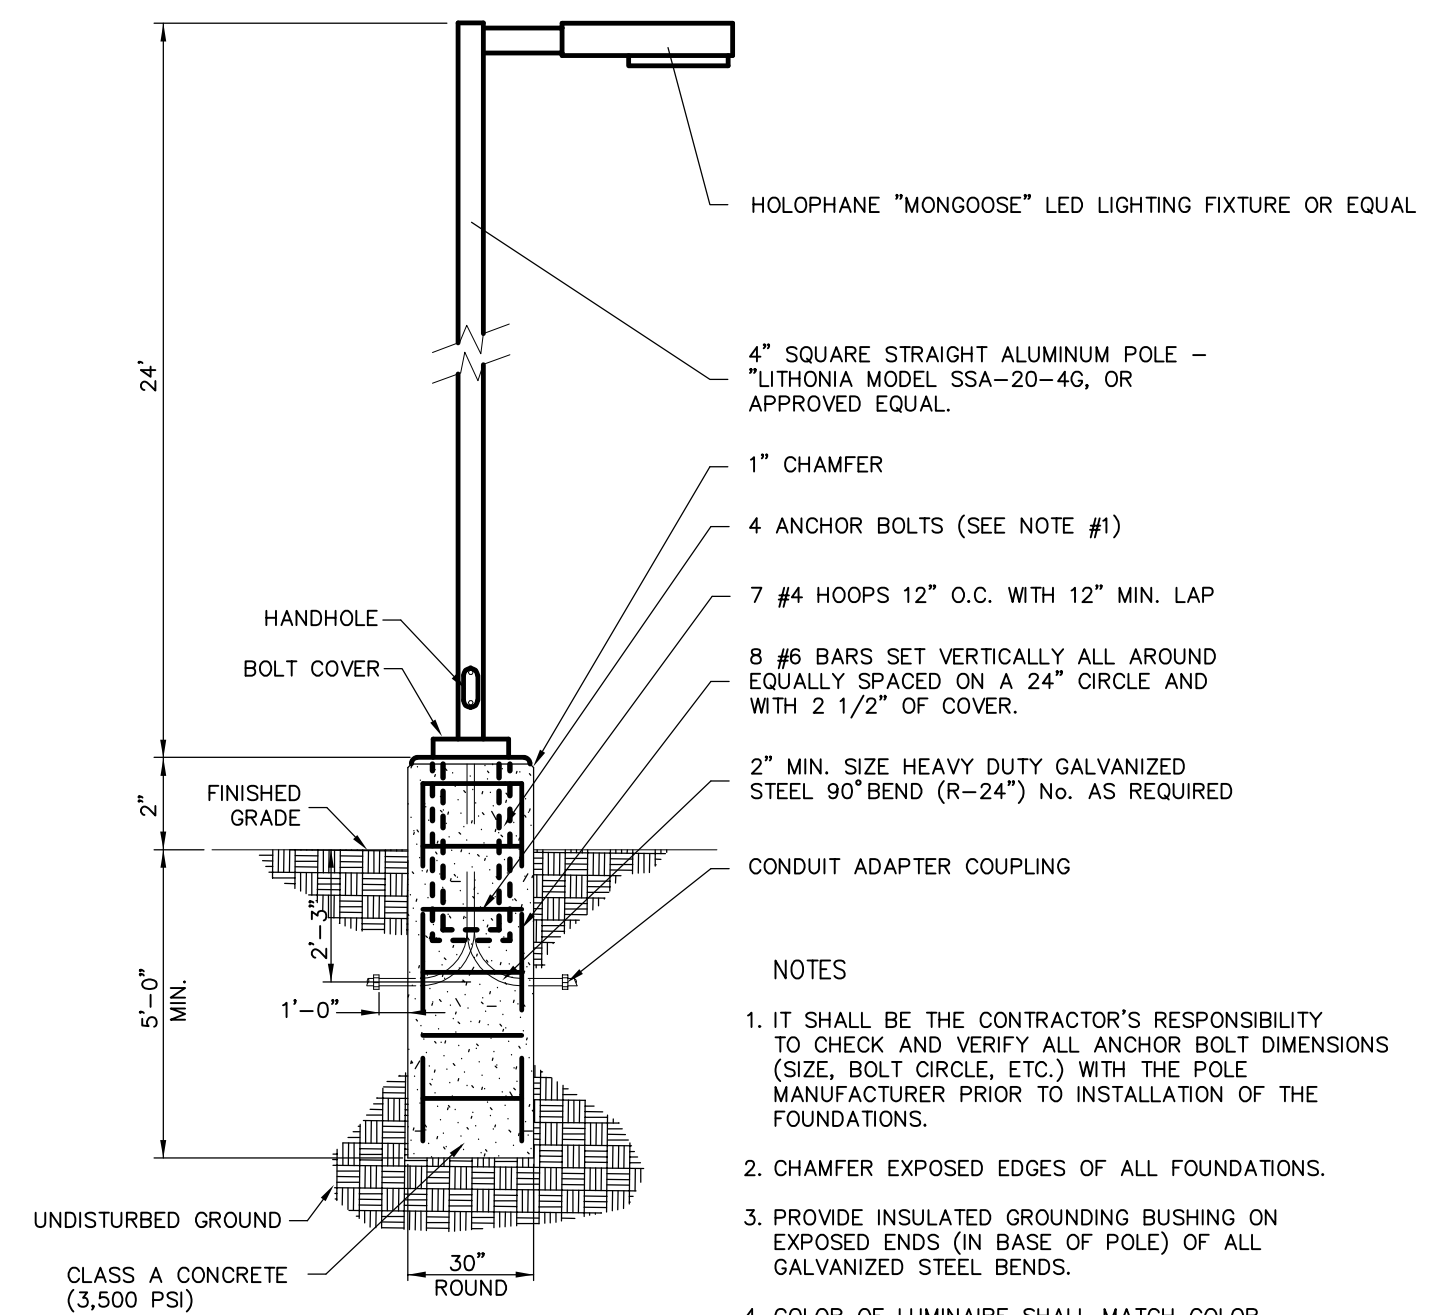3 WALLPACK LIGHTING DETAIL
LP.1 SCALE: N.T.S.



4 LIGHT POLE DETAIL
LP.1 SCALE: N.T.S.
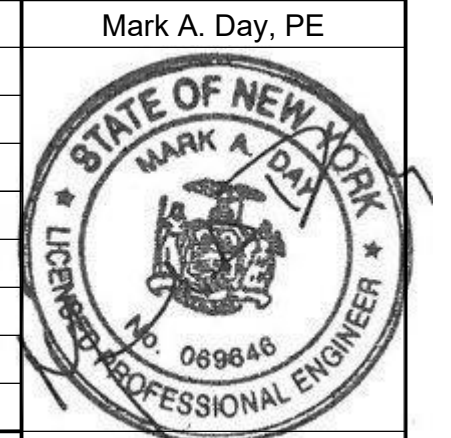
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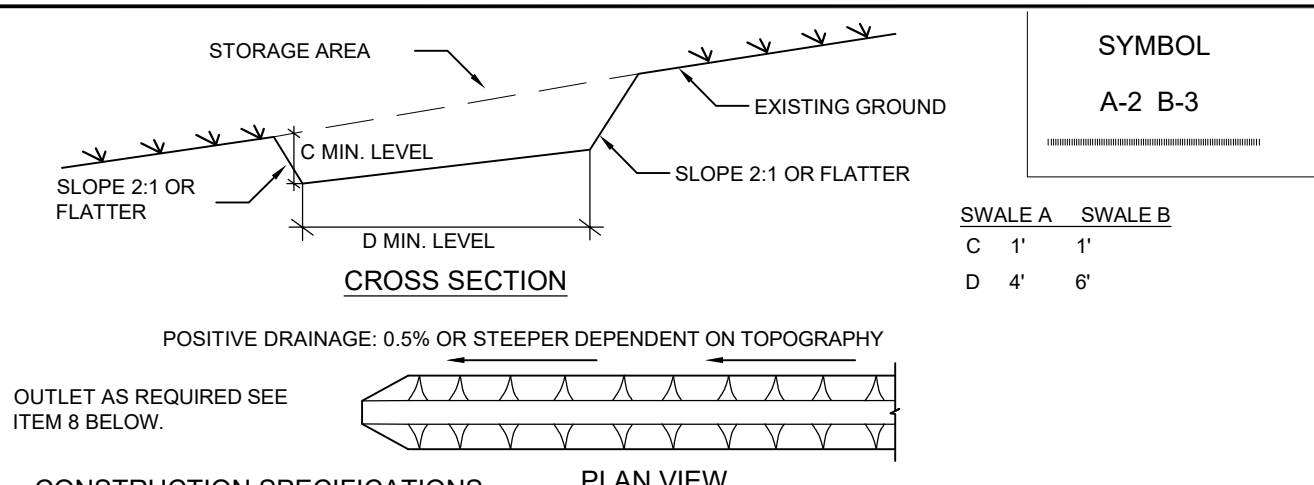
Lighting Plan

SCALE	AS NOTED	DRAWN BY	ALB	CHECKED BY	MAD	DATE	03-09-2020
DATE	03-09-2020	DATE	03-09-2020	DATE	03-09-2020	DATE	03-09-2020


LP.1
6 of 8

LUMINAIRE SCHEDULE							
CALLOUT	SYMBOL	LAMP	DESCRIPTION	BALLAST	MOUNTING	MODEL	QUANTITY
Pole	☼	(1)	HOLOPHANE AREA LUMINAIRE WITH Baffle	ELECTRONIC	26" HIGH POLE	HOLOPHANE LED	13 NEW (4) EXISTING
WALLPAK	☼	(1)	CAST ENAMEL ALUMINUM HOUSING WHITE ALUMINUM REFLECTOR CLEAR GLASS ENCLOSURE	ELECTRONIC	14" HIGH WALL-MOUNTED	ATLAS SLP16110LEDSC4KU	28

PROPOSED LIGHT POLE
PROPOSED WALL PACK




- CONSTRUCTION SPECIFICATIONS**
1. ALL TEMPORARY SWALES SHALL HAVE UNINTERRUPTED POSITIVE GRADE TO AN OUTLET.
 2. DIVERTED RUNOFF FROM A DISTURBED AREA SHALL BE CONVEYED TO A SEDIMENT TRAPPING DEVICE.
 3. DIVERTED RUNOFF FROM AN UNDISTURBED AREA SHALL OUTLET DIRECTLY INTO AN UNDISTURBED STABILIZED AREA AT NON-EROSIVE VELOCITY.
 4. ALL TREES, BRUSH, STUMPS, OBSTRUCTIONS, AND OTHER OBJECTIONABLE MATERIAL SHALL BE REMOVED AND DISPOSED OF SO AS NOT TO INTERFERE WITH THE PROPER FUNCTIONING OF THE SWALE.
 5. THE SWALE SHALL BE EXCAVATED OR SHAPED TO LINE, GRADE, AND CROSS SECTION AS REQUIRED TO MEET THE CRITERIA SPECIFIED HEREIN AND BE FREE OF BANK PROJECTIONS OR OTHER IRREGULARITIES WHICH WILL IMPEDE NORMAL FLOW.
 6. FILLS SHALL BE COMPACTED BY EARTH MOVING EQUIPMENT.
 7. ALL EARTH REMOVED AND NOT NEEDED FOR CONSTRUCTION SHALL BE PLACED SO THAT IT WILL NOT INTERFERE WITH THE FUNCTIONING OF THE SWALE.
 8. STABILIZATION SHALL BE AS PER THE FLOW CHANNEL STABILIZATION CHART BELOW.
- | TYPE OF TREATMENT | CHANNEL GRADE | AG AC. OR LESS | B/S AC. (10-AC) |
|-------------------|---------------|----------------------------------|---|
| 1 | 0.5-3.0% | SEED AND STRAW MULCH | SEED AND STRAW MULCH |
| 2 | 3.1-5.0% | SEED AND STRAW MULCH | SEED USING JUTE OR EXCELSIOR |
| 3 | 5.1-8.0% | SEED WITH JUTE OR EXCELSIOR, SOD | LINED WITH 4-8" RIP-RAP OR RECYCLED CONCRETE EQUIVALENT |
| 4 | 8.1-20.1% | LINED WITH 4-8" RIP-RAP | ENGINEERED DESIGN |
9. PERIODIC INSPECTION AND REQUIRED MAINTENANCE MUST BE PROVIDED AFTER EACH RAIN EVENT.

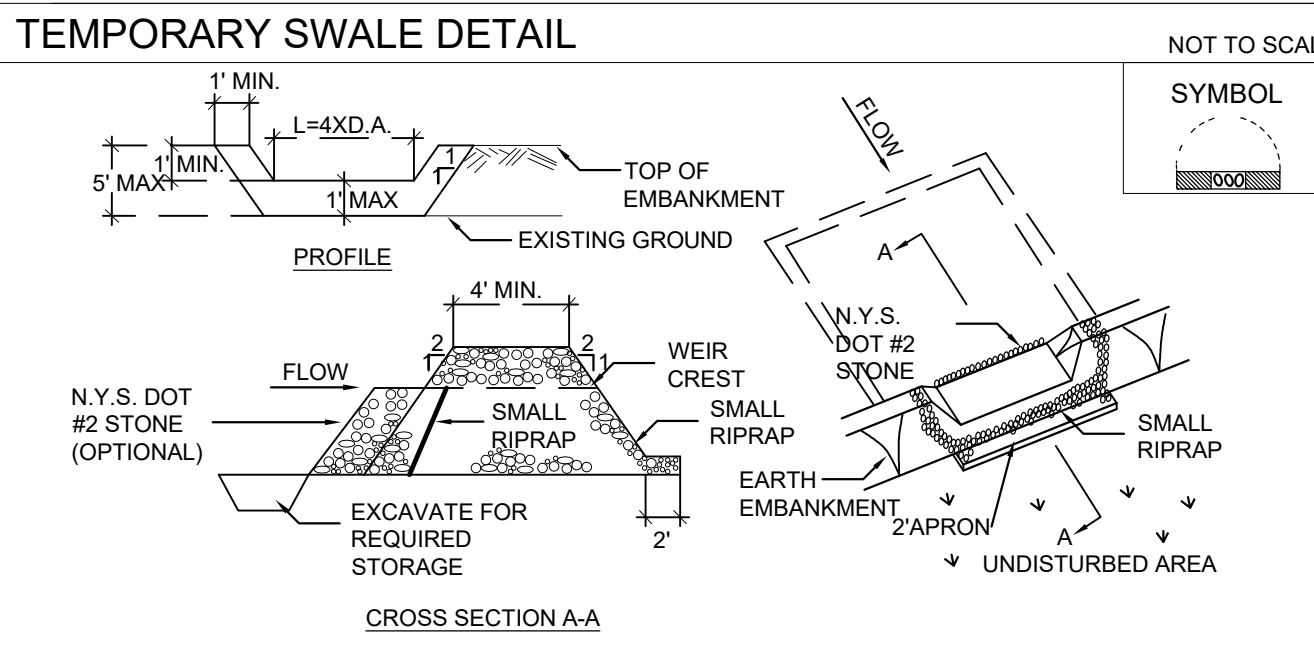


- CONSTRUCTION SPECIFICATIONS**
1. AREA UNDER EMBANKMENT SHALL BE CLEARED, GRUBBED AND STRIPPED OF ANY VEGETATION AND ROOT MAT. THE POOL AREA SHALL BE CLEARED.
 2. THE FILL MATERIAL FOR THE EMBANKMENT SHALL BE FREE OF ROOTS AND OTHER WOODY VEGETATION AS WELL AS OVER-SIZED STONES, ROCKS, ORGANIC MATERIAL OR OTHER OBJECTIONABLE MATERIAL. THE EMBANKMENT SHALL BE COMPACTED BY TRAVELING WITH EQUIPMENT WHILE IT IS BEING CONSTRUCTED.
 3. ALL CUT AND FILL SLOPES SHALL BE 2:1 OR FLATTER.
 4. THE STONE USED IN THE OUTLET SHALL BE SMALL RIPRAP 4"-8" ALONG WITH A 1" THICKNESS OF 2" AGGREGATE PLACED ON THE UP-GRADE SIDE ON THE SMALL RIPRAP OR EMBEDDED FILTER CLOTH IN THE RIPRAP.
 5. SEDIMENT SHALL BE REMOVED AND TRAP RESTORED TO ITS ORIGINAL DIMENSIONS WHEN THE SEDIMENT HAS ACCUMULATED TO 1/2 THE DESIGN DEPTH OF THE TRAP.
 6. THE STRUCTURE SHALL BE INSPECTED AFTER EACH RAIN AND REPAIRS MADE AS NEEDED.
 7. CONSTRUCTION OPERATIONS SHALL BE CARRIED OUT IN SUCH A MANNER THAT EROSION AND WATER POLLUTION IS MINIMIZED.
 8. THE STRUCTURE SHALL BE REMOVED AND THE AREA STABILIZED WHEN THE DRAINAGE AREA HAS BEEN PROPERLY STABILIZED.
- MAXIMUM DRAINAGE AREA 5 ACRES

- SEEDING NOTES:**
- 1) EXPOSED SLOPES AND ALL GRADED AREAS SHALL BE SEEDING WITH THE FOLLOWING GRASS SEED MIX AS REQUIRED:
STEEP SLOPES (3:1)
TEMPORARY SEEDING:
SUMMER SEASON - GERMAN MILLET @ 40 LBS PER ACRE
WINTER SEASON - RYE GRASS @ 120 LBS PER ACRE
PERMANENT SEEDING - SPRING/FALL
TALL FESCUE @ 100 LBS PER ACRE
KOBLE LESPREZEA @ 10 LBS PER ACRE
BAHIA GRASS @ 25 LBS PER ACRE
RYE GRASS @ 40 LBS PER ACRE
4) GRASS SEED MIX MAY BE APPLIED BY EITHER MECHANICAL OR HYDROSEEDING METHODS. HYDROSEEDING SHALL BE PERFORMED IN ACCORDANCE WITH THE CURRENT EDITION OF N.Y. STANDARDS AND SPECIFICATIONS FOR EROSION AND SEDIMENT CONTROL.
5) SEEDING AREAS SHALL BE MULCHED AS REQUIRED:
MID-SUMMER, LATE FALL OR WINTER
APPLY AT A RATE OF 100 LBS/1,000 SQ. FT. GRAIN STRAW, COVER WITH NETTING AND STAPLE TO THE SLOPE.
SPRING OR EARLY FALL
APPLY AT A RATE OF 45 LBS/1,000 SQ. FT. WOOD FIBER IN A HYDRO SEEDER SLURRY.

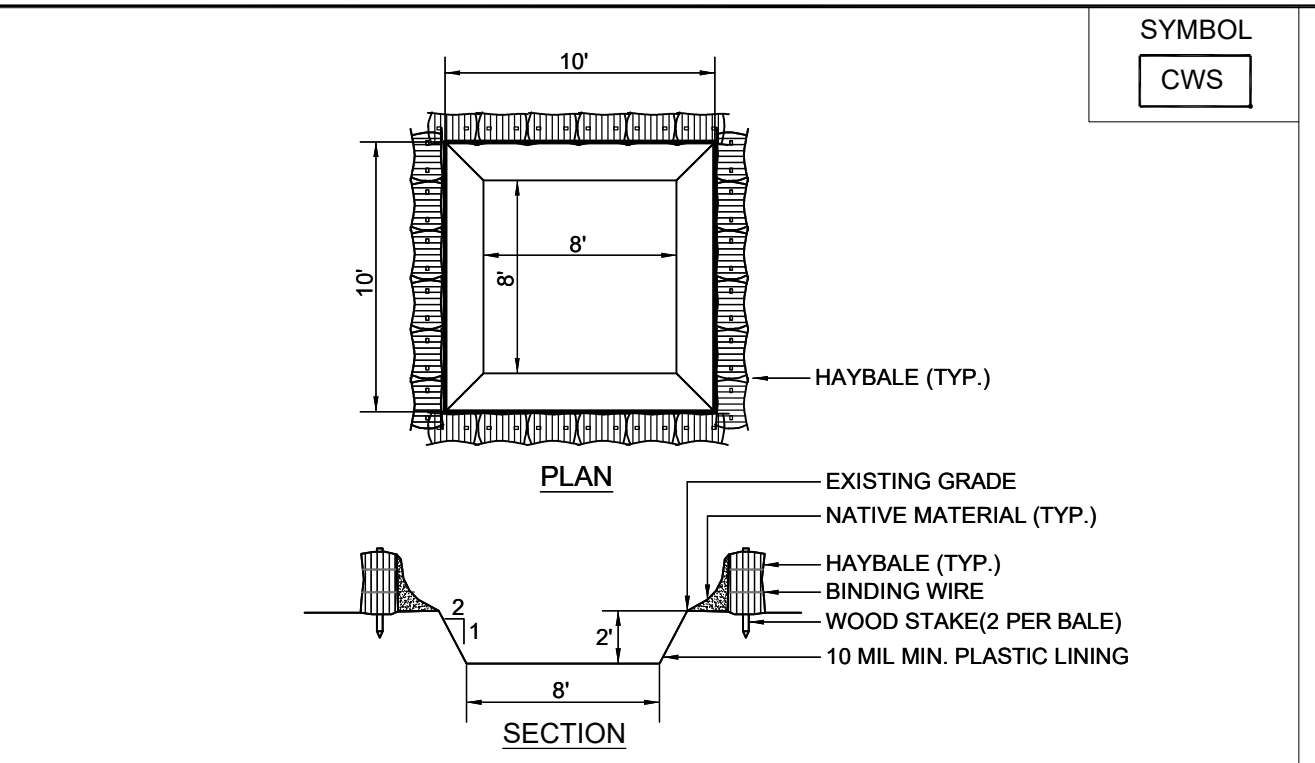- DESCRIPTION OF EROSION CONTROL PRACTICES**
- TEMPORARY SWALE** - A TEMPORARY EXCAVATED DRAINAGE WAY. THE PURPOSE OF A TEMPORARY SWALE IS TO PREVENT RUNOFF FROM ENTERED DISTURBANCE AREAS BY INTERCEPTING AND DIVERTING IT TO A STABILIZED OUTLET OR TO INTERCEPT SEDIMENT LADEN WATER AND DIVERT IT TO A SEDIMENT TRAPPING DEVICE.
- SILT FENCE** - A TEMPORARY BARRIER OF GEOTEXTILE FABRIC (FILTER CLOTH) USED TO INTERCEPT SEDIMENT LADEN RUNOFF FROM SMALL DRAINAGE AREAS OF DISTURBED SOIL. THE PURPOSE OF A SILT FENCE IS TO REDUCE RUNOFF VELOCITY AND EFFECT DEPOSITION OF TRANSPORTED SEDIMENT LOAD. LIMITS IMPOSED BY ULTRAVIOLET STABILITY OF THE FABRIC WILL DICTATE THE MAXIMUM PERIOD THE SILT FENCE MAY BE USED.
- CHECK DAM** - SMALL TEMPORARY STONE DAMS CONSTRUCTED ACROSS A DRAINAGE WAY. THE PURPOSE IS TO REDUCE EROSION IN A DRAINAGE CHANNEL BY RESTRICTING THE VELOCITY OF FLOW IN THE CHANNEL.
- STABILIZED CONSTRUCTION ENTRANCE** - A STABILIZED PAD OF AGGREGATE UNDERLAIN WITH FILTER CLOTH LOCATED AT ANY POINT WHERE TRAFFIC WILL BE ENTERING OR LEAVING A CONSTRUCTION SITE TO OR FROM A PUBLIC RIGHT OF WAY, STREET ALLEY, SIDEWALK OR PARKING. THE PURPOSE OF A STABILIZED CONSTRUCTION ENTRANCE IS TO REDUCE OR ELIMINATE THE TRACKING OF SEDIMENT ONTO PUBLIC RIGHTS-OF-WAY OR STREETS.
- DUST CONTROL** - THE CONTROL OF DUST RESULTING FROM LAND-DISTURBING ACTIVITIES. THE PURPOSE IS TO PREVENT SURFACE AND AIR MOVEMENT OF DUST FROM DISTURBED SOIL SURFACES THAT MAY CAUSE OFF-SITE DAMAGE, HEALTH HAZARDS, AND TRAFFIC SAFETY PROBLEMS.
- ROCK OUTLET PROTECTION** - A SECTION OF ROCK PROTECTION PLACED AT THE OUTLET AND OF THE CULVERTS, CONDUITS, OR CHANNELS. THE PURPOSE OF THE ROCK OUTLET PROTECTION IS TO REDUCE THE DEPTH, VELOCITY, AND ENERGY OF THE WATER, SUCH THAT THE FLOW WILL NOT ERODE THE RECEIVING DOWNSTREAM REACH. SEE EROSION CONTROL PLAN FOR FURTHER DETAIL.



- CONSTRUCTION SPECIFICATIONS**
- 1) THE LINER SHALL BE PLASTIC SHEETING WITH A MINIMUM THICKNESS OF 10 MILS WITH NO HOLES OR TEARS, AND ANCHORED BEYOND THE TOP OF THE PIT WITH AN EARTHEN BERM, SAND BAGS, STONE, OR OTHER STRUCTURAL APURTANCE EXCEPT AT THE ACCESS POINT.
 - 2) LOCATE THE FACILITY A MINIMUM OF 100 FEET FROM DRAINAGE SWALES, STORM DRAIN INLETS, WETLANDS, STREAMS AND OTHER SURFACE WATERS. PREVENT SURFACE WATER FROM ENTERING THE STRUCTURE EXCEPT FOR THE ACCESS ROAD. PROVIDE APPROPRIATE ACCESS WITH A GRAVEL ACCESS ROAD SLOPED DOWN TO THE STRUCTURE. SIGNS SHALL BE PLACED TO DIRECT DRIVERS TO THE FACILITY AFTER THEIR LOAD IS DISCHARGED.
 - 3) ALL CONCRETE WASHOUT FACILITIES SHALL BE INSPECTED DAILY. DAMAGED OR LEAKING FACILITIES SHALL BE DEACTIVATED AND REPAIRED OR REPLACED IMMEDIATELY. EXCESS RAINWATER THAT HAS ACCUMULATED OVER HARDENED CONCRETE SHOULD BE PUMPED TO A STABILIZED AREA, SUCH AS A GRASS FILTER STRIP.
 - 4) ACCUMULATED HARDENED MATERIAL SHALL BE REMOVED WHEN 75% OF THE STORAGE CAPACITY OF THE STRUCTURE IS FILLED. ANY EXCESS WASH WATER SHALL BE PUMPED INTO A CONTAINMENT POND, AND PROPERLY DISPOSED OF OFF SITE.
 - 5) DISPOSE OF THE HARDENED MATERIAL OFF-SITE IN A CONSTRUCTION/DEMOLITION LANDFILL. ON-SITE DISPOSAL MAY BE ALLOWED IF THIS HAS BEEN APPROVED AND ACCEPTED AS PART OF THE PROJECT'S SWPPP. IN THAT CASE, THE MATERIAL SHOULD BE RECYCLED AS SPECIFIED, OR BURIED AND COVERED WITH A MINIMUM OF 2 FEET OF CLEAN COMPACTED EARTH/FILL THAT IS PERMANENTLY STABILIZED TO PREVENT EROSION.
 - 6) THE PLASTIC LINER SHALL BE REPLACED WITH EACH CLEANING OF THE WASHOUT FACILITY.
 - 7) INSPECT THE PROJECT SITE FREQUENTLY TO ENSURE THAT NO CONCRETE DISCHARGES ARE TAKING PLACE IN NON-DESIGNATED AREAS.

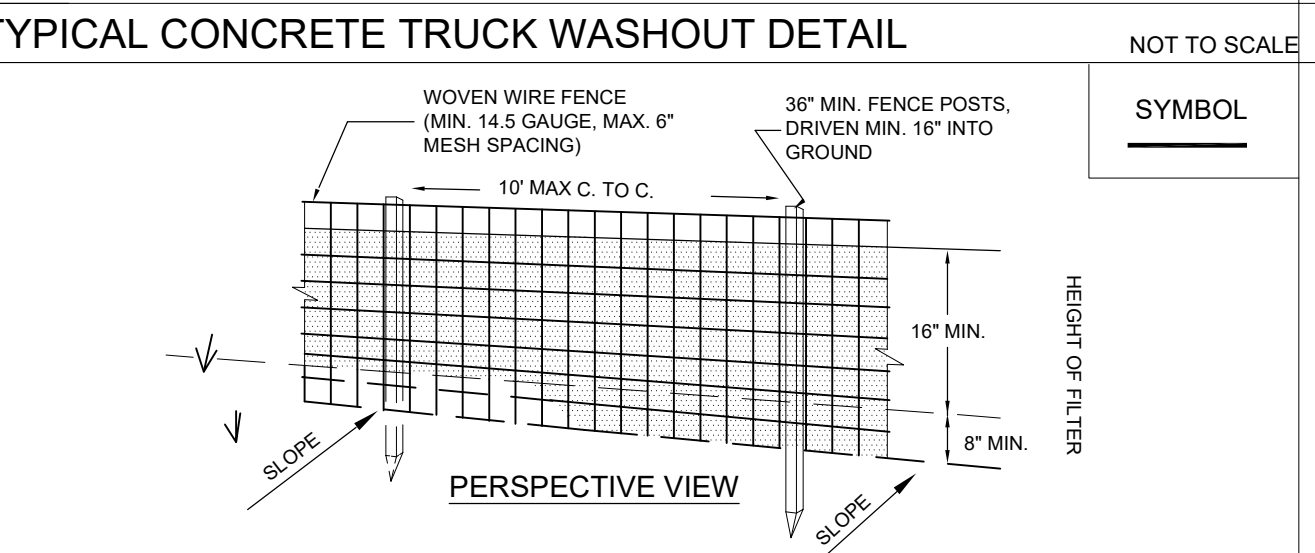

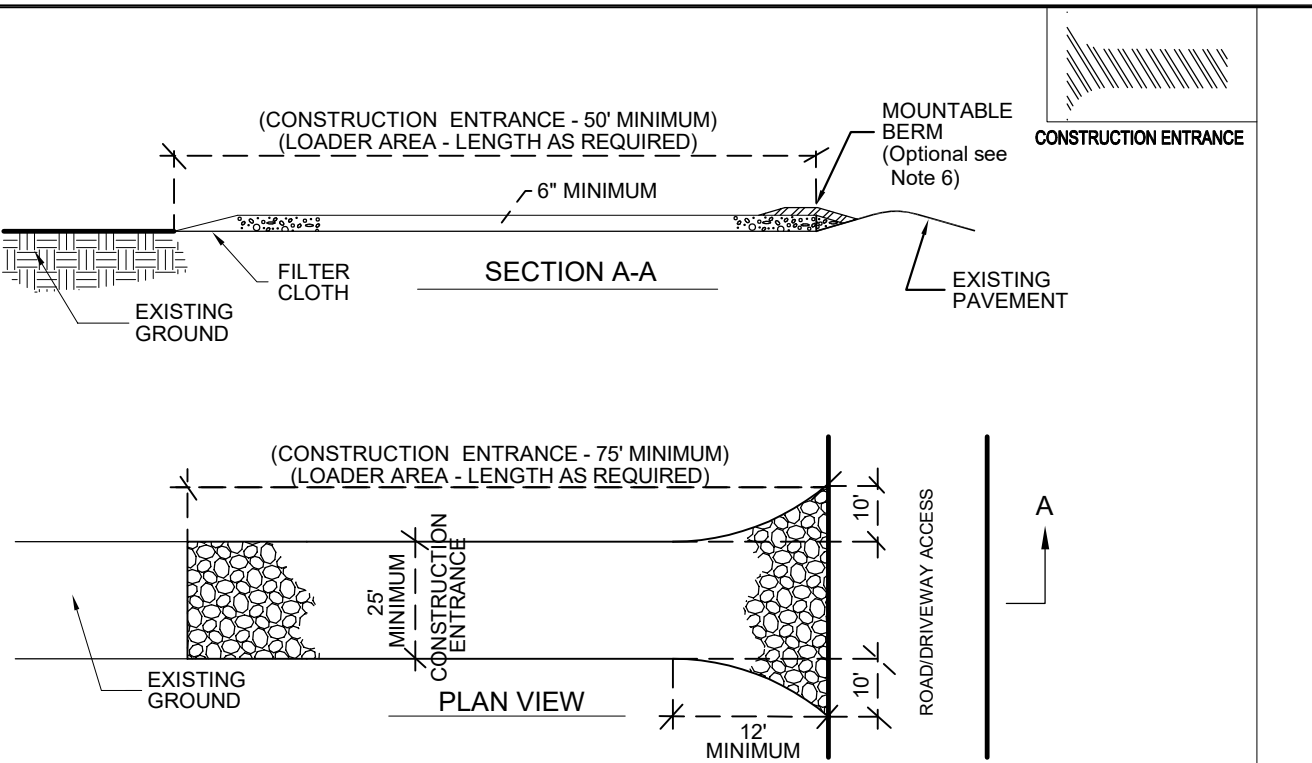
- CONSTRUCTION SPECIFICATIONS**
- 1) STONE SIZE - USE 2" MIN. STONE, OR RECLAIMED OR RECYCLED CONCRETE EQUIVALENT.
 - 2) LENGTH - AS REQUIRED, BUT NOT LESS THAN 50 FEET.
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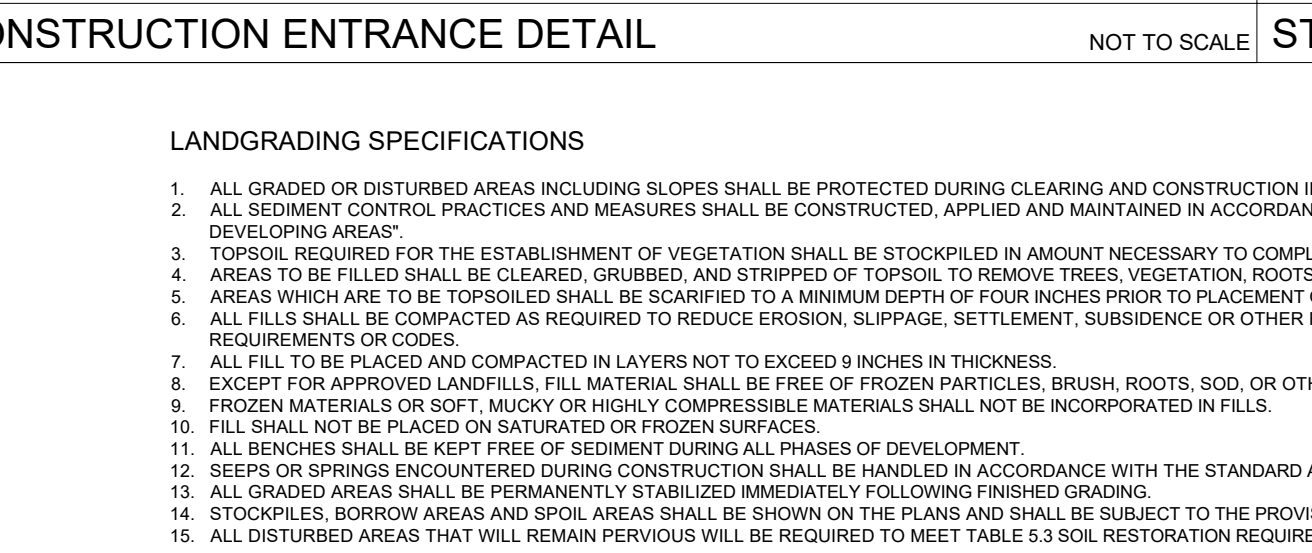
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- 1) AREA UNDER EMBANKMENT SHALL BE CLEARED, GRUBBED AND STRIPPED OF ANY VEGETATION AND ROOT MAT. THE POOL AREA SHALL BE CLEARED.
 2. THE FILL MATERIAL FOR THE EMBANKMENT SHALL BE FREE OF ROOTS AND OTHER WOODY VEGETATION AS WELL AS OVER-SIZED STONES, ROCKS, ORGANIC MATERIAL OR OTHER OBJECTIONABLE MATERIAL. THE EMBANKMENT SHALL BE COMPACTED BY TRAVELING WITH EQUIPMENT WHILE IT IS BEING CONSTRUCTED.
 3. ALL CUT AND FILL SLOPES SHALL BE 2:1 OR FLATTER.
 4. THE STONE USED IN THE OUTLET SHALL BE SMALL RIPRAP 4"-8" ALONG WITH A 1" THICKNESS OF 2" AGGREGATE PLACED ON THE UP-GRADE SIDE ON THE SMALL RIPRAP OR EMBEDDED FILTER CLOTH IN THE RIPRAP.
 5. SEDIMENT SHALL BE REMOVED AND TRAP RESTORED TO ITS ORIGINAL DIMENSIONS WHEN THE SEDIMENT HAS ACCUMULATED TO 1/2 THE DESIGN DEPTH OF THE TRAP.
 6. THE STRUCTURE SHALL BE INSPECTED AFTER EACH RAIN AND REPAIRS MADE AS NEEDED.
 7. CONSTRUCTION OPERATIONS SHALL BE CARRIED OUT IN SUCH A MANNER THAT EROSION AND WATER POLLUTION IS MINIMIZED.
 8. THE STRUCTURE SHALL BE REMOVED AND THE AREA STABILIZED WHEN THE DRAINAGE AREA HAS BEEN PROPERLY STABILIZED.



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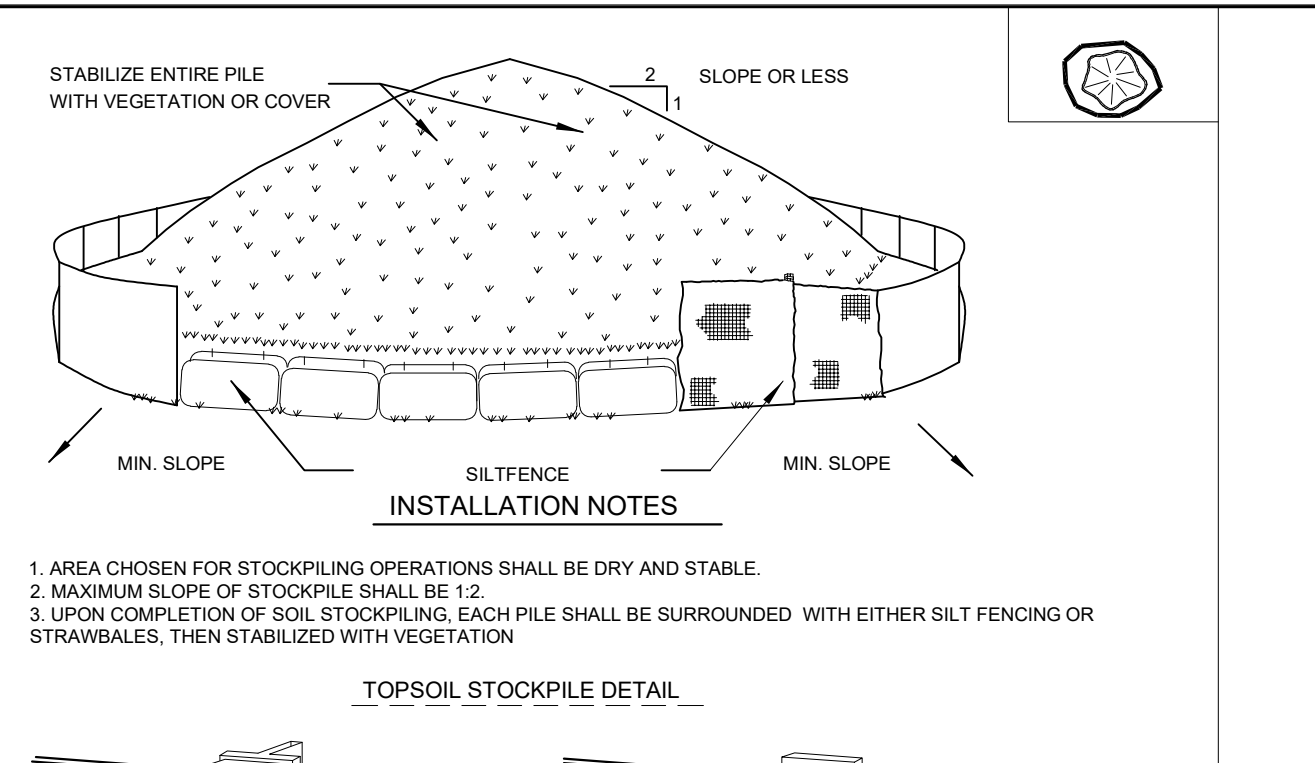
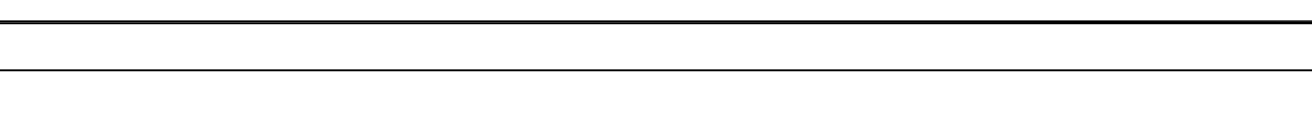
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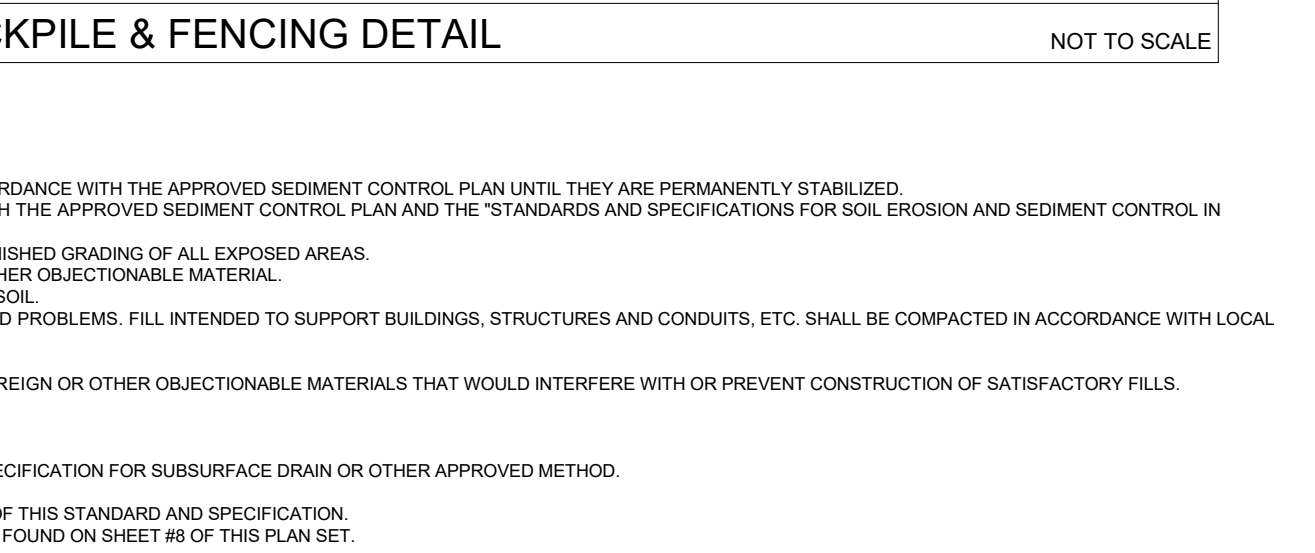
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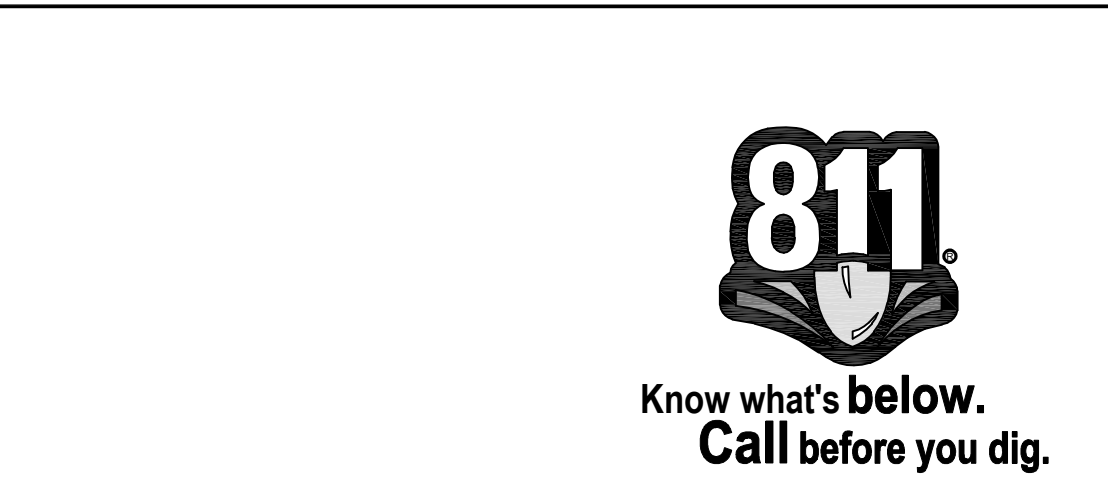
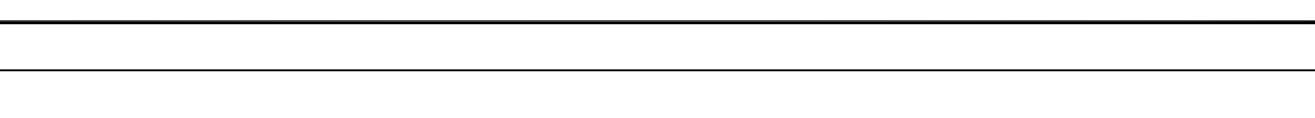
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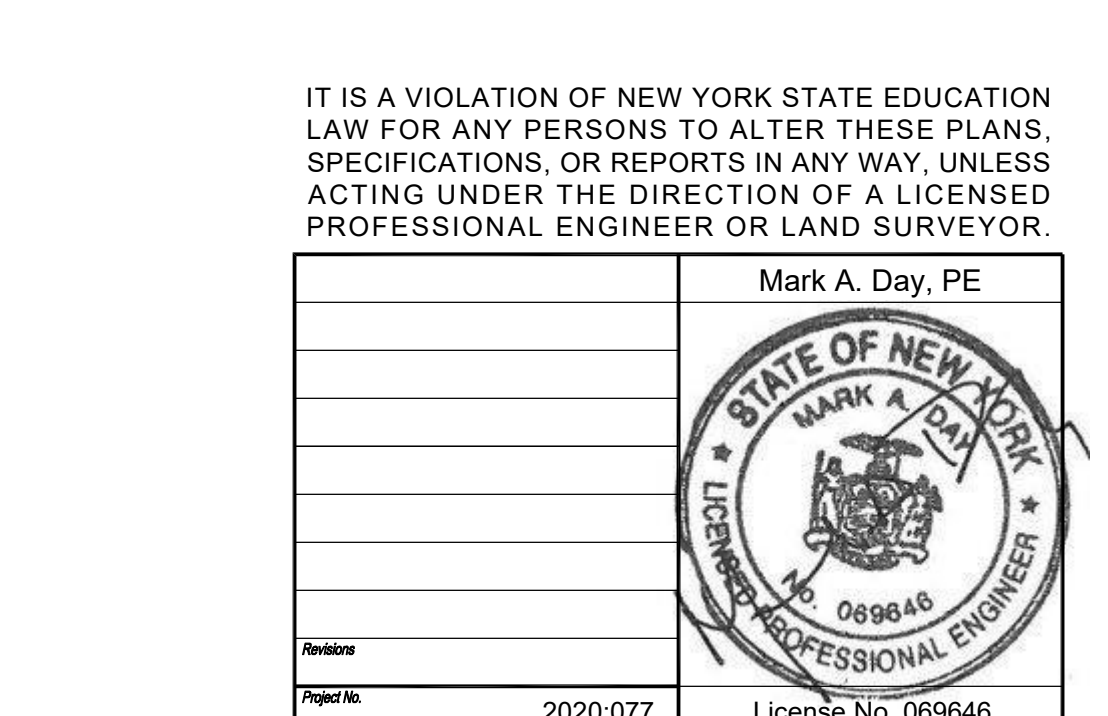
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