# Young Sommer LC

#### ATTORNEYS AT LAW

EXECUTIVE WOODS, FIVE PALISADES DRIVE, ALBANY, NY 12205 Phone: 518-438-9907 • Fax: 518-438-9914

www.youngsommer.com

Writer's Telephone Extension: 258 solson@youngsommer.com

May 16, 2023

### Via Federal Express

Barbara Roberti, Zoning Administrator Town of Wappinger 20 Middlebush Rd Wappinger Falls, New York 12590-0324

RE: Verizon Wireless "Diddell Rd" Communications Facility Off Diddell Road (Tax Map No. 6359-01-480600)

Dear Ms. Roberti:

Enclosed please find eighteen (18) copies of Tectonic Engineering's letter dated May 11, 2023 in response to the April 6, 2023 CPLR letter in connection with the above-referenced application.

Please kindly schedule this application for the next available Planning Board meeting. Should you have any questions, please do not hesitate to contact us.

Very truly yours, YOUNG SOMMER, LLC

Scott Olson

Enclosure

C: Bryan Sarchi (Airosmith Development)



Town of Wappinger Town Hall 20 Middlebush Road Wappingers Falls, NY 12590

May 11, 2023

RE: Verizon Wireless of the East LP d/b/a Verizon Wireless Application "Diddell Rd"

Tax ID: 6359-01-480600 (Dutchess County)

Diddell Road, Wappingers, Dutchess County, New York

Tectonic WO: 11272.014A

### Dear Planning Board Members:

This letter is provided in response to the comments raised in the April 6, 2023 memorandum prepared by Jon Bodendorf, P.E. of CPL. We offer the following responses on behalf of the applicant, Verizon Wireless, to the comments presented in said memorandum.

#### **PLANS**

1. Show erosion control for underground electric and fiber trenching next to existing drive.

RESPONSE: Utility trenches will be backfilled as conduits are installed, using the spoils from the trench as backfill. Erosion control will be achieved by seeding and covering the exposed 2' wide trench with straw or hay. This has been noted on Sheet C-1A of the plan set.

2. The limit of disturbance should include the disturbance of the underground power and fiber lines all the way to Diddell Road.

RESPONSE: This has been addressed on Sheet C-1B of the plans along with the EAF, pages 3 and 9.

3. An easement for access to the tower site will likely be required. Provide easement maps and descriptions. If the fenced compound will be leased as opposed to owned by Verizon the area of the fenced compound should be included in the easement.

### **Project Contact Info**



RESPONSE: Easements and lease area related to the tower facility are shown and noted on Sheet AD-1 and C-1A of the plan set.

4. Erosion control matting on the side slope of the driveway fill sections should be provided.

RESPONSE: Based on the very small amount of grading required (finished grade is close to existing grade) to construct the new driveway it's likely slope stabilization will not be required. The plans have been updated to note rip rap side slopes on both sides of the driveway. See Sheet C-1B with detail on Sheet C-4C.

5. A stabilized construction entrance should be provided at the existing drive at Diddell Road.

RESPONSE: Comment addressed. See Sheet C-1A.

6. The first 25' of the existing driveway should be paved. All of the proposed driveway should be paved as the grade exceeds 6%.

RESPONSE: Per discussion with Jon Bondendorf on 5/10/23, it has been agreed to disregard this comment. Regarding paving the first 25' of the existing driveway, there are many driveways on Diddell Road that are gravel with no asphalt at the entrance off the right-of-way. Additionally, this comment was not issued during site plan review on the 110 Chelsea Road tower project (Verizon site name "Castle Point") and that existing driveway is entirely gravel. Regarding the proposed driveway, it was agreed since the extent of driveway exceeding 6% is only 75-feet long, and the road section is sufficient to handle runoff and construction traffic on slopes up to 20%, asphalt would serve no benefit and it not required to be implemented. The proposed driveway on the project at 110 Chelsea Road is an example of a recently constructed driveway with this design, and although it lacks a slope exceeding 6%, it's a perfect example of the stability of the driveway design we are proposing for this project.

7. Provide 50' X 12' pull-offs for fire apparatus at 500' increments along the entire drive (existing and proposed.)

RESPONSE: Three pull-offs have been incorporated into the design along the existing access drive. See Sheet C-1A. Based on the geometry of the driveway, the final pull-off near the tower falls in line with the existing gravel paths that go east and west at the



start of the new driveway and those paths are dimensionally sufficient to act as a fire apparatus pull-off.

8. Show if improvements to the existing drive are necessary to support 30-ton fire apparatus.

RESPONSE: No improvements are necessary. Based on our site inspection for the Verizon project, the existing driveway appears to be solid throughout and clearly has experienced a fair amount of heavy truck and construction vehicle traffic. We have no concerns this existing driveway will be able to stand up to Verizon's construction traffic. Long term maintenance of the site consists of a cell technician visiting the site 1-2 times per year and that is via SUV or pickup truck.

9. Provide a note indicating tree clearing limitations based on the possible presence of Indiana Bats.

RESPONSE: Comment addressed. See Sheet C-1B.

10. Show photometrics of the proposed 25W flood light.

RESPONSE: Comment addressed. See Sheet C-4C.

11. Provide drawings and calculations stamped by a NYS licensed PE for the monopole foundation.

RESPONSE: We request this item be moved to a condition of approval. It is standard industry practice for formal tower and foundation design reports to be submitted to the Town as part of the building permit application. The reports will be based on site specific geotechnical information. Said geotechnical study will be performed after the site plan and special use permit have been issued by the Town.

#### **FEAF**

1. D.1.b: confirm that disturbance for underground power and fiber is included in area of disturbance.

RESPONSE: Comment addressed, see pages 3 and 9.



2. C.4.c: Change to New Hackensack Fire District and Town of Wappinger Ambulance.

RESPONSE: Comment addressed, see page 3.

Should you have any questions, please do not hesitate to contact the undersigned at (518) 783-1630.

Sincerely,

Tectonic Engineering Consultants, Geologists & Land Surveyors, D.P.C.

Steven M. Matthews, PE


Managing Director - Engineering

# VERIZON WIRELESS OF THE EAST LP, d/b/a



# SITE NAME: DIDDELL RD

RE PROJECT NUMBER: 20222321233 LOCATION CODE: 706668

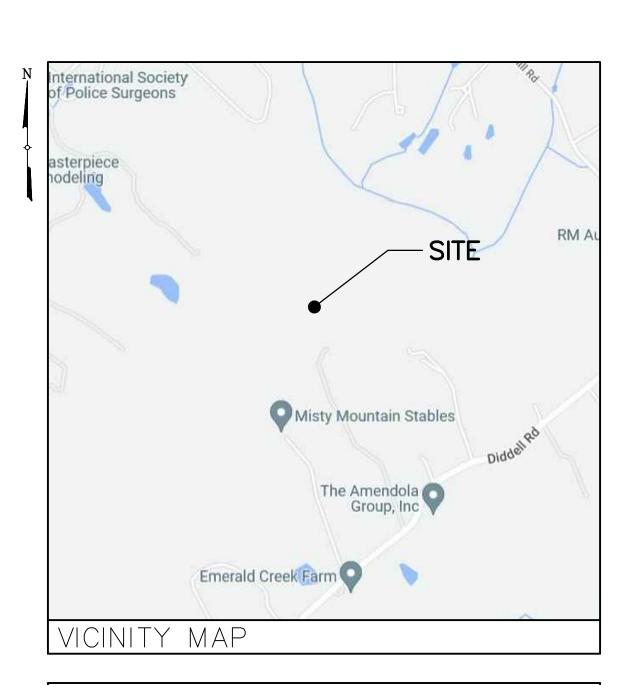

# DIRECTIONS

# DIRECTIONS TO SITE:

GET ON I-90 E FROM US-4 S AND NY-43 W, FOLLOW FOR ±3.6 MILES. MERGE ONTO I-90 E, FOLLOW FOR ±12.4 MILES. TAKE THE EXIT ON THE LEFT TO STAY ON I-90 E TOWARD TACONIC PKWY/BOSTON, FOLLOW FOR ±8.9 MILES. TAKE EXIT B2 FOR TACONIC PKWY TOWARD NY-295, FOLLOW FOR ±0.2 MILES. CONTINUE ONTO TACONIC STATE PARKWAY, FOLLOW FOR ±58.2 MILES. TURN RIGHT ONTO TODD HILL RD, FOLLOW FOR ±0.2 MILES. TURN LEFT ONTO STRINGHAM RD, FOLLOW FOR ±1.3 MILES. TURN RIGHT ONTO NOXON RD, FOLLOW FOR ±0.2 MILES. TURN LEFT ONTO ROBINSON LN, FOLLOW FOR ±0.04 MILES. TURN RIGHT ONTO DIDDELL RD, FOLLOW FOR ±1.6 MILES. TURN RIGHT ONTO THE GRAVEL ROAD, FOLLOW FOR ±0.4 MILES. SITE WILL BE ON THE FRONT.

SITE ADDRESS:	DIDDELL RD WAPPINGERS, NY 12590
MUNICIPALITY:	TOWN OF WAPPINGER
COUNTY:	DUTCHESS
TAX MAP NUMBER:	6359-01-480600
ZONING DISTRICT:	R-40/80 & R-3A
STRUCTURE COORDINATES:	41.636578° -73.842958°
GROUND ELEVATION:	397.1'± AMSL
PROPERTY OWNER:	MEDDAUGH, PATRICIA H. TRUSTEE TIEDEMAN, CRAIG TRUSTEE 79 DIDDELL RD WAPPINGERS FALLS, NY 12590
APPLICANT:	VERIZON WIRELESS 1275 JOHN STREET, SUITE 100 WEST HENRIETTA, NY 14586
CONTACT PERSON:	KATHY POMPONIO
CONTACT PHONE:	(585) 321-5435
PROJECT SUMMA	RY

# DESCRIPTION

THE PROPOSED WORK CONSISTS OF INSTALLING CELLULAR ANTENNAS AND RELATED EQUIPMENT ON A PROPOSED MONOPOLE AND THE INSTALLATION OF EQUIPMENT AT GRADE WITHIN A PROPOSED FENCED COMPOUND. PROJECT INCLUDES UNDERGROUND POWER AND FIBER UTILITIES TO SERVICE THE FACILITY.

SHT. NO.	DESCRIPTION	REV NO	REVISION DATE
T-1	TITLE SHEET	2	5/11/23
AD-1	ADJOINERS PLAN	2	5/11/23
SB-1	SETBACK PLAN & BULK REQUIREMENTS	2	5/11/23
100 4	LOOATION MAD		F /44 /07
LOC-1	LOCATION MAP	2	5/11/23
C-1A	OVERALL SITE PLAN	2	5/11/23
C-1B	ROAD PLAN & PROFILE	2	5/11/23
C-2	SITE DETAIL PLAN	2	5/11/23
C-3	ELEVATION & ORIENTATION PLAN	2	5/11/23
C-4A	SITE DETAILS	2	5/11/23
C-4B	SITE DETAILS	2	5/11/23
C-4C	SITE DETAILS	2	5/11/23
C-5	EQUIPMENT ELEVATIONS	2	5/11/23
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SHE	EET INDEX		

THIS SET OF PLANS SHALL NOT BE UTILIZED AS CONSTRUCTION DOCUMENTS

UNTIL ALL ITEMS OF CONCERN HAVE BEEN ADDRESSED AND EACH OF THE

DRAWINGS HAS BEEN REVISED AND ISSUED "FOR CONSTRUCTION".

# Before You Dig, Drill Or Blast! Dig | Safely. New York UNDERGROUND FACILITIES PROTECTIVE ORGANIZATION CALL US TOLL FREE 1-800-962-7962 NY industrial code rule 753 requires no less than two working days notice, but not more than ten days notice DIG SAFELY - NEW YORK

# DO NOT SCALE DRAWINGS

THESE DRAWINGS ARE FORMATTED FOR 22"x34" FULL SIZE AND 11"x17 HALF SIZE. OTHER SIZED VERSIONS ARE NOT PRINTED TO THE SCALE SHOWN. CONTRACTOR SHALL VERIFY ALL PLANS, EXISTING DIMENSIONS & CONDITIONS ON THE JOB SITE & SHALL IMMEDIATELY NOTIFY THE ENGINEER IN WRITING OF ANY DISCREPANCIES BEFORE PROCEEDING WIT THE WORK OR BE RESPONSIBLE FOR SAME.



1275 JOHN STREET, SUITE 100 WEST HENRIETTA, NY 14586



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RE PN: 20222321233 LC: 706668


SITE ADDRESS DIDDELL RD TOWN OF WAPPINGER DUTCHESS COUNTY

NY 12590 SHEET TITLE

TITLE SHEET

SHEET NUMBER



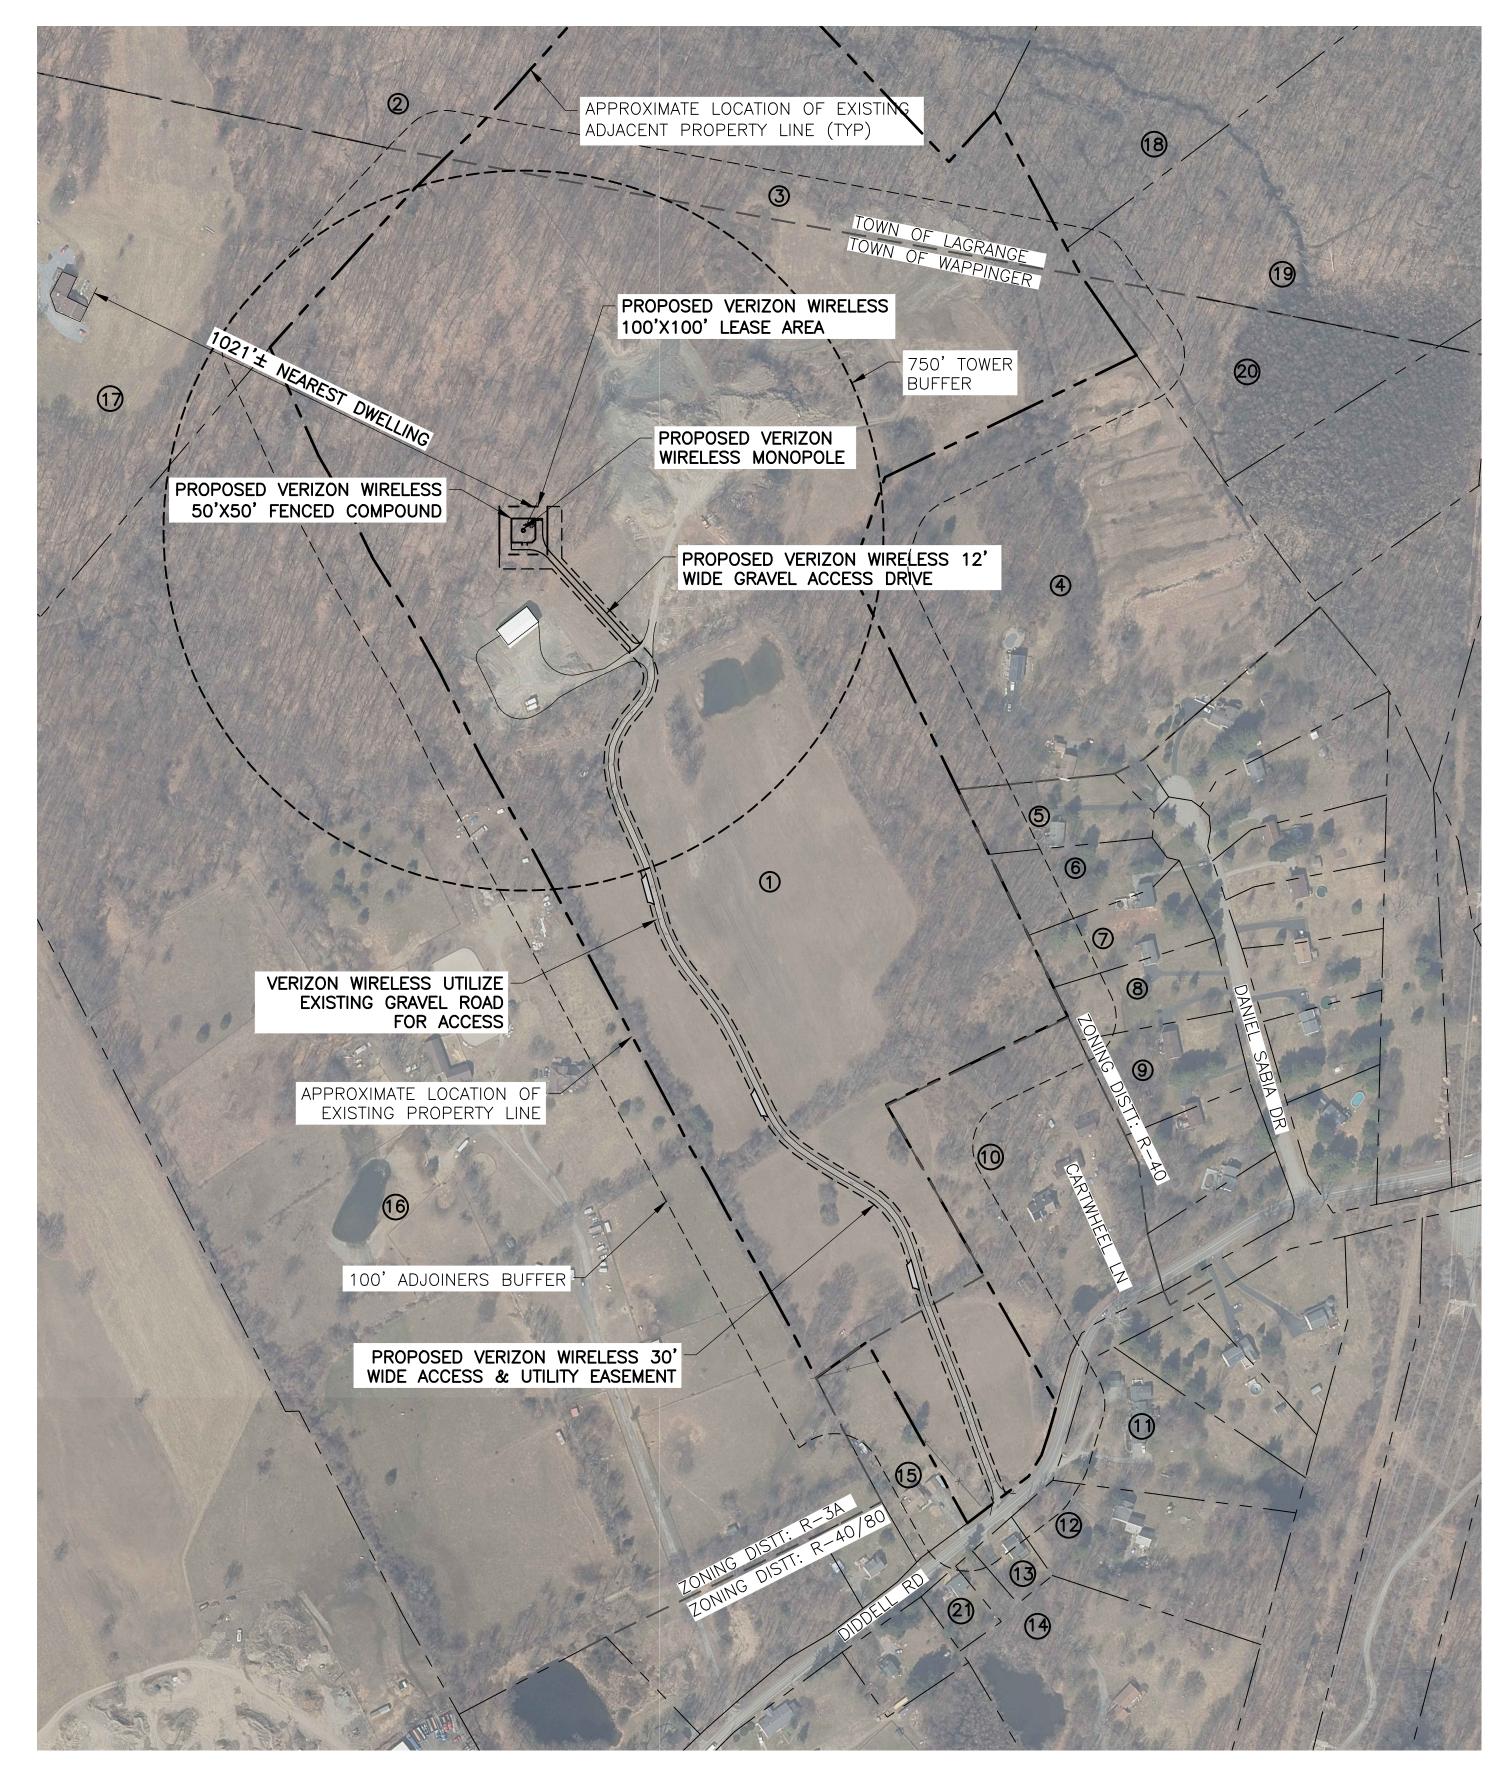

1	6359-01-480600	Meddaugh, Patricia H. Trustee Tiedeman, Craig Trustee	Wappingers Falls, NY 12590
2	6359-01-265780	Ostuni, Charles	333 Maloney Rd Wappingers Falls, NY 12590
3	6359-01-446741	Meddaugh, Patricia H. Trustee Tiedeman, Craig Trustee	79 Diddell Rd Wappingers Falls, NY 12590
4	6359-02-507643	Verdi, Frank Verdi, Janet	16 Daniel Sabia Dr Wappingers Falls, NY 12590
5	6359-02-501608	Patane, Roger Patane, Deborah L	14 Daniel Sabia Dr Wappingers Falls, NY 12590
6	6359-02-508594	Sim, Long B.	12 Daniel Sabia Dr Wappingers Falls, NY 12590
7	6359-02-514582	La Guardia, Ronald J. La Guardia, Dorothy M.	10 Daniel Sabia Dr Wappingers Falls, NY 12590
8	6359-02-520570	Puchnick, Barbara Rose	8 Daniel Sabia Dr Wappingers Falls, NY 12590
9	6359-02-527553	Wohlfahrt, Thomas C. Barrett-Wohlfahrt, J	6 Daniel Sabia Dr Wappingers Falls, NY 12590
10	6359-02-501523	Seco, Jose L.	PO Box 830 Peekskill, NY 10566
11	6359-04-526478	Amendola, Anthony A. Amendola, Steven Klink-Amendola, Joan M.	122 Didell Rd Wappingers Falls, NY 12590
12	6359-04-523455	Reiner, Kurtis W. Reiner, Barbara L.	118 Diddell Rd Wappingers Falls, NY 12590
13	6359-03-493442	Goerlich, Corinne F.	114 Diddell Rd Wappingers Falls, NY 12590
14	6359-04-517410	Amendola, Anthony S.	108 Diddell Rd Wappingers Falls, NY 12590
15	6359-03-470467	Rossbach, Justin David Germano, Treya Brianne	105 Diddell Rd Wappingers Falls, NY 12590
16	6359-01-376524	Toulan, Timothy Toulan, Jessica	87 Diddell Rd Wappingers Falls, NY 12590
17	6359-01-235737	Ostuni, Charles	333 Maloney Rd Wappingers Falls, NY 12590
18	6359-02-538805	McMorrow, John McMorrow, Cindy	15 Strawberry Ln Poughkeepsie, NY 12603
19	6359-02-556725	Faison, Alexander III	65 N Grand Ave Poughkeepsie, NY 12603
20	6359-02-539693	McRae, Christopher	715 Taylor Ave Bronx, NY 10473
21	6359-03-485436	Clancy, Glenn L. Trustee Clancy, Gary R. Trustee	104 Diddell Rd Wappingers Falls, NY 12590

OWNER

Meddaugh, Patricia H. Trustee

**ADDRESS** 

79 Diddell Rd


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NOTE:

THE PROPERTY LINES HEREON ARE APPROXIMATE BASED ON GIS DATA AND ARE FOR ORIENTATION PURPOSES ONLY. THEY DO NOT REPRESENT A PROPERTY/BOUNDARY DECISION BY A LAND SURVEYOR.





1275 JOHN STREET, SUITE 100 WEST HENRIETTA, NY 14586

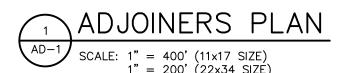Tectonic Engineering Consultants, Geologists & Land Surveyors, D.P.C.

Project Contact Info
36 British American Blvd. Phone: (518) 783-1630
Suite 101 (800) 829-6531
Latham, NY 12110 www.tectonicengineering.com

WORK ORDER NUMBER DRAWN BY 11272.014A NO. DATE ISSUE 0 | 2/3/23 | FOR COMMENT 1 | 2/8/23 | FOR ZONING 2 5/11/23 PER CPL COMMENTS

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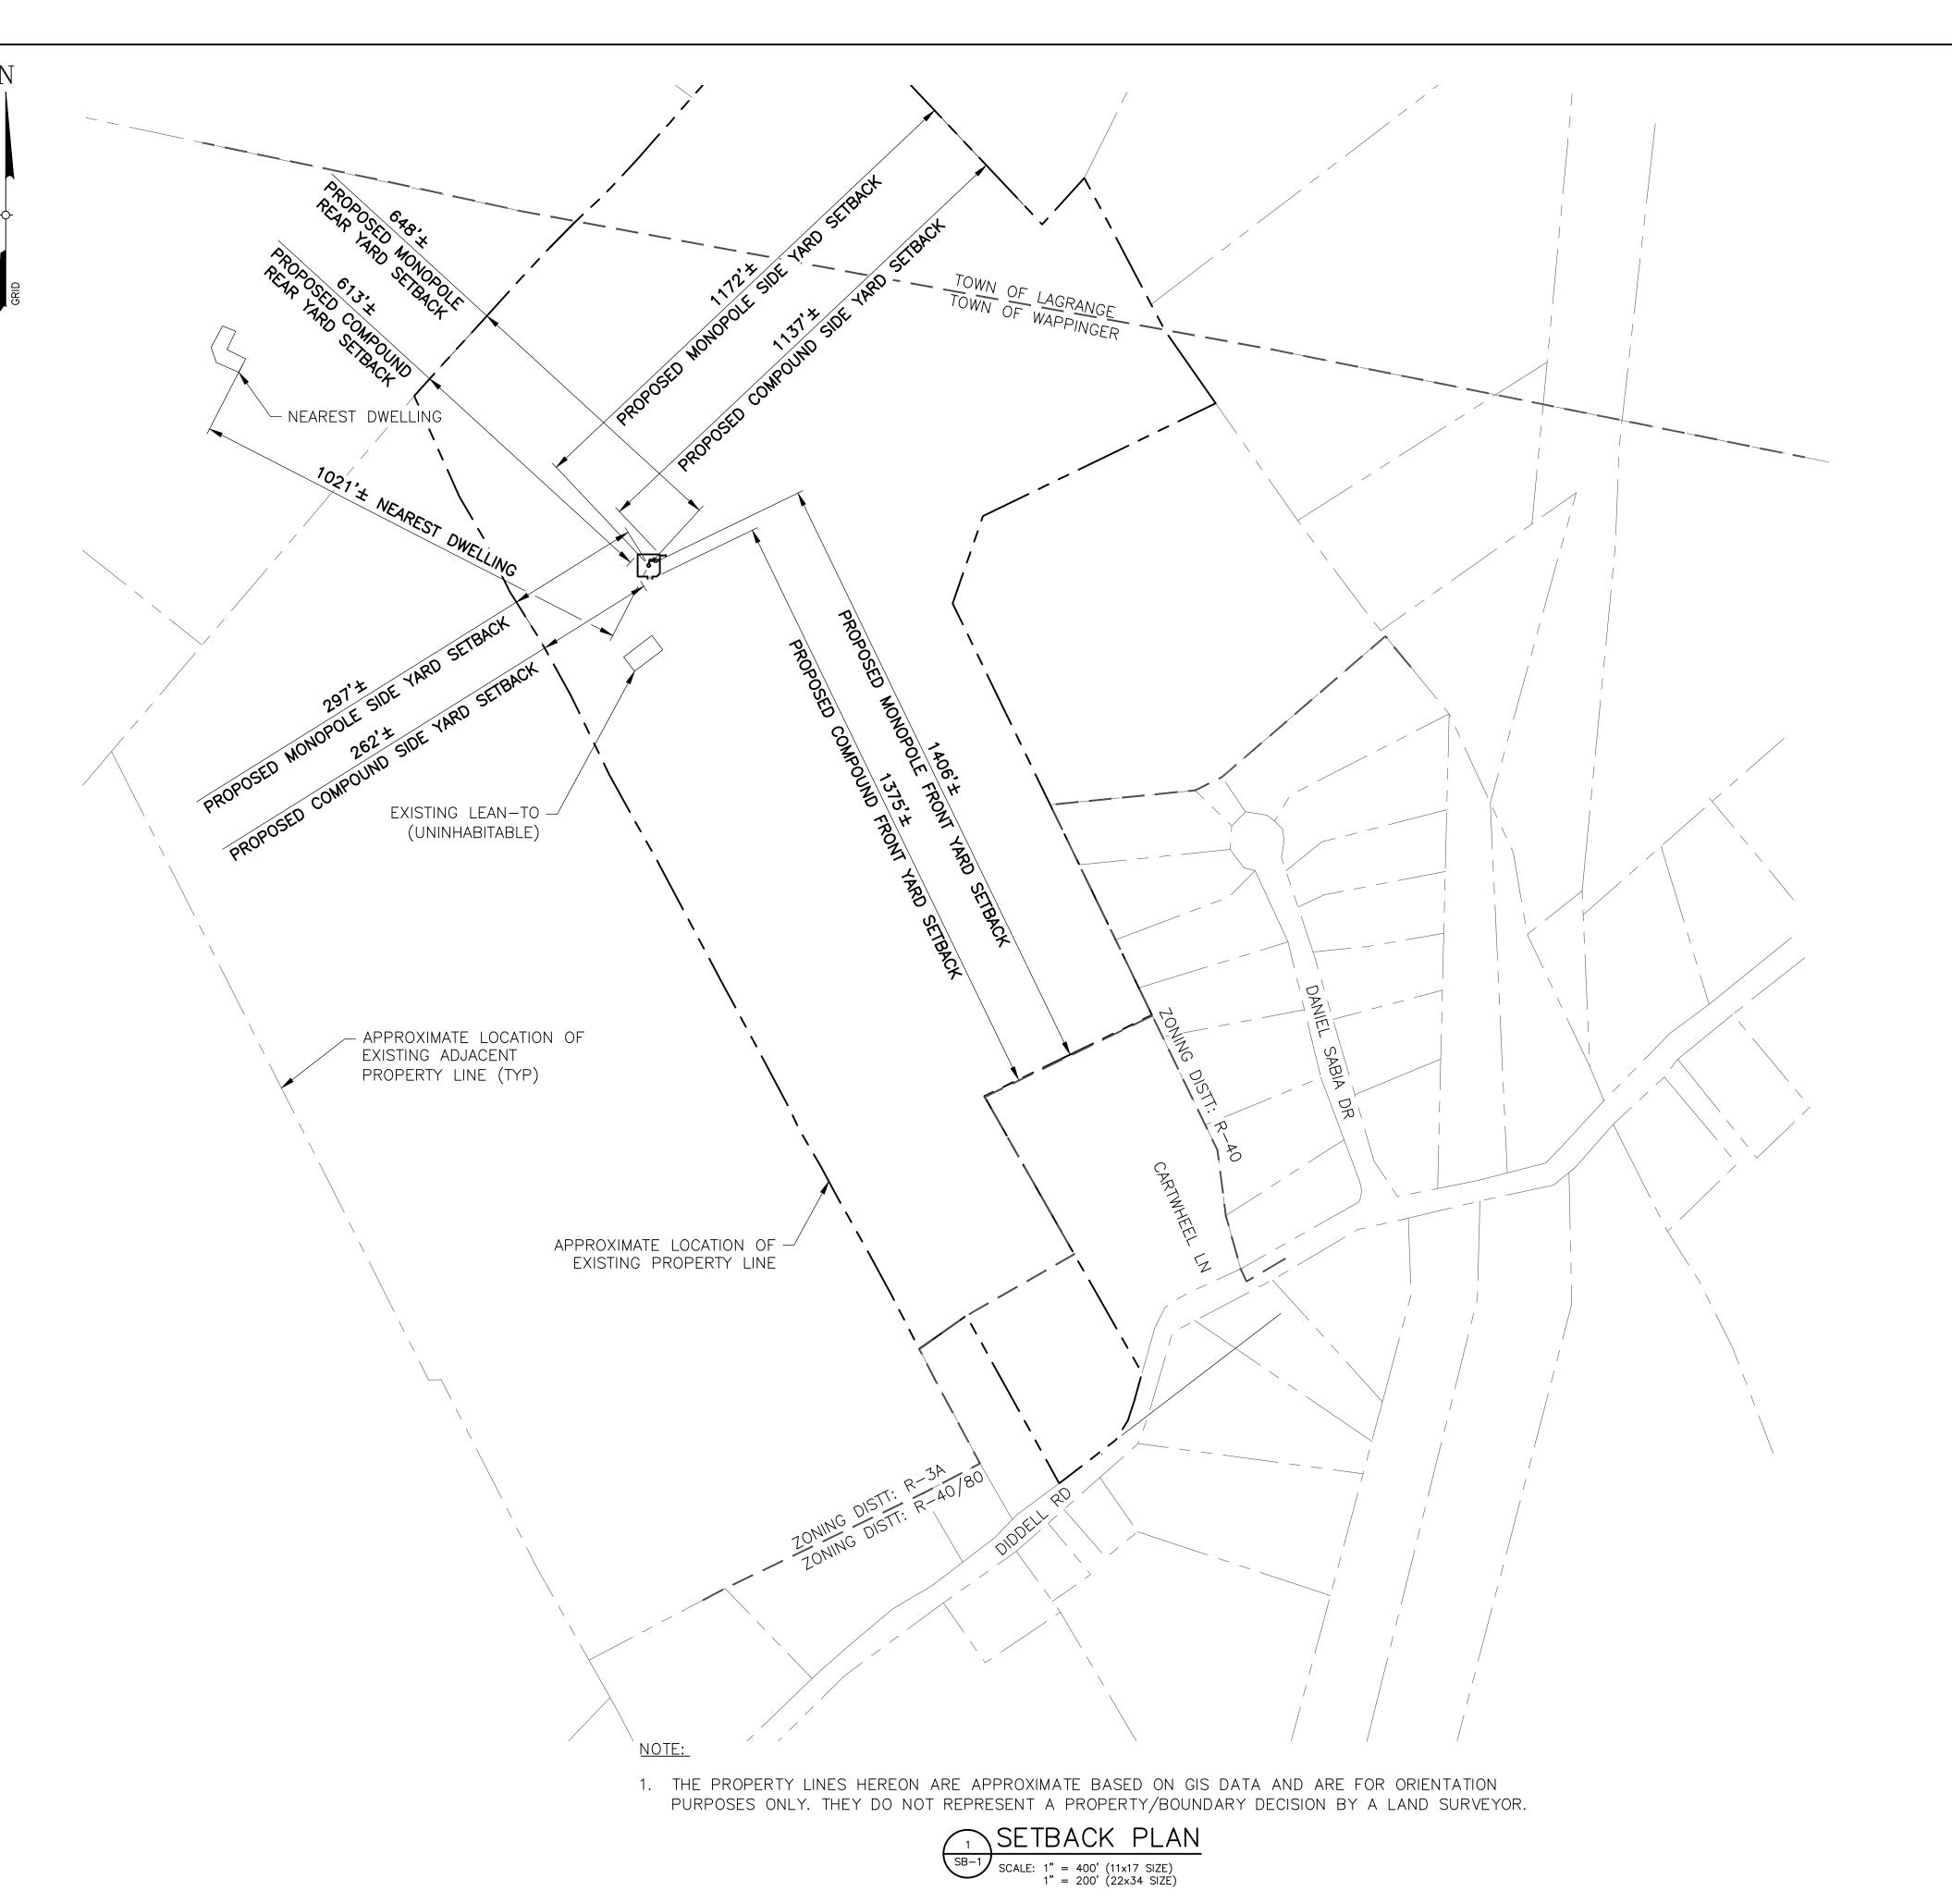
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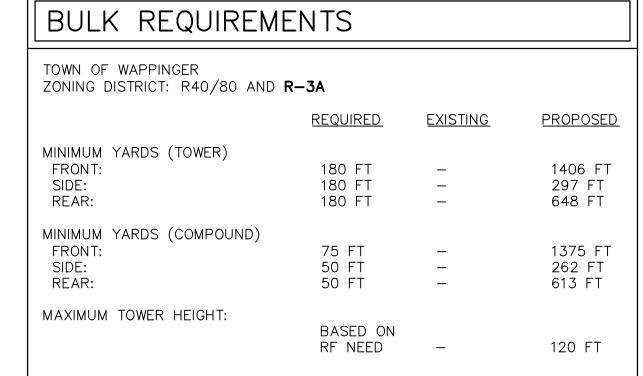
SITE ADDRESS DIDDELL RD TOWN OF WAPPINGER DUTCHESS COUNTY NY 12590

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1275 JOHN STREET, SUITE 100 WEST HENRIETTA, NY 14586



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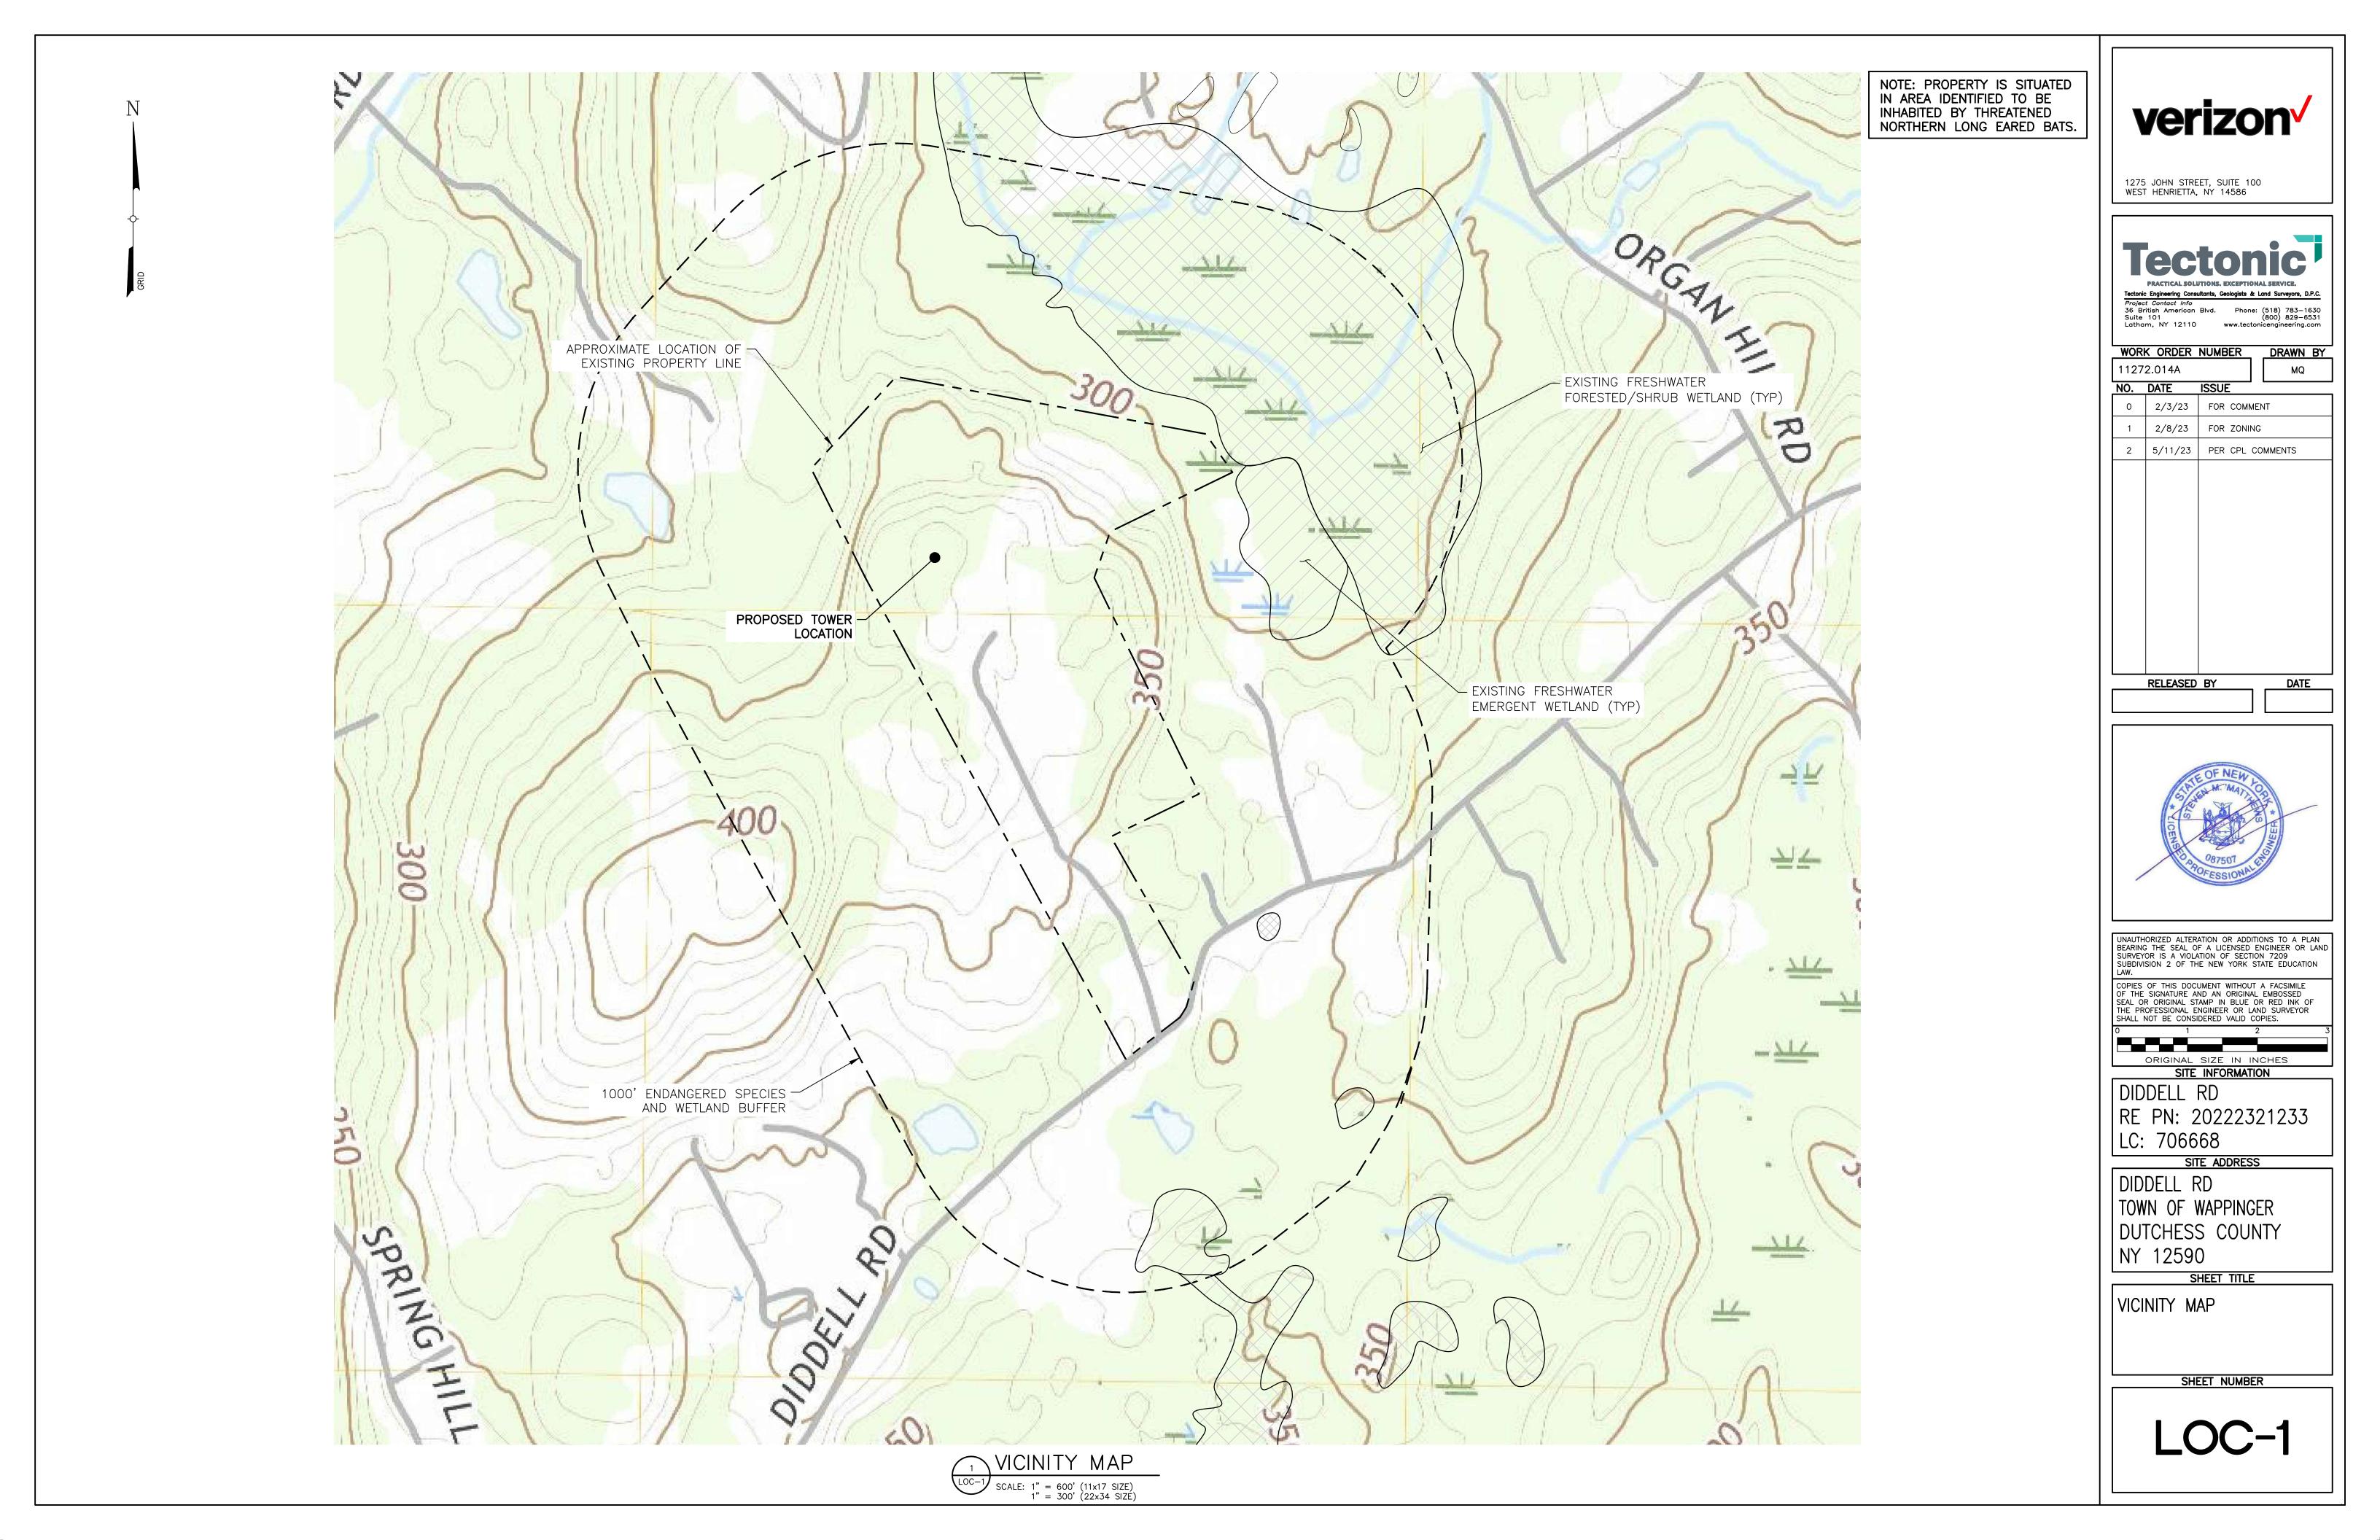
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DUTCHESS COUNTY
NY 12590


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SETBACK PLAN & BULK REQUIREMENTS

SHEET NUMBER

SB-1





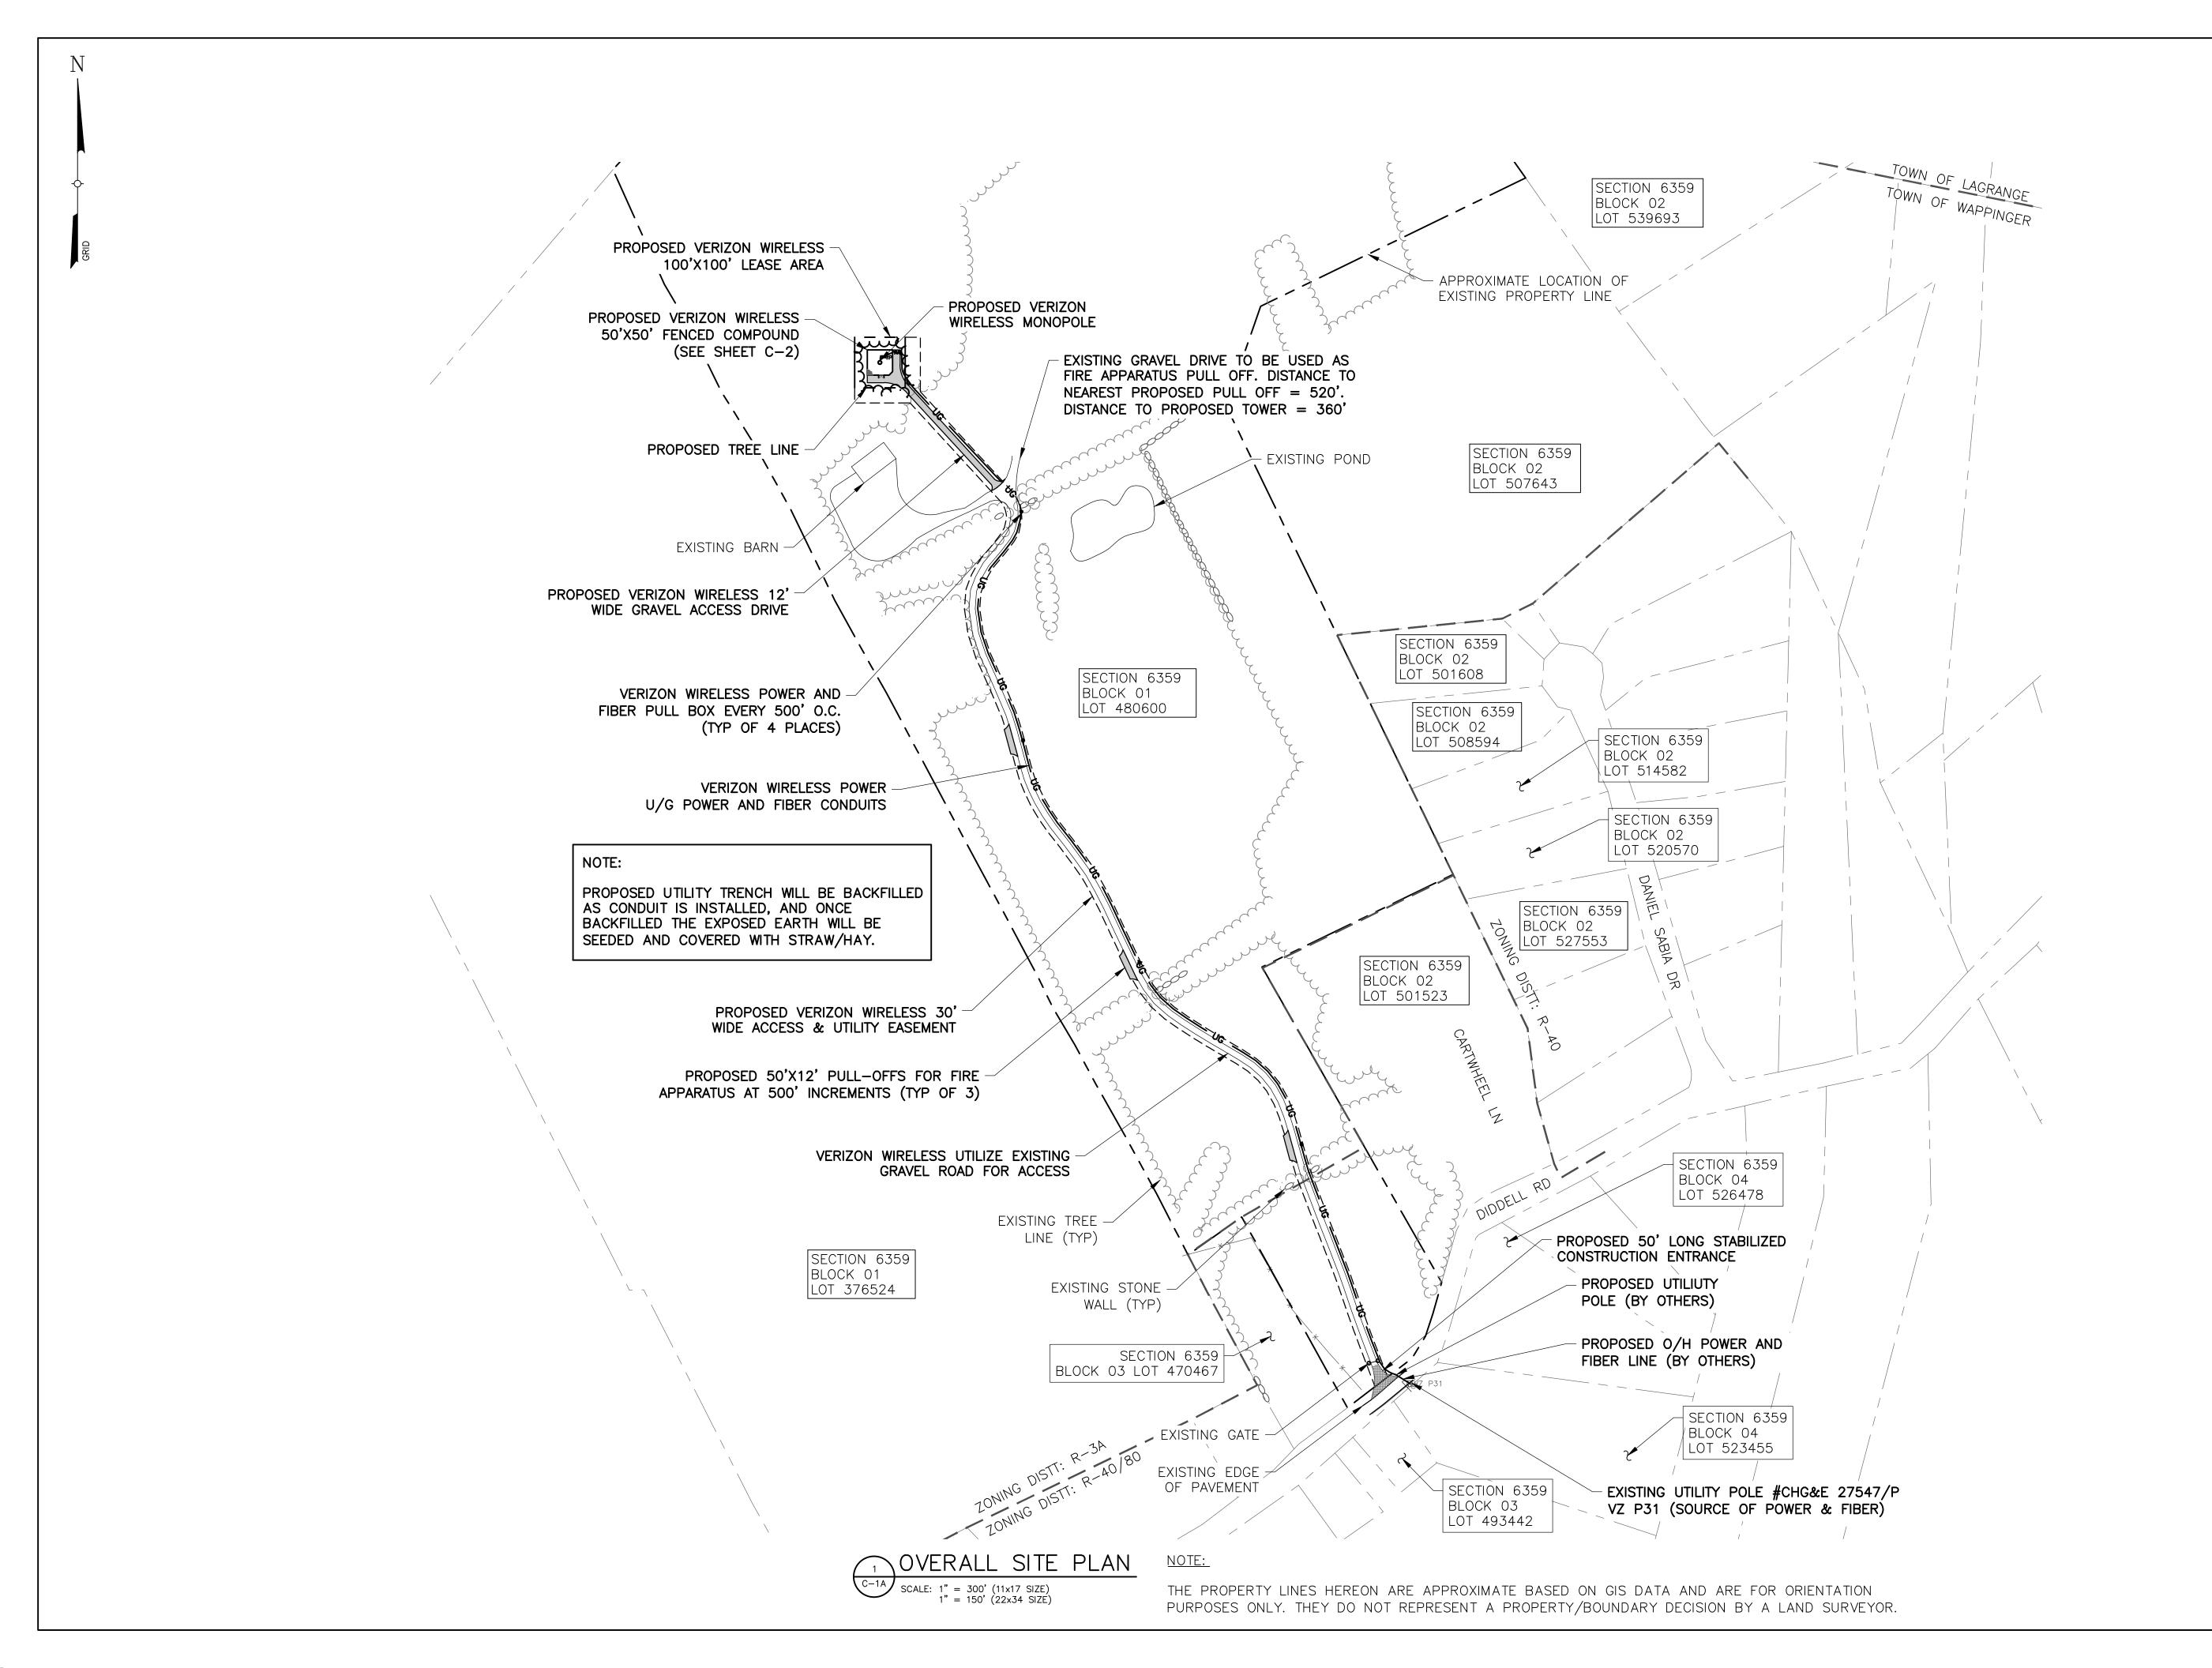

1275 JOHN STREET, SUITE 100 WEST HENRIETTA, NY 14586



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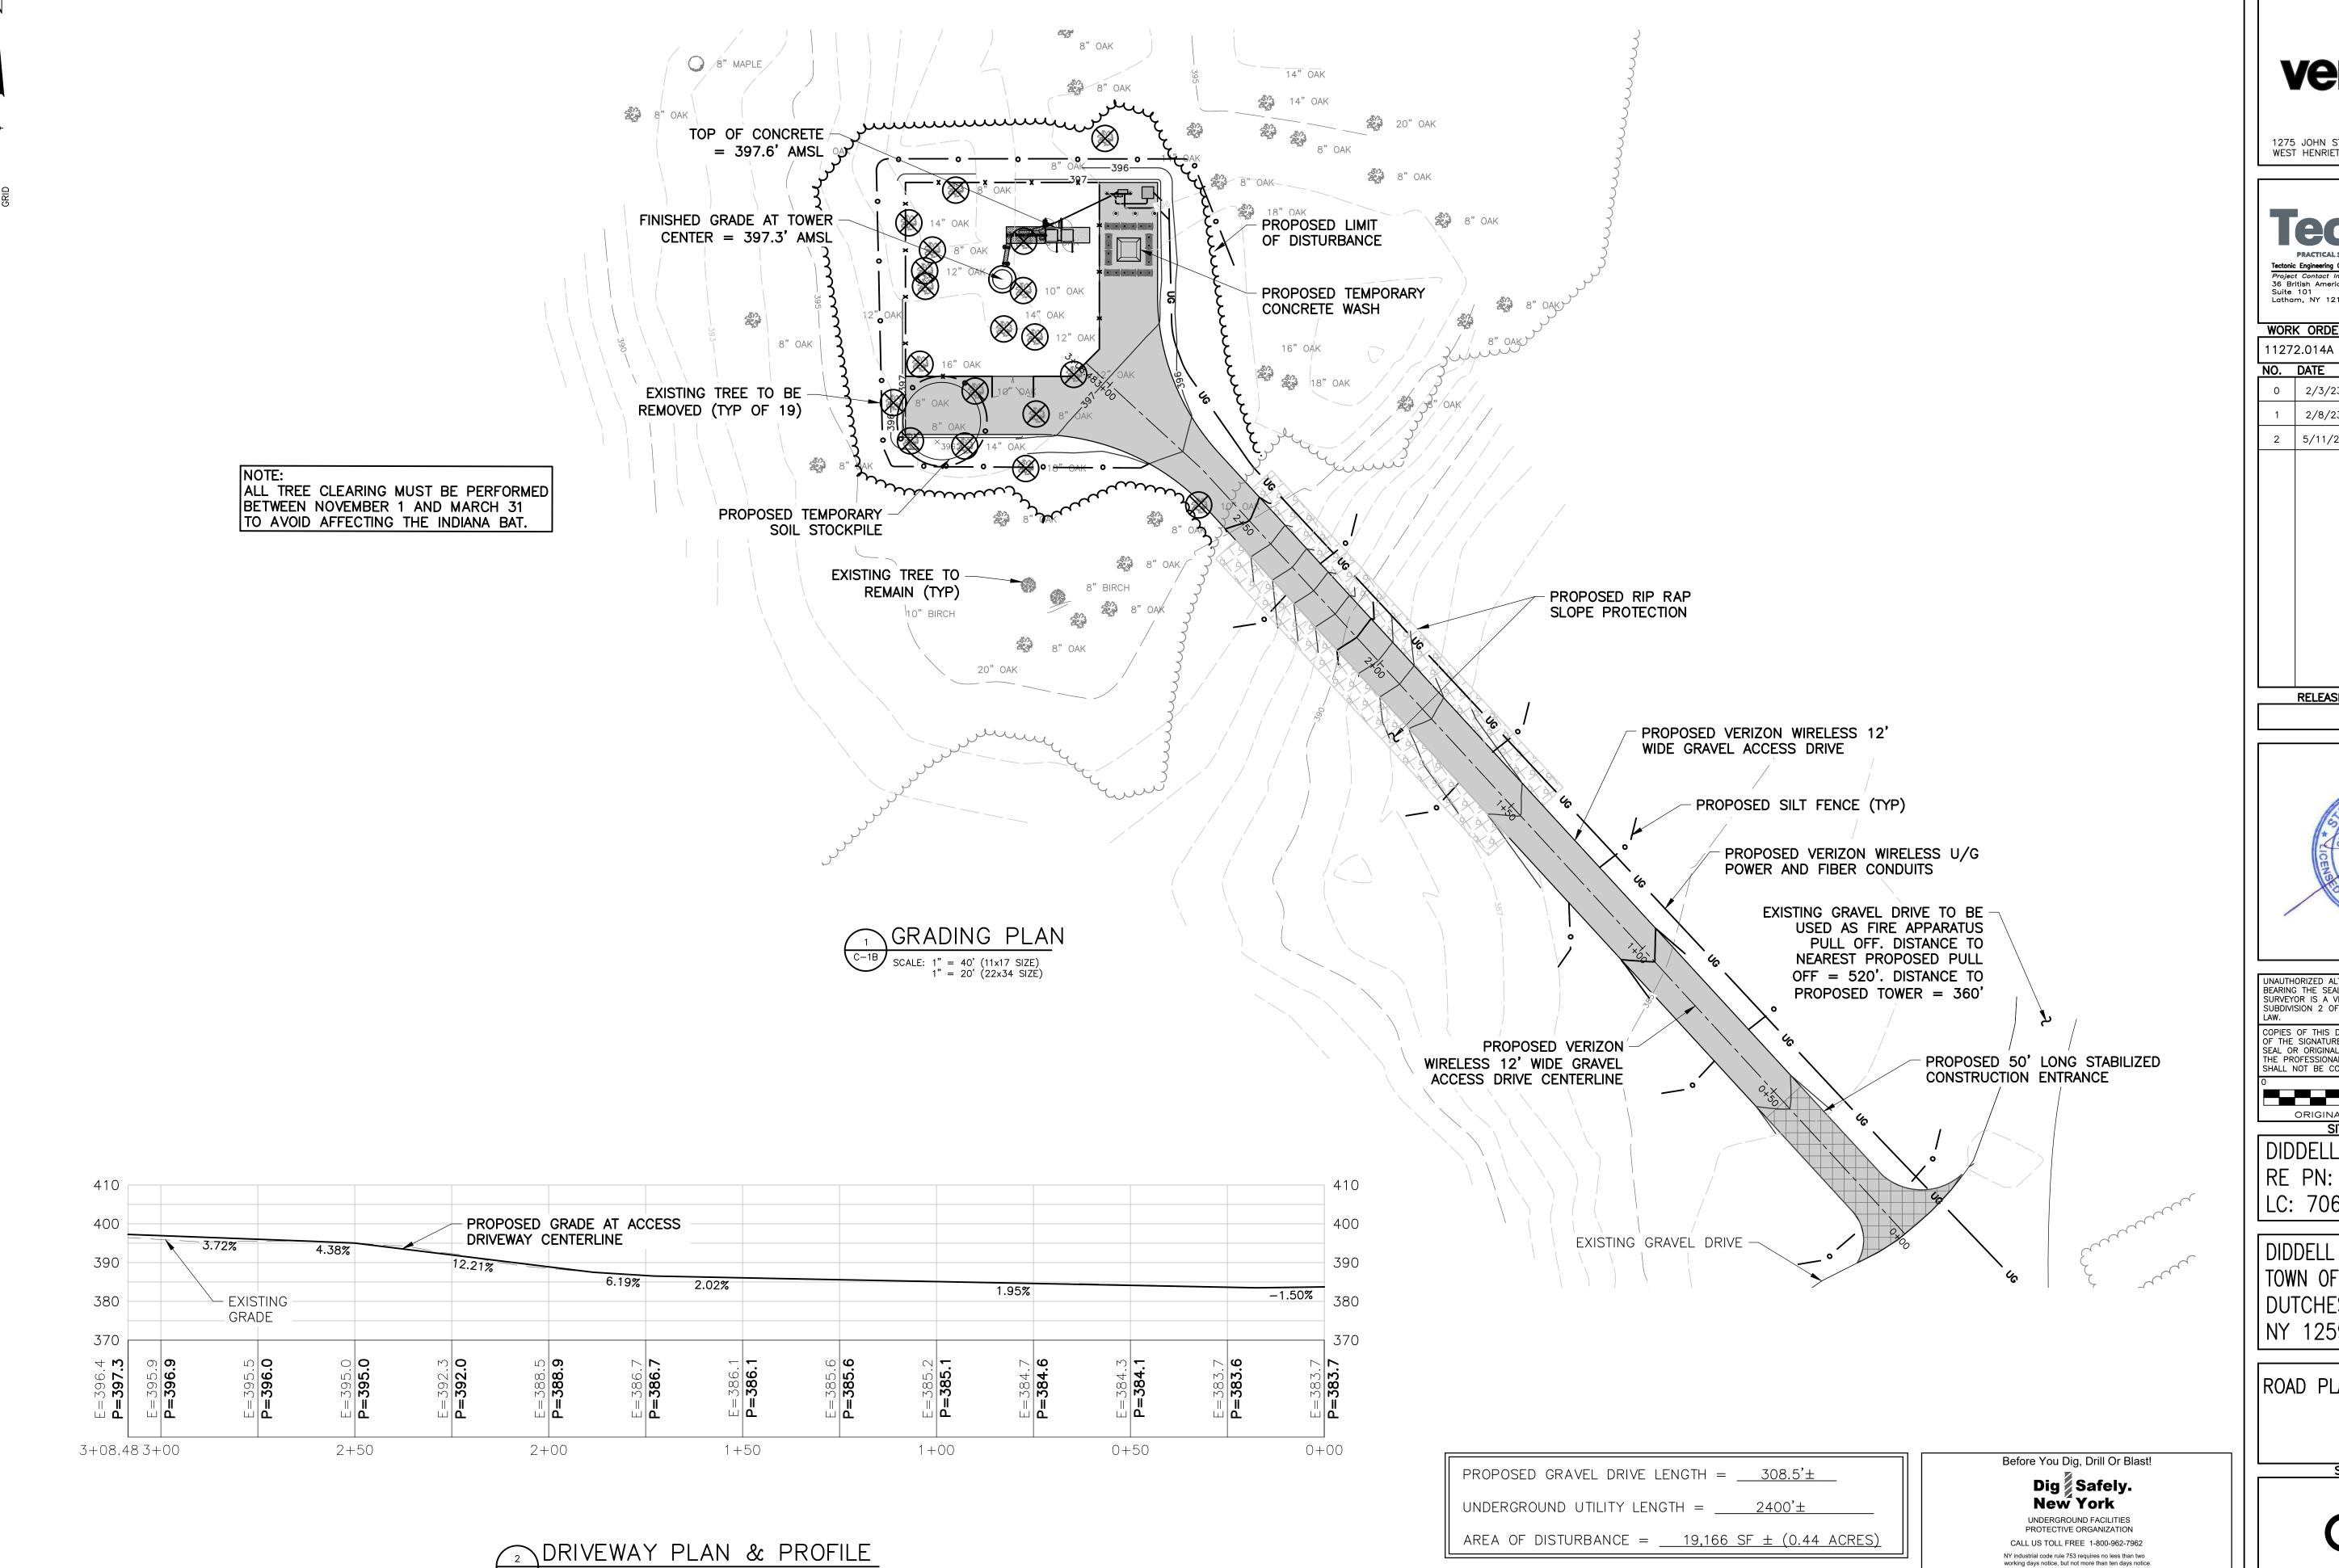
DIDDELL RD
TOWN OF WAPPINGER
DUTCHESS COUNTY
NY 12590

SHEET TITLE

OVERALL SITE PLAN

SHEET NUMBER

C-1A



SCALE: 1'' = 40' (11x17 SIZE)

1" = 20' (22x34 SIZÉ)

verizon /

1275 JOHN STREET, SUITE 100 WEST HENRIETTA, NY 14586

PRACTICAL SOLUTIONS. EXCEPTIONAL SERVICE.

Tectonic Engineering Consultants, Geologists & Land Surveyors, D.P.C.

Project Contact Info
36 British American Blvd. Phone: (518) 783–1630
Suite 101

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Suite 101
Latham, NY 12110

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DIDDELL RD
TOWN OF WAPPINGER
DUTCHESS COUNTY
NY 12590

SHEET TITLE

ROAD PLAN & PROFILE

SHEET NUMBER

C-1B

DIG SAFELY - NEW YORK

NOTE:

PROPOSED MONOPOLE WILL HAVE A
GALVANIZED STEEL FINISH RESULTING
IN A MATTE GRAY APPEARANCE



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SITE ADDRESS

DIDDELL RD

TOWN OF WADDINGER


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DUTCHESS COUNTY
NY 12590


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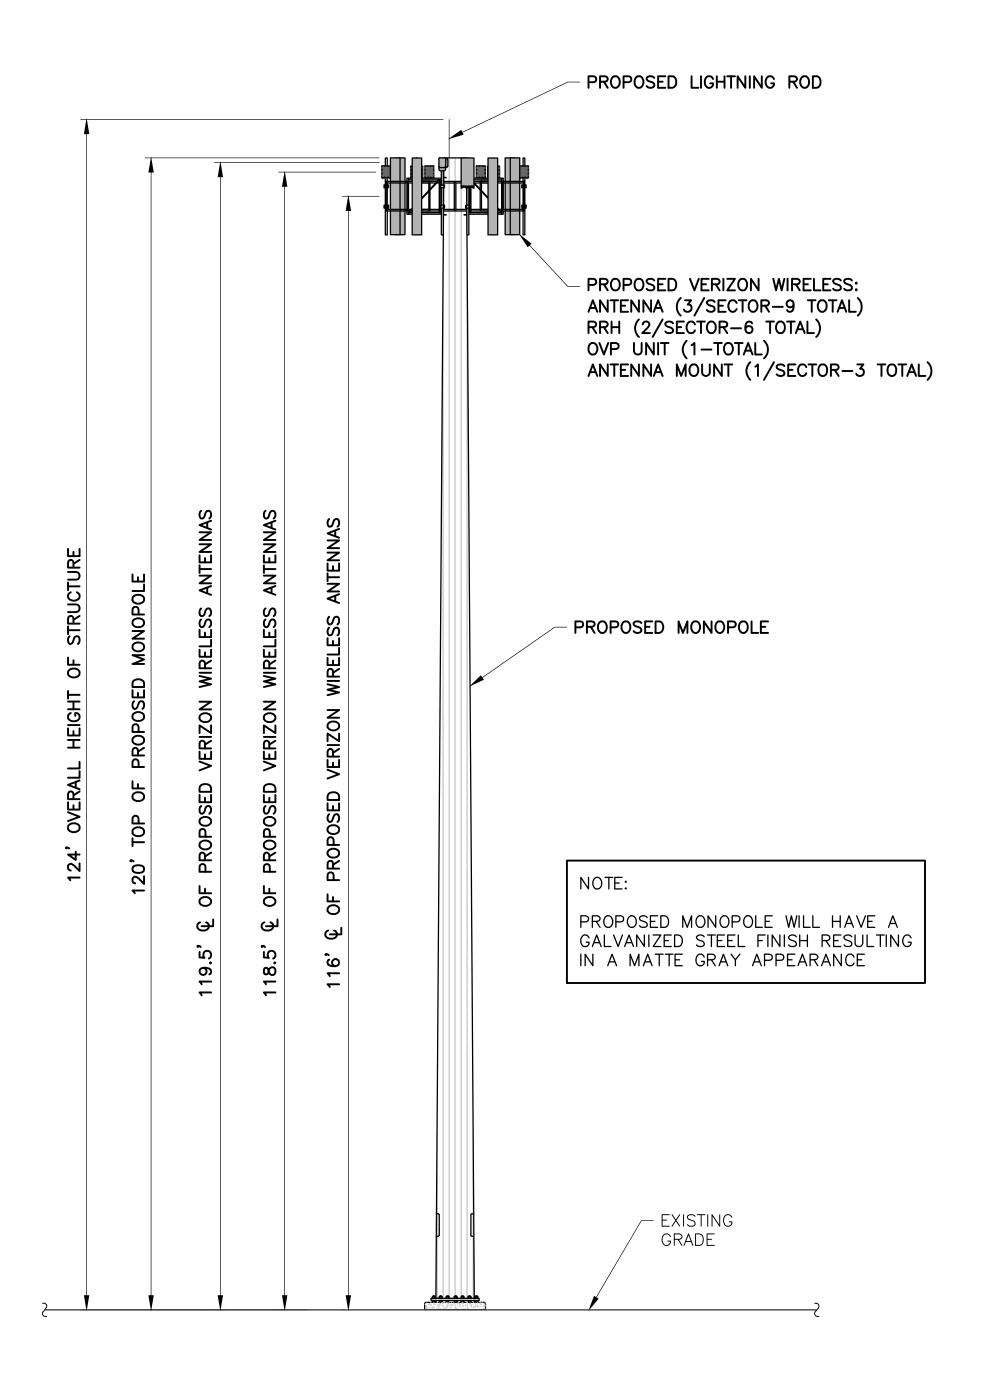
SITE DETAIL PLAN


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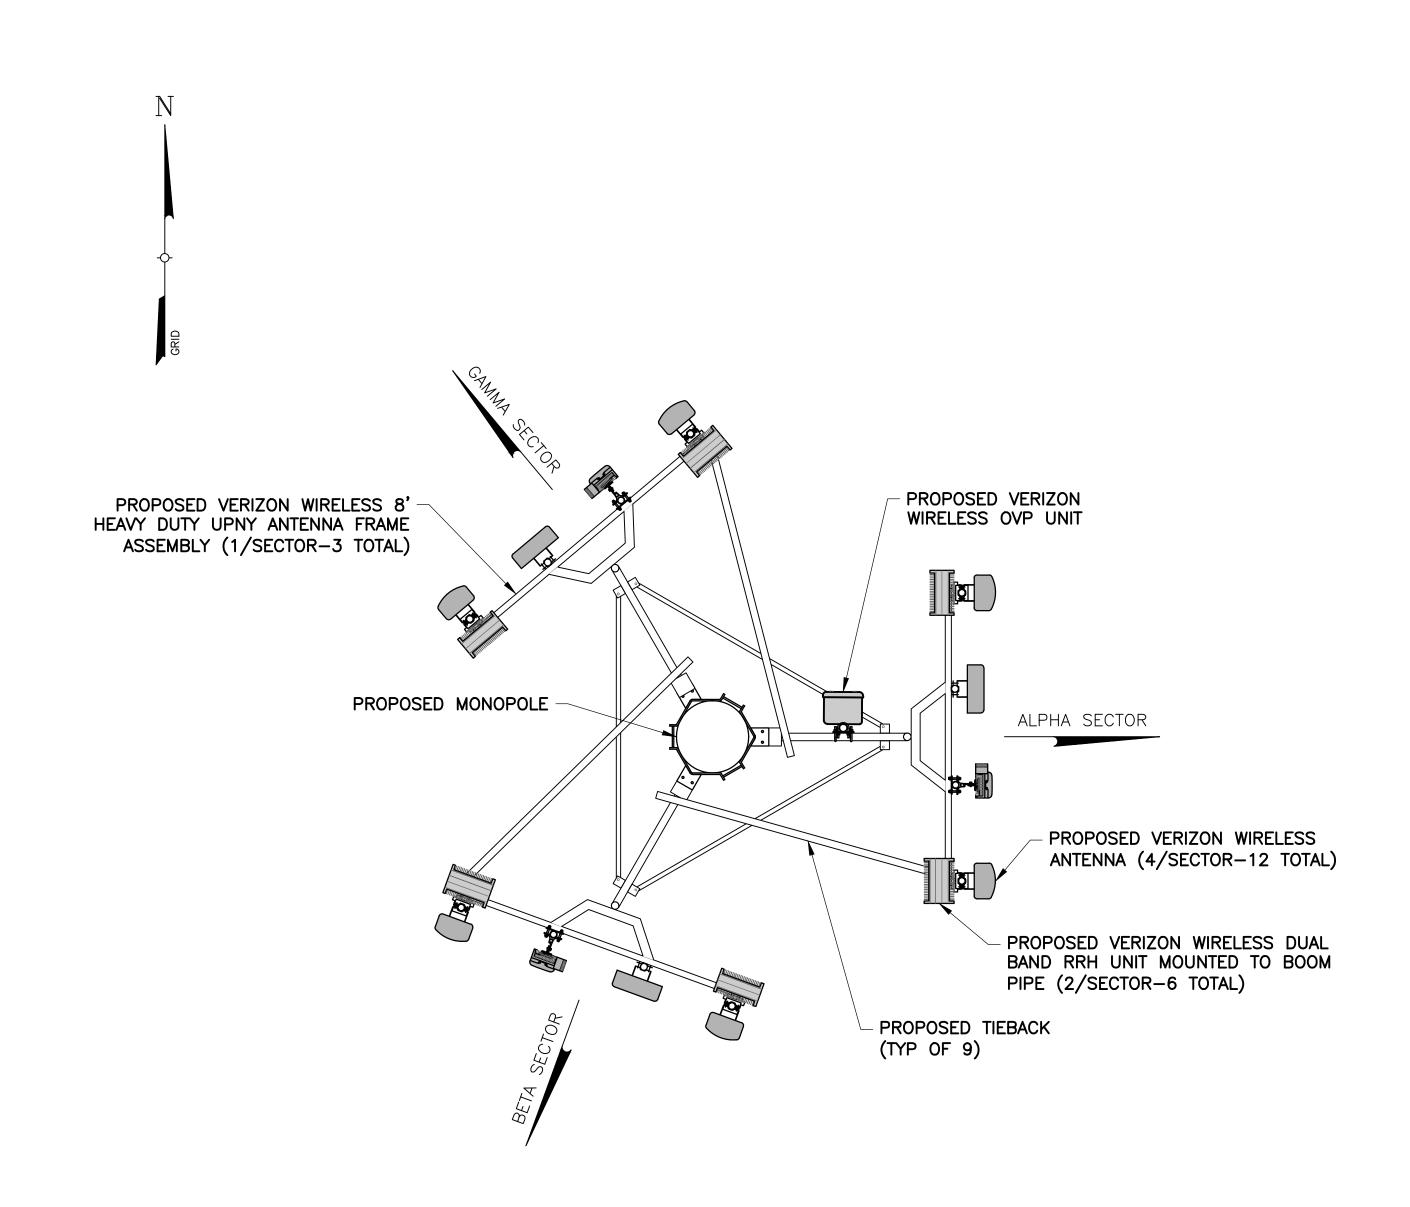
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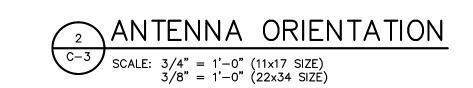






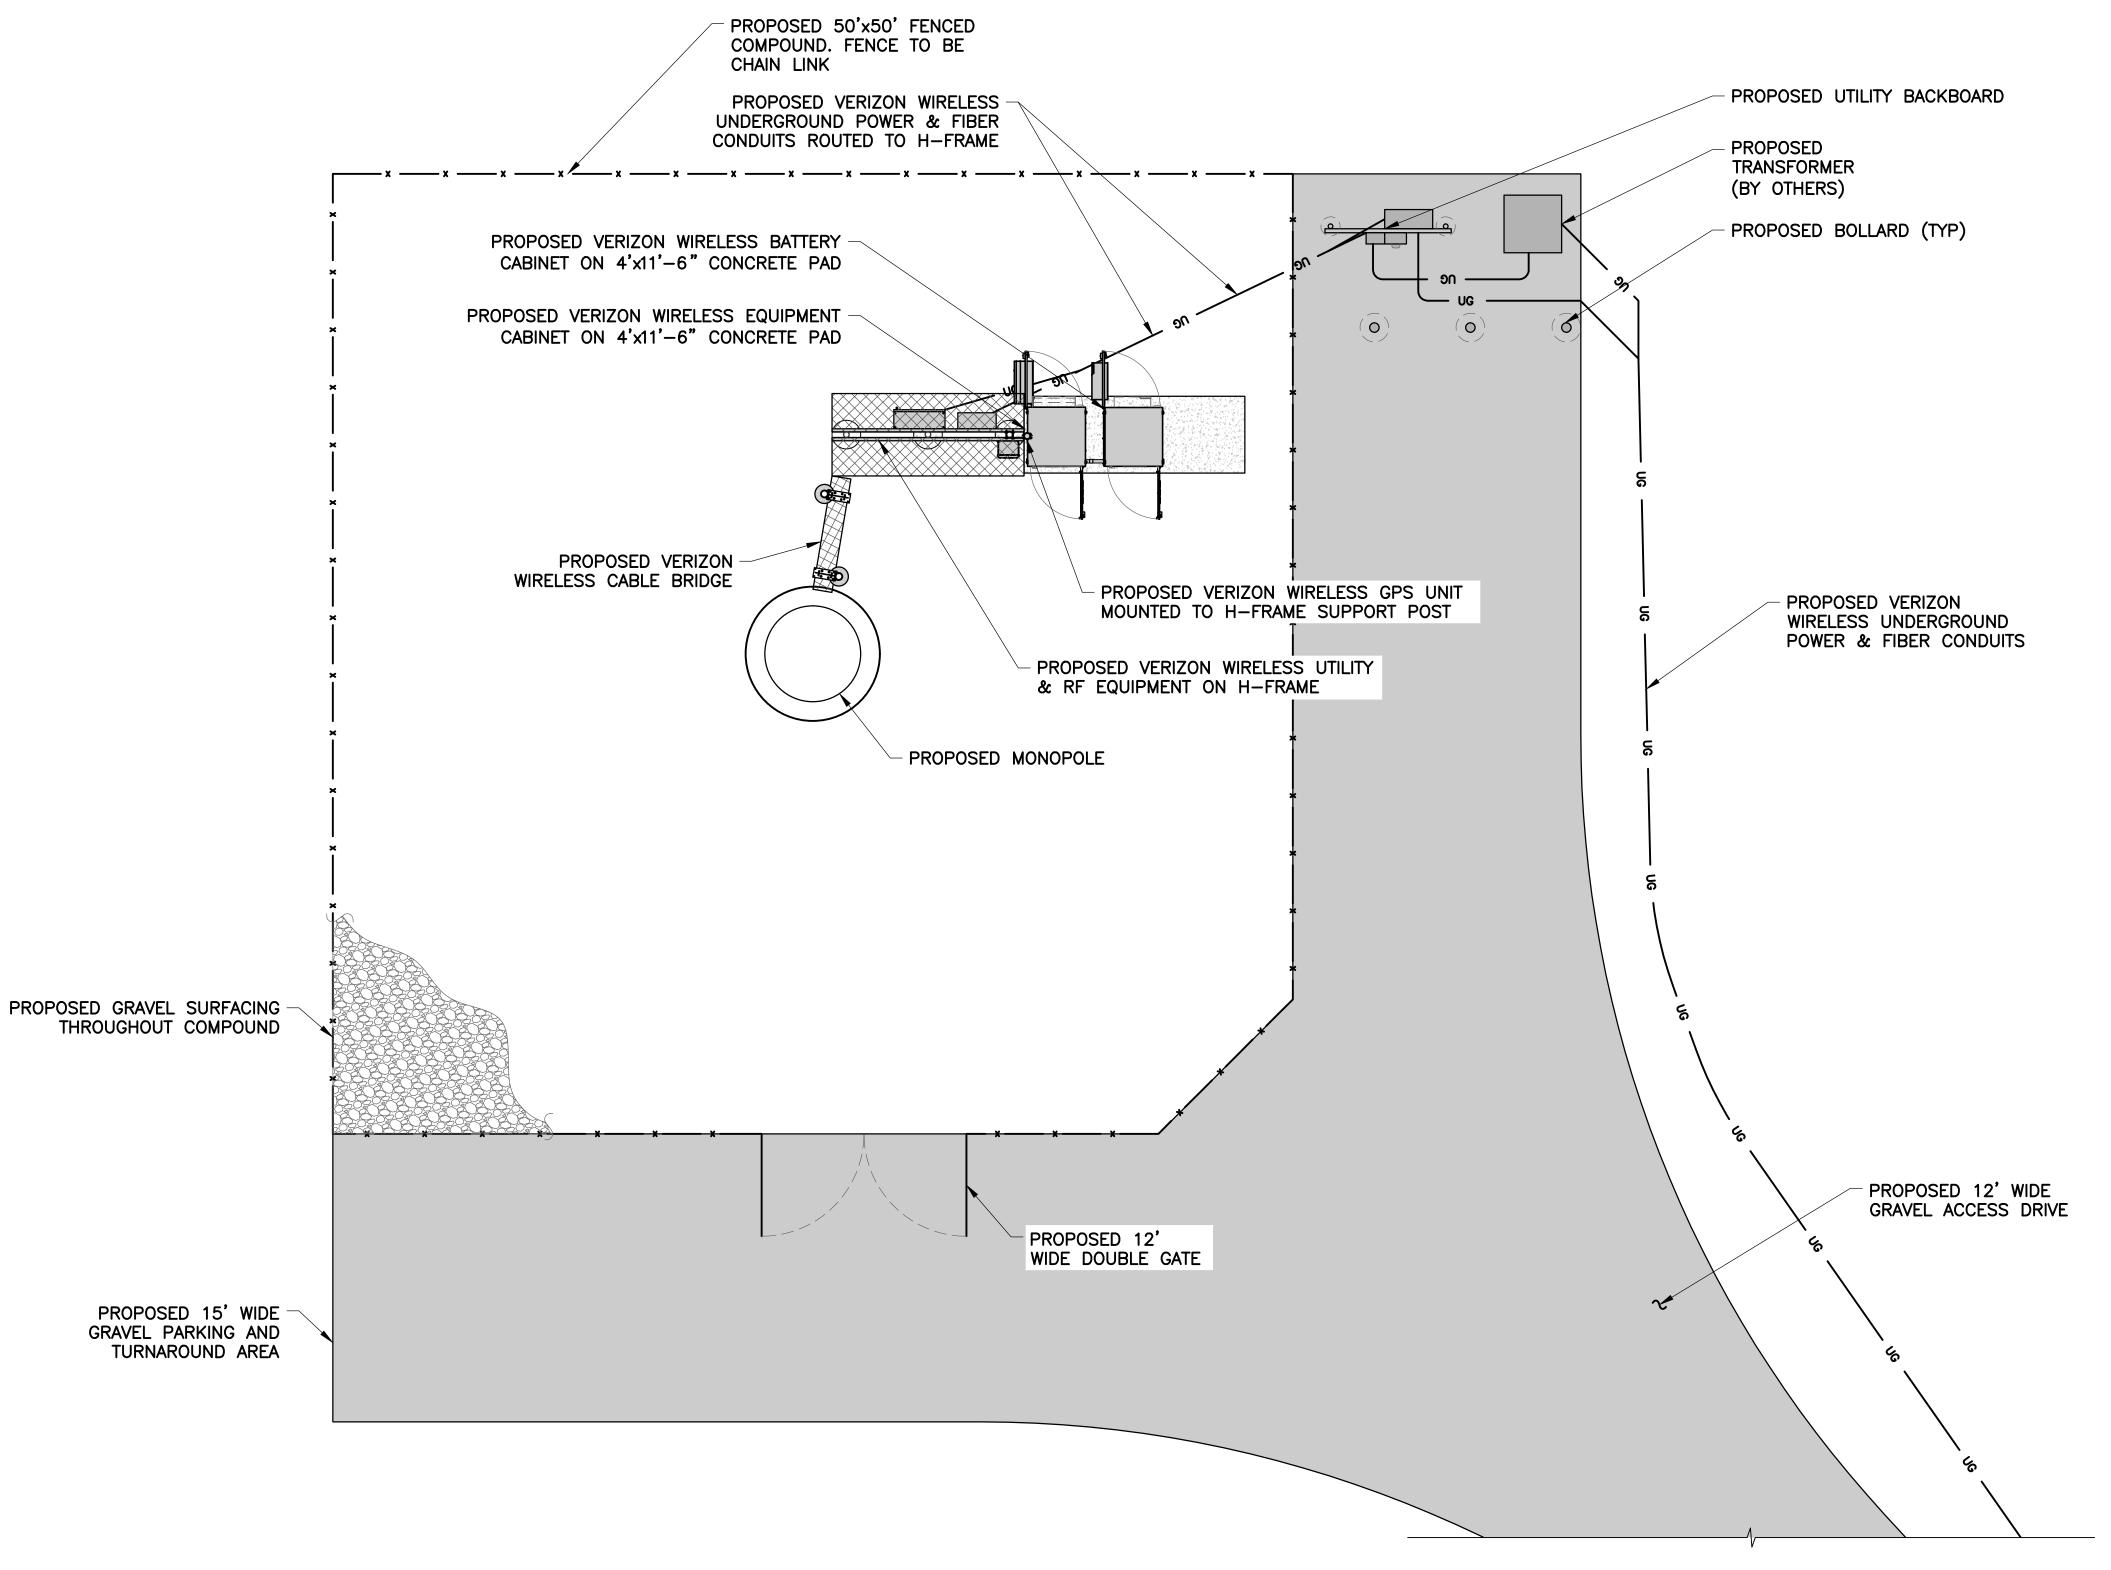

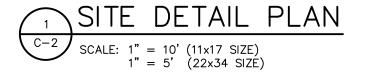

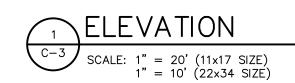



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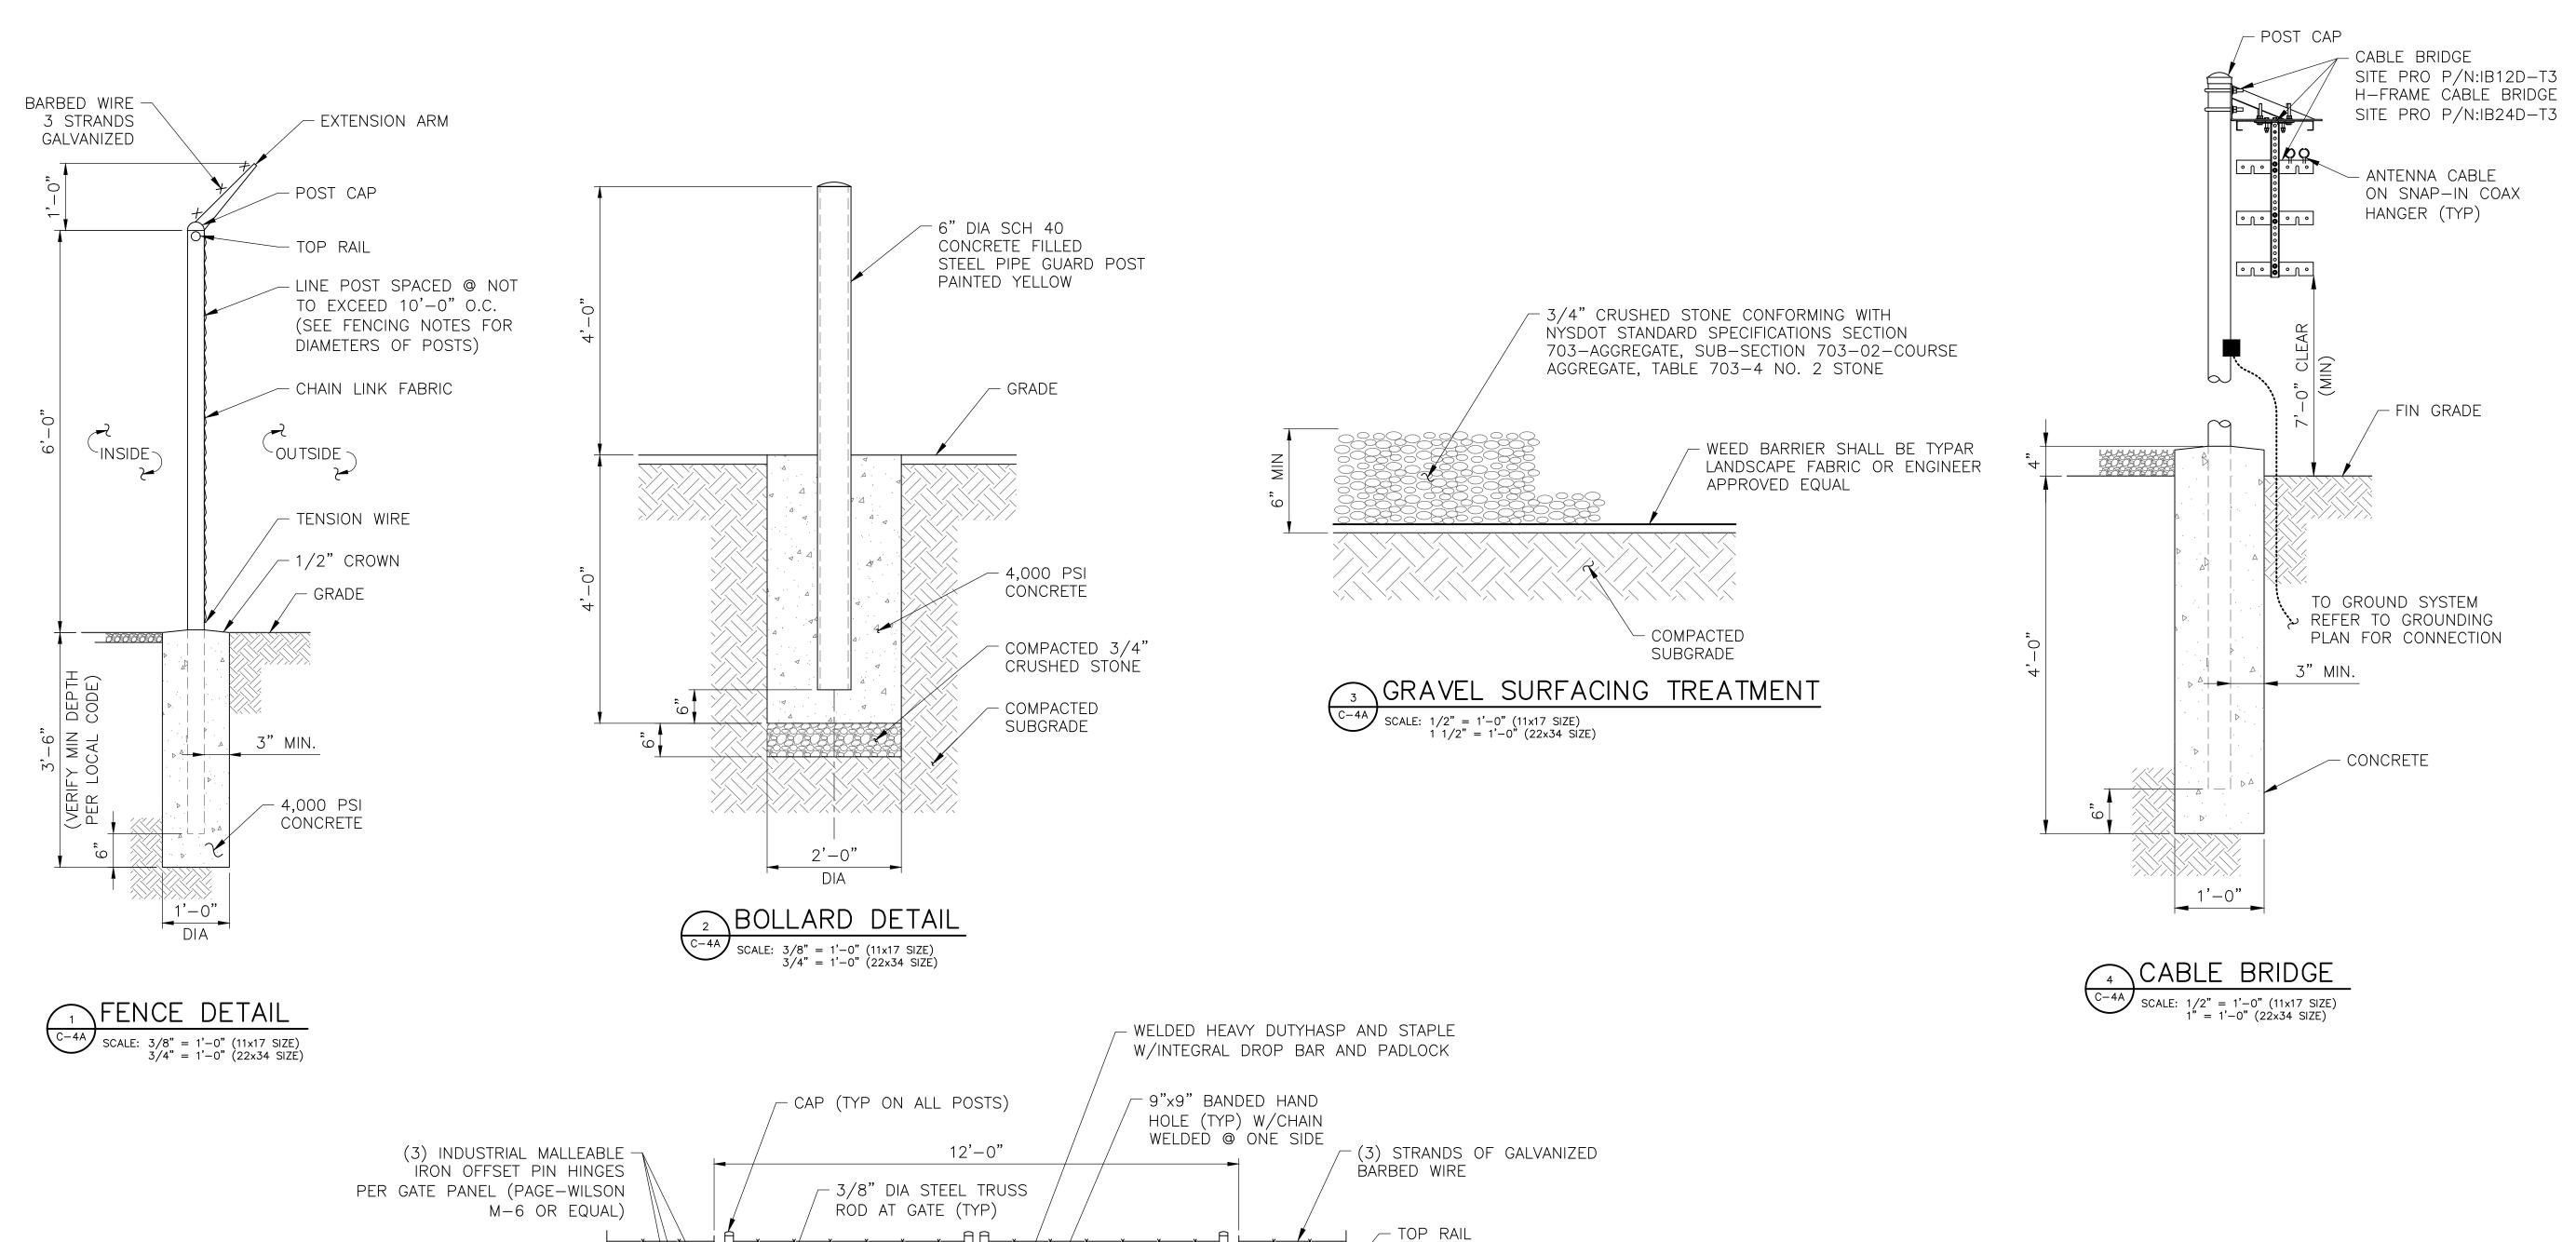
DIDDELL RD
TOWN OF WAPPINGER
DUTCHESS COUNTY
NY 12590

SHEET TITLE

ELEVATION & ORIENTATION PLAN

SHEET NUMBER

C-3



GATE FRAME

GATE POST

TENSION WIRE

— GRADE

CONCRETE

(SEE FENCE DETAIL)

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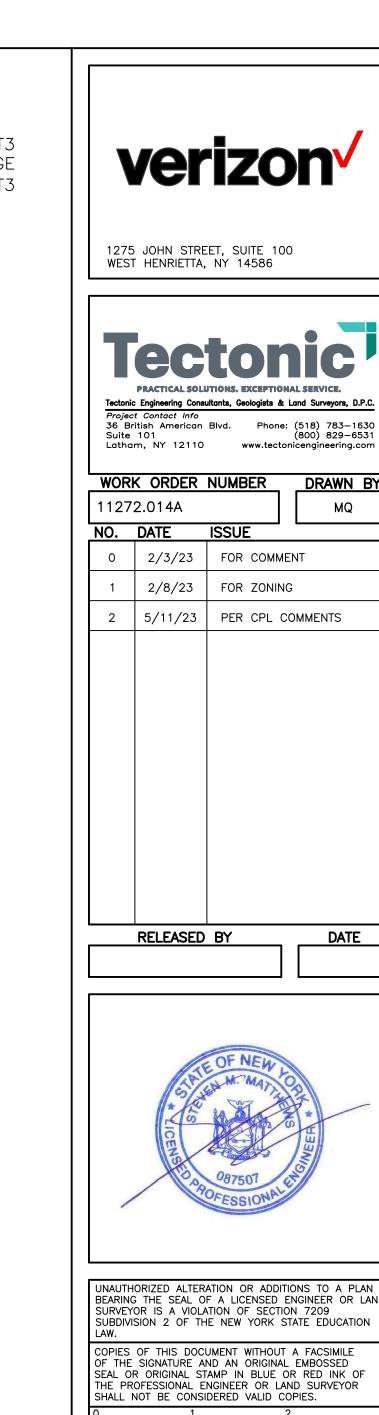
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MUSHROOM CAP

SLOTTED

DOUBLE GATE DETAIL

SCALE: 1/4" = 1'-0" (11x17 SIZE) 1/2" = 1'-0" (22x34 SIZE)



DRAWN BY

MQ

DATE

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SITE INFORMATION DIDDELL RD RE PN: 20222321233

ORIGINAL SIZE IN INCHES


LC: 706668 SITE ADDRESS

DIDDELL RD TOWN OF WAPPINGER DUTCHESS COUNTY NY 12590

SHEET TITLE

SITE DETAILS


SHEET NUMBER

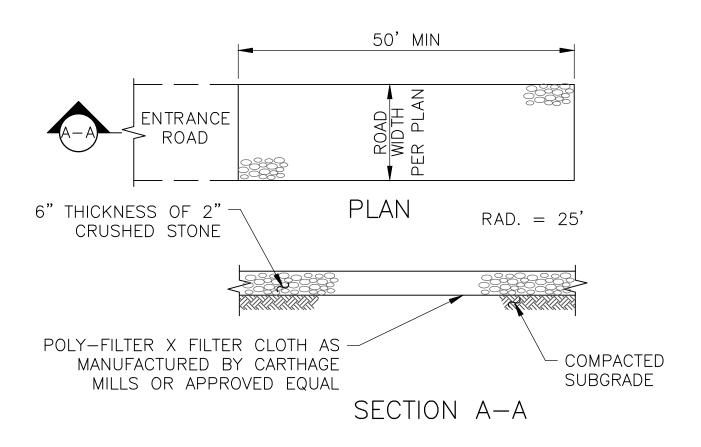

## NOTES:

- 1. STONE SIZE USE 2" STONE, OR RECLAIMED OR RECYCLED CONCRETE EQUIVALENT.
- 2. LENGTH NOT LESS THAN 50 FEET
- 3. THICKNESS NOT LESS THAN SIX INCHES
- 4. WIDTH 12 FOOT MINIMUM, BUT NOT LESS THAN THE FULL WIDTH AT POINTS WHERE INGRESS OR EGRESS OCCURS.
- 5. FILTER CLOTH WILL BE PLACED OVER THE ENTIRE AREA PRIOR TO PLACING OF STONE.
- 6. SURFACE WATER ALL SURFACE WATER FLOWING OR DIVERTED TOWARD CONSTRUCTION ENTRANCES SHALL BE PIPED ACROSS THE ENTRANCE. IF PIPING IS IMPRACTICAL A MOUNTABLE BERM WITH 5:1 SLOPES WILL BE PERMITTED.
- 7. MAINTENANCE THE ENTRANCE SHALL BE MAINTAINED IN A CONDITION WHICH SHALL PREVENT TRACKING OR FLOWING OF SEDIMENT ONTO PUBLIC RIGHTS—OF—WAY. THIS MAY REQUIRE PERIODIC TOP DRESSING WITH ADDITIONAL STONE AS CONDITIONS DEMAND AND REPAIR AND/OR CLEANOUT OF ANY MEASURES USED TO TRAP SEDIMENT. ALL SEDIMENT SPILLED, DROPPED, WASHED, OR TRACKED ONTO PUBLIC RIGHTS—OF—WAY MUST BE REMOVED IMMEDIATELY.
- 8. WASHING WHEELS SHALL BE CLEANED TO REMOVE SEDIMENT PRIOR TO ENTRANCE ONTO PUBLIC RIGHTS—OF—WAY. IF ACCUMULATED SOIL DOES NOT COME OFF BY WAY OF STABILIZED CONSTRUCTION ENTRANCE, THE CONTRACTOR SHALL KNOCK OFF ACCUMULATED SOIL BY MANUAL METHODS UPSLOPE OF A SILT FENCE BARRIER.
- 9. SEDIMENT TRAPPING SILT FENCE BARRIER SHALL BE INSTALLED DOWN SLOPE OF CONSTRUCTION ENTRANCE TO CATCH ANY SEDIMENT THAT COULD POTENTIALLY FALL OFF OF CONSTRUCTION EQUIPMENT AND/OR VEHICLES.
- 10. PERIODIC INSPECTIONS AND NEEDED MAINTENANCE SHALL BE PROVIDED AFTER EACH RAIN.


# STABILIZED CONSTRUCTION ENTRANCE SCALE: NTS

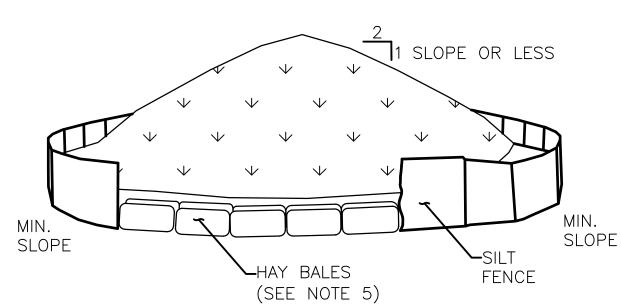

# NOTES:

- 1. AREA CHOSEN FOR STOCKPILING OPERATIONS SHALL BE DRY AND STABLE.
- 2. MAXIMUM SLOPE OF STOCKPILE SHALL BE 1V:2H.
- 3. UPON COMPLETION OF SOIL STOCKPILING, EACH PILE SHALL BE SURROUNDED WITH SILT FENCING, THEN STABILIZED WITH VEGETATION OR COVERED.
- 4. SEE SPECIFICATIONS FOR INSTALLATION OF SILT FENCE.
- 5. HAYBALES TO BE USED WHERE STOCKPILES ARE LOCATED ON PAVED AREAS.




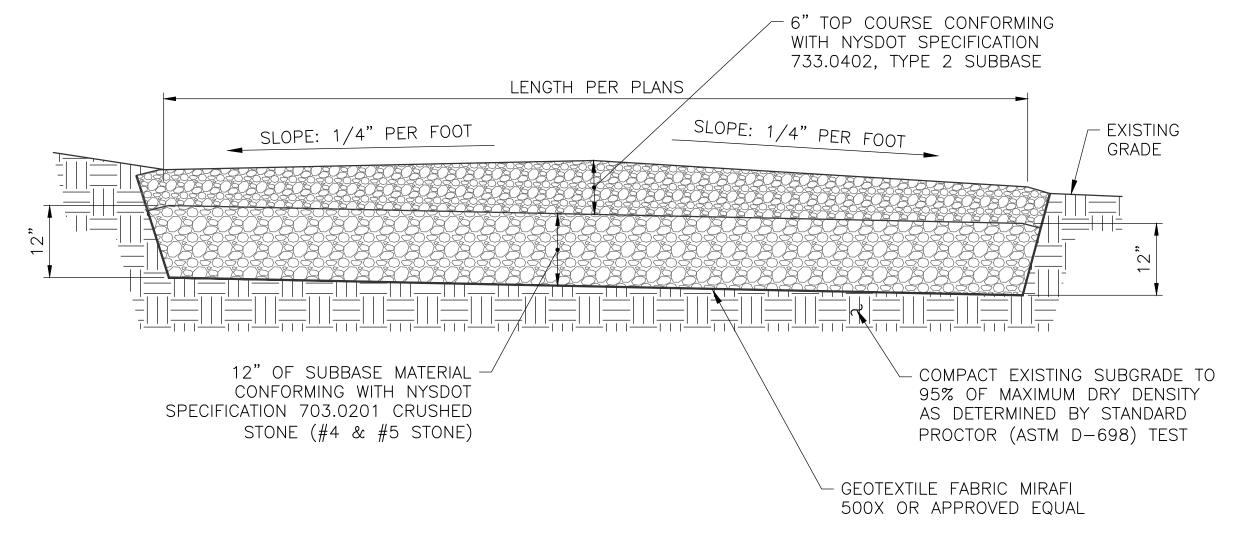

## EARTH WORK SUBGRADE COMPACTION & SELECT GRANULAR FILL

- 1. CONTRACTOR SHALL BE RESPONSIBLE FOR CLEARING & GRUBBING THE CONSTRUCTION SITE AND ROADWAY AREAS. THE CONTRACTOR SHALL COMPLY WITH THE RECOMMENDATIONS CONTAINED WITHIN THE GEOTECHNICAL REPORT, AS PREPARED FOR THIS SITE, WHEN NECESSARY, FOR SITE WORK PREPARATION, & FOUNDATION WORK. AS A MINIMUM THE TOP 3" OF GRADE SHALL BE REMOVED, THE EXPOSED SUBGRADE COMPACTED AND GEOTEXTILE FABRIC INSTALLED AS REQUIRED FOR UNSTABLE SOIL CONDITION.
- 2. ALL SELECT GRANULAR FILL SHALL BE COMPACTED TO A 95% COMPACTION AT A MAXIMUM DRY DENSITY AS DETERMINED BY MODIFIED PROCTOR TEST (ASTM D-1557) AND WITHIN PLUS OR MINUS 3% OF OPTIMUM MOISTURE CONTENT.
- 3. CONTRACTOR TO ASSURE THAT EXISTING DRAINAGE PATTERNS ARE MAINTAINED.




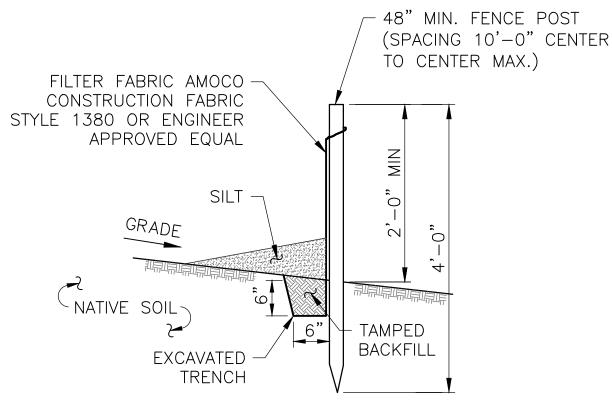

# NOTES:

- 1. SILT FENCE SHALL BE MAINTAINED IN PLACE DURING CONSTRUCTION AND SOIL STABILIZATION PERIOD.
- 2. CONTRACTOR SHALL CONSTRUCT SILT FENCE IN ACCORDANCE WITH MANUFACTURER'S REQUIREMENTS.
- 3. EXCAVATE TRENCH 6" WIDE X 6" DEEP. BURY BOTTOM 12" OF FABRIC AND TAMP IN PLACE.
- 4. WHEN FENCE IS NO LONGER NEEDED, THE ACCUMULATED SILT, ALL THE POSTS AND FABRIC SHALL BE REMOVED AND TRENCH BACK FILLED WITH TOPSOIL AND SEEDED.



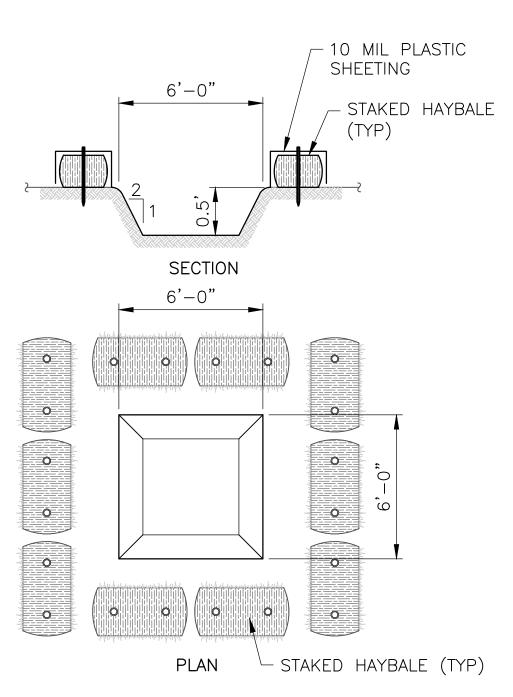





1275 JOHN STREET, SUITE 100 WEST HENRIETTA, NY 14586



	72.014A	NOWREK	DRAWN BY
NO.	DATE	ISSUE	IVIQ
0	2/3/23	FOR COMME	ENT
1	2/8/23	FOR ZONING	
2	5/11/23	PER CPL C	OMMENTS

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RELEASED BY

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0 1 2 3

ORIGINAL SIZE IN INCHES

SITE INFORMATION

DIDDELL RD

RE PN: 20222321233 LC: 706668


DIDDELL RD
TOWN OF WAPPINGER
DUTCHESS COUNTY
NY 12590


SITE DETAILS

SHEET NUMBER

SHEET TITLE

C-4B

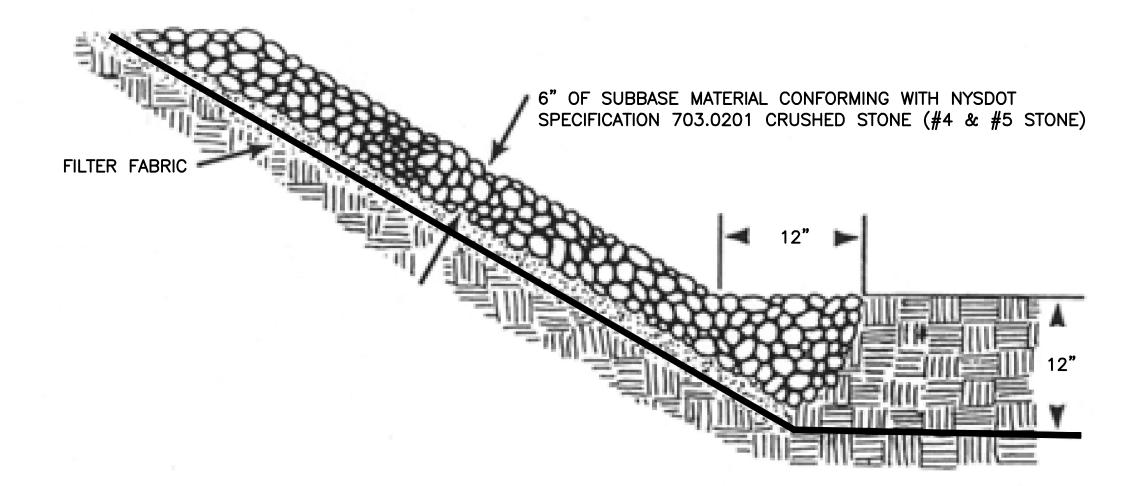

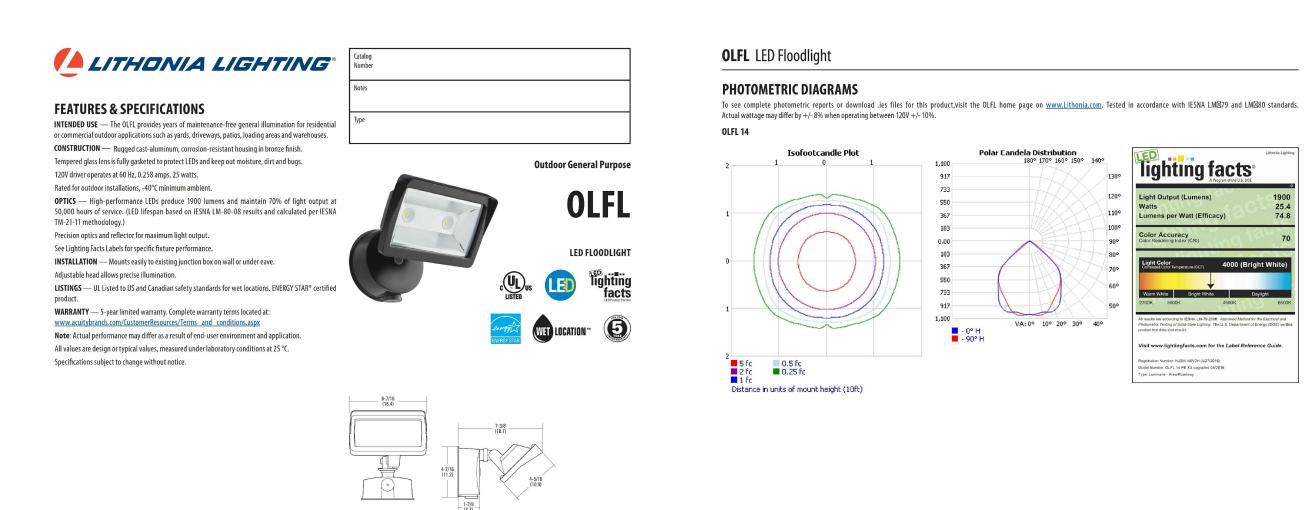

BZ Bronze

1 Nominal Correlated Color Temperature (CCT) per ANSI C78.377-2008.

OLFL 14

DECORATIVE INDOOR & OUTDOOR

OLFL 14 **A LITHONIA LIGHTING** DECORATIVE INDOOR & OUTDOOR: One Lithonia Way, Conyers, GA 30012 Phone: 800-748-5070 www.lithonia.com © 2013-2017 Acuity Brands Lighting, Inc. All rights reserved. Rev. 03/21/17

1. LIGHT SHALL ONLY BE USED BY VERIZON WIRELESS TECHNICIANS DURING EMERGENCY

2. LIGHT SHALL BE PROVIDED WITH A SHUT OFF

MAINTENANCE OPERATIONS

DIAL TIMER.

lighting facts





1275 JOHN STREET, SUITE 100 WEST HENRIETTA, NY 14586

Tectonic Engineering Consultants, Geologists & Land Surveyors, D.P.C.

Project Contact Info
36 British American Blvd. Phone: (518) 783-1630
Suite 101 (800) 829-6531

Lat	ham, NY 12110	tonicengineering.com	
WO	RK ORDER	NUMBER	DRAWN BY
112	272.014A		MQ
NO.	DATE	ISSUE	
0	2/3/23	FOR COMM	MENT
1	2/8/23	FOR ZONII	NG
2	5/11/23	PER CPL	COMMENTS

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ORIGINAL SIZE IN INCHES SITE INFORMATION

DIDDELL RD RE PN: 20222321233 LC: 706668


SITE ADDRESS


DIDDELL RD TOWN OF WAPPINGER DUTCHESS COUNTY NY 12590

SHEET TITLE

SITE DETAILS

SHEET NUMBER

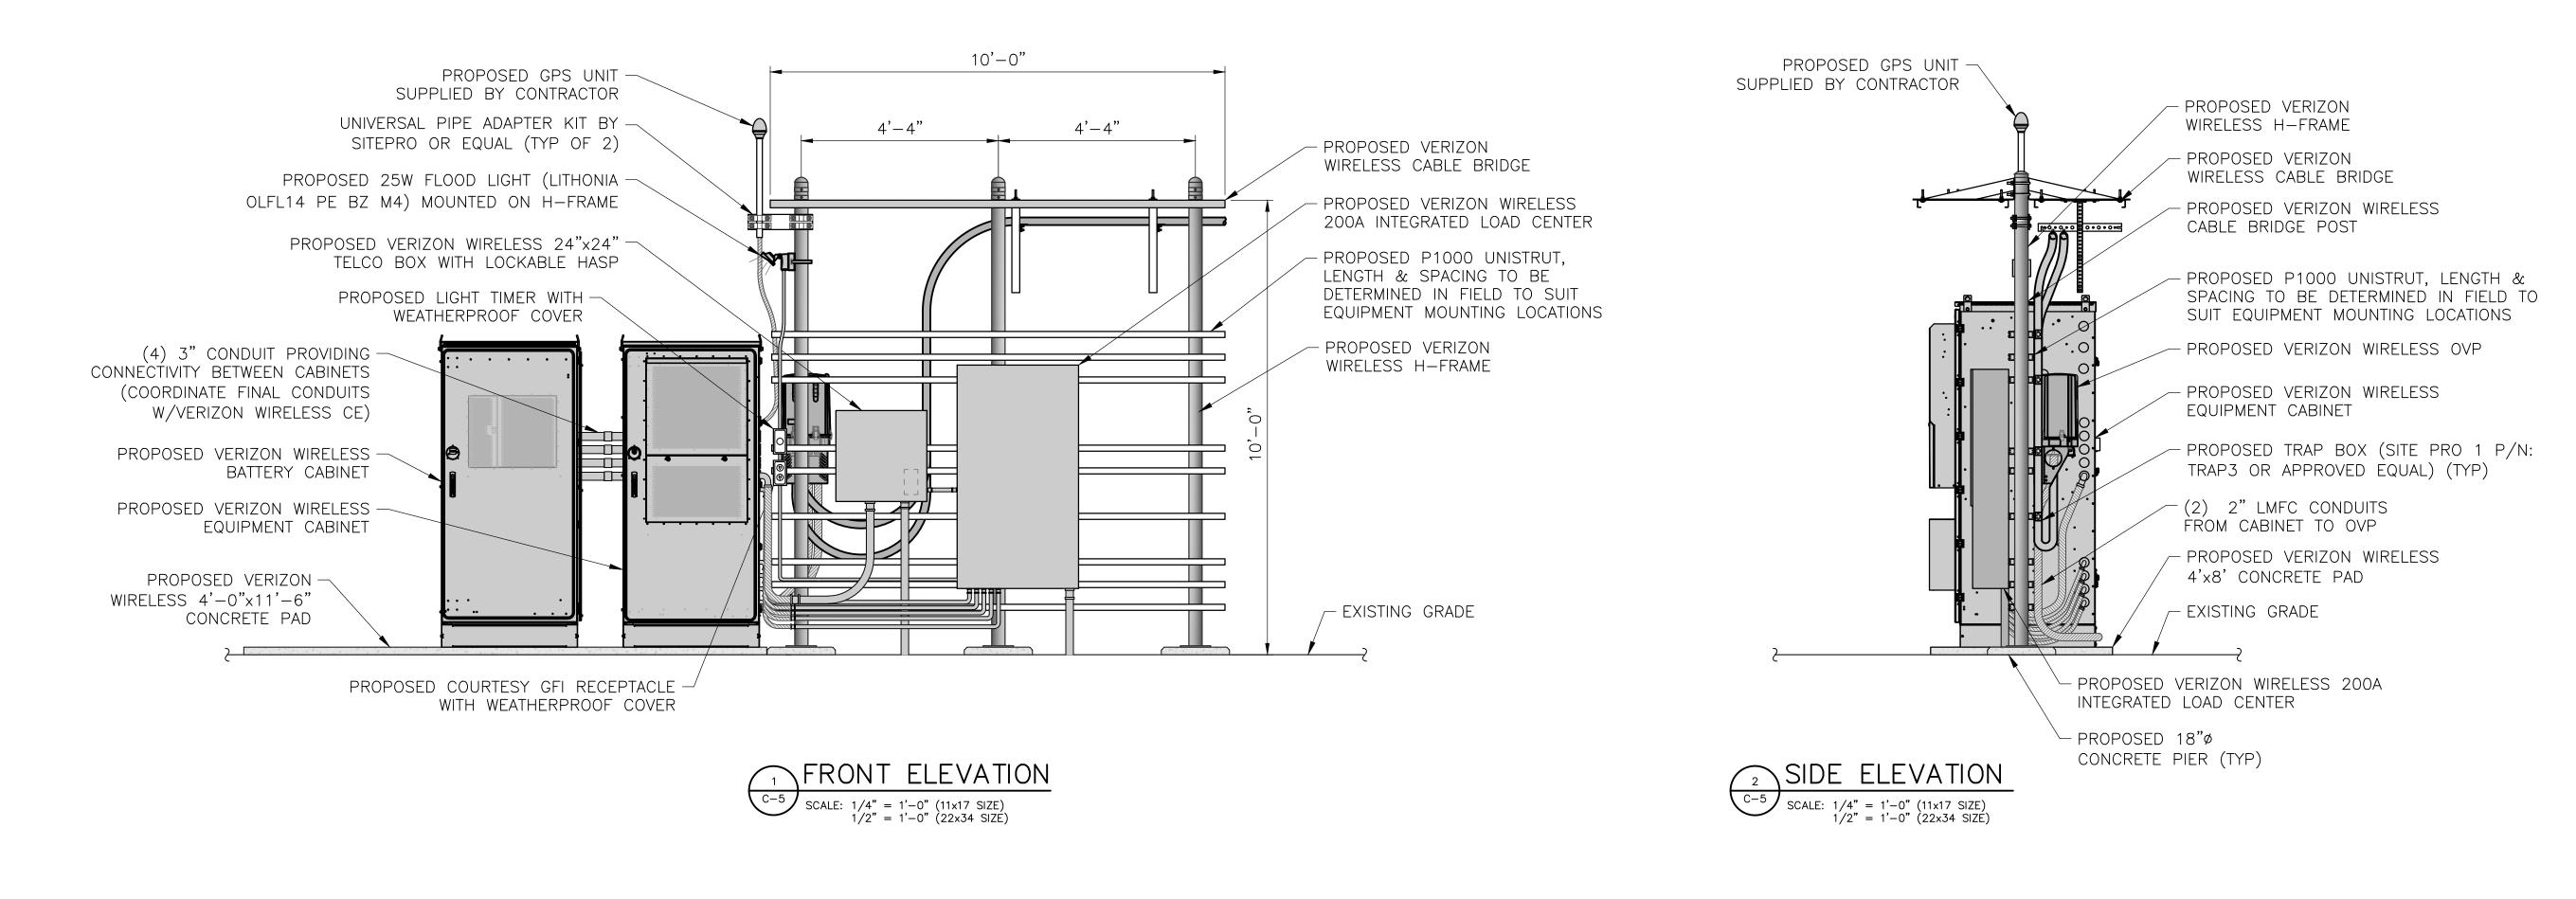

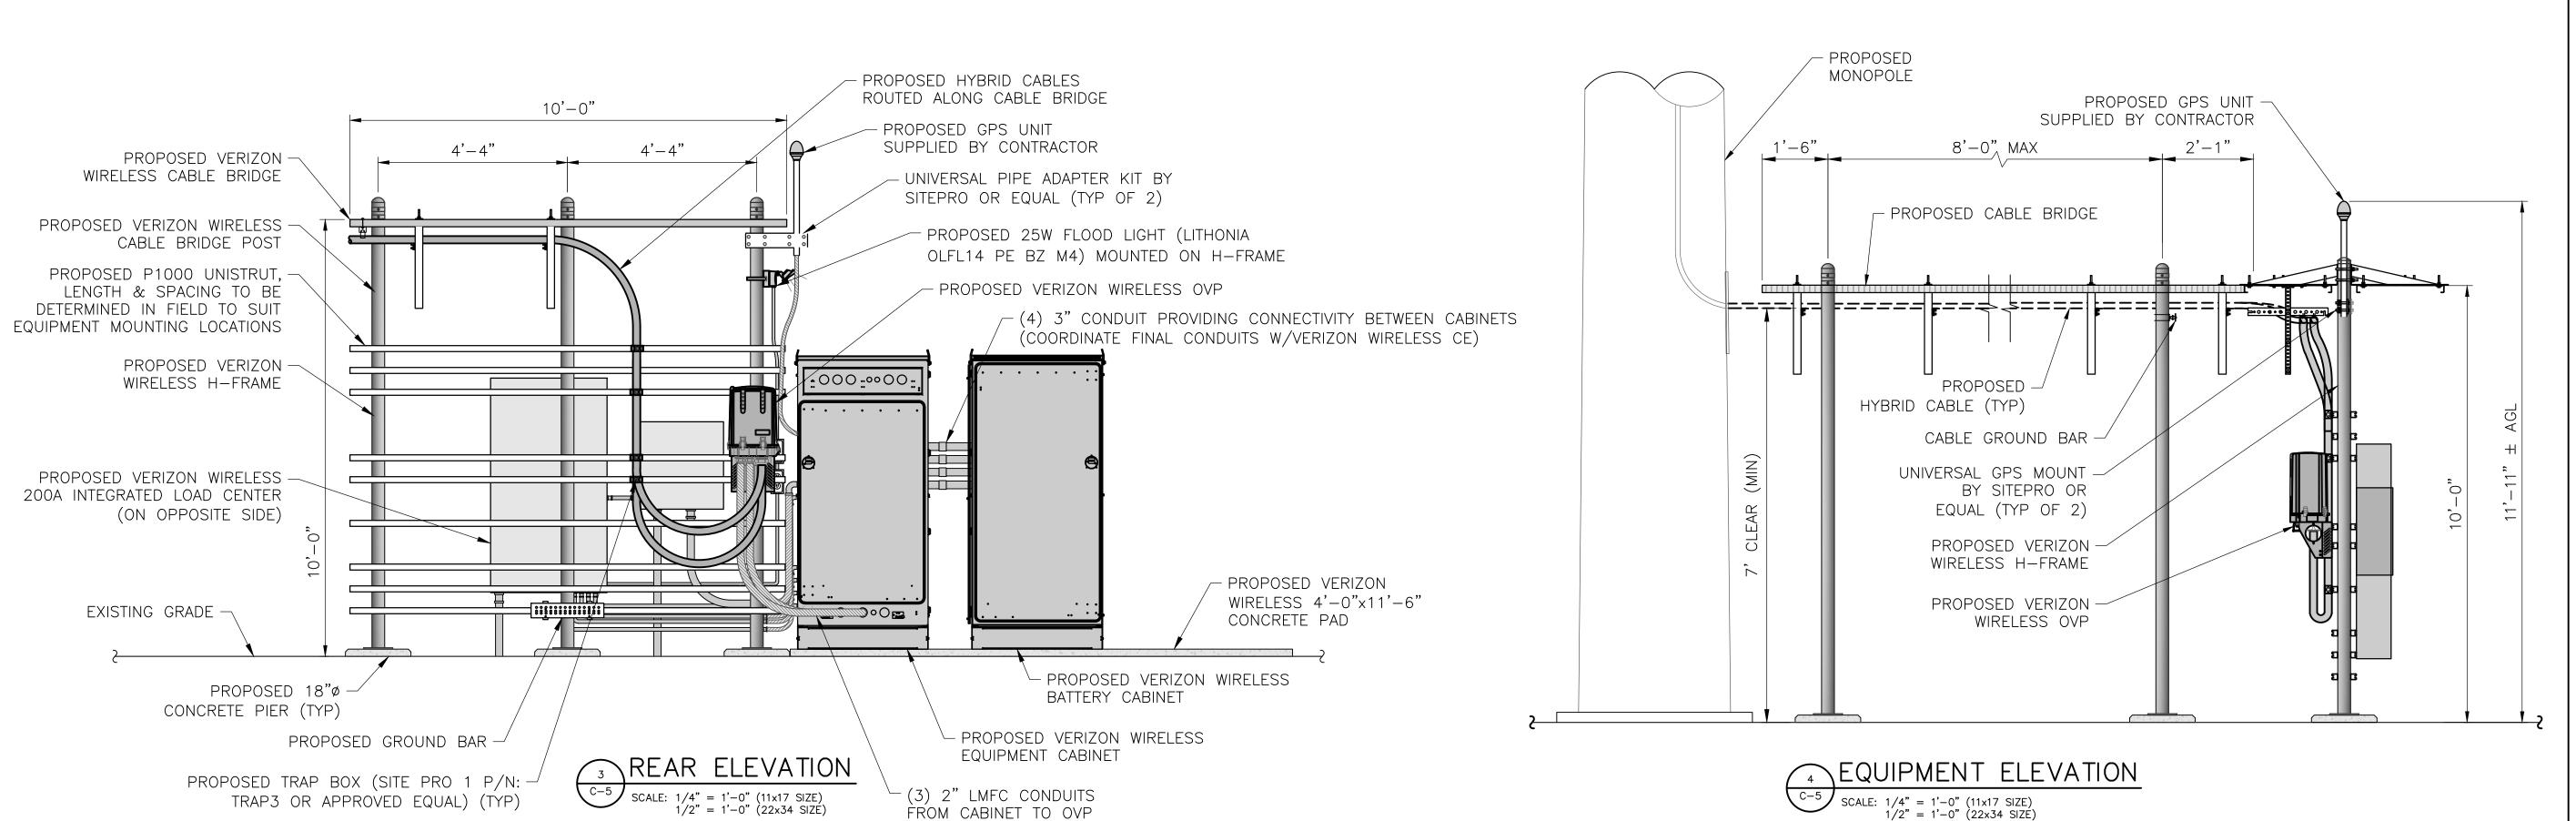



PRACTICAL SOLUTIONS. EXCEPTIONAL SERVICE.

Tectonic Engineering Consultants, Geologists & Land Surveyors, D.P.C.

Project Contact Info
36 British American Blvd. Phone: (518) 783–1630
Suite 101
Latham, NY 12110 Phone: (500) 829–6531
www.tectonicengineering.com

WORK ORDER NUMBER
1272.014A

MQ

RELEASED BY DATE



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0 1 2 3

ORIGINAL SIZE IN INCHES

SITE INFORMATION

DIDDELL RD

RE PN: 20222321233 LC: 706668

SITE ADDRESS

DIDDELL RD
TOWN OF WAPPINGER
DUTCHESS COUNTY
NY 12590

SHEET TITLE

EQUIPMENT ELEVATIONS

SHEET NUMBER

C-5

### Full Environmental Assessment Form Part 1 - Project and Setting

### **Instructions for Completing Part 1**

Part 1 is to be completed by the applicant or project sponsor. Responses become part of the application for approval or funding, are subject to public review, and may be subject to further verification.

Complete Part 1 based on information currently available. If additional research or investigation would be needed to fully respond to any item, please answer as thoroughly as possible based on current information; indicate whether missing information does not exist, or is not reasonably available to the sponsor; and, when possible, generally describe work or studies which would be necessary to update or fully develop that information.

Applicants/sponsors must complete all items in Sections A & B. In Sections C, D & E, most items contain an initial question that must be answered either "Yes" or "No". If the answer to the initial question is "Yes", complete the sub-questions that follow. If the answer to the initial question is "No", proceed to the next question. Section F allows the project sponsor to identify and attach any additional information. Section G requires the name and signature of the applicant or project sponsor to verify that the information contained in Part 1 is accurate and complete.

### A. Project and Applicant/Sponsor Information.

Name of Action or Project:			
Verizon Wireless of the East LP, d/b/a Verizon Wireless - Unmanned Wireless Communicat	ions Facility - "Diddell Rd"		
Project Location (describe, and attach a general location map):			
Diddell Road, Wappinger Falls, Dutchess County, NY 12590			
Brief Description of Proposed Action (include purpose or need):			
Verizon Wireless of the East LP, d/b/a Verizon Wireless ("Verizon Wireless" or "Applicant") communications facility located on the existing property. Said property being located on Dicthe proposed facility will originate from Diddell Rd utilizing an existing and proposed gravel of	Idell Road 0.17 miles West of		
In general, the installation will consist of the following: an 120' tall monopole (124' including to be mounted to the tower at a center-line height of 116', cellular and utility equipment at grincludes the installation of power and fiber to service the facility.			
Name of Applicant/Sponsor:	Telephone: (585) 321-54	35	
Verizon Wireless of the East LP, d/b/a Verizon Wireless	E-Mail: kathy.pomponio@verizonwireless.com		
Address: 1275 John Street, Suite 100	·		
City/PO: West Henrietta	State: NY	Zip Code: 14586	
Project Contact (if not same as sponsor; give name and title/role):	Telephone: (518) 438-99	07	
Young Sommer LLC; attn: Scott Olson, esq.	E-Mail: solson@youngso		
Address: 5 Palisades Drive			
City/PO:	State:	Zip Code:	
Albany	NY	12205	
Property Owner (if not same as sponsor):	Telephone:		
Patricia H. Meddaugh & Craig Tiedeman	E-Mail:		
Address: 79 Diddell Road	<u>'</u>		
City/PO: Wappingers Falls	State: NY	Zip Code: 12590	

### **B.** Government Approvals

B. Government Approvals, Funding, or Spon assistance.)	sorship. ("Funding" includes grants, loans, to	ax relief, and any othe	r forms of financial		
Government Entity	Government Entity  If Yes: Identify Agency and Approval(s)  Required  (Actual or				
a. City Council, Town Board, □Yes ✓No or Village Board of Trustees					
b. City, Town or Village   ✓ Yes   No Planning Board or Commission	Planning Board - Special Permit & Site Plan Review	TBD			
c. City, Town or ☐Yes ✓No Village Zoning Board of Appeals					
d. Other local agencies ✓ Yes□No	Building Department - Building Permit	TBD			
e. County agencies ☐Yes ✓ No					
f. Regional agencies Yes No					
g. State agencies ☐Yes ✓No					
h. Federal agencies ☐Yes ☑No					
<ul><li>i. Coastal Resources.</li><li>i. Is the project site within a Coastal Area, or the waterfront area of a Designated Inland Waterway?</li></ul>					
<ul><li>ii. Is the project site located in a community with an approved Local Waterfront Revitalization Program?</li><li>iii. Is the project site within a Coastal Erosion Hazard Area?</li></ul>					
C. Planning and Zoning					
C.1. Planning and zoning actions.					
<ul> <li>Will administrative or legislative adoption, or are only approval(s) which must be granted to enable.</li> <li>If Yes, complete sections C, F and G.</li> <li>If No, proceed to question C.2 and complete sections.</li> </ul>			□Yes <b>⊠</b> No		
C.2. Adopted land use plans.					
a. Do any municipally- adopted (city, town, vill where the proposed action would be located?	age or county) comprehensive land use plan(s)	) include the site	□Yes☑No		
If Yes, does the comprehensive plan include spe would be located?	ecific recommendations for the site where the p	proposed action	□Yes□No		
b. Is the site of the proposed action within any leading and Brownfield Opportunity Area (BOA); designs or other?)  If Yes, identify the plan(s):	ocal or regional special planning district (for eated State or Federal heritage area; watershed		□Yes <b>☑</b> No		
c. Is the proposed action located wholly or partion or an adopted municipal farmland protection If Yes, identify the plan(s):		pal open space plan,	□Yes ▶No		

C.3. Zoning	
a. Is the site of the proposed action located in a municipality with an adopted zoning law or ordinance.  If Yes, what is the zoning classification(s) including any applicable overlay district?  R-40/80 (One Family Residence District) & R-3A (One Family Residence District)	Yes□No
b. Is the use permitted or allowed by a special or conditional use permit?	Yes□No
c. Is a zoning change requested as part of the proposed action?  If Yes,  i. What is the proposed new zoning for the site?	Yes No
C.4. Existing community services.	
a. In what school district is the project site located? Arlington Central School District	
b. What police or other public protection forces serve the project site?  New York State Police, Dutchess County Sheriff	
c. Which fire protection and emergency medical services serve the project site?  New Hackensack Fire District, Town of Wappinger Ambulance	
d. What parks serve the project site?  Robinson Lane Park	
D. Project Details	
D.1. Proposed and Potential Development	
a. What is the general nature of the proposed action (e.g., residential, industrial, commercial, recreational; if mixed, incl components)? Unmanned wireless communication facility	lude all
b. a. Total acreage of the site of the proposed action?  b. Total acreage to be physically disturbed?  c. Total acreage (project site and any contiguous properties) owned or controlled by the applicant or project sponsor?  54.77 acres  0.44 acres  0.23 acres	
i. If Yes, what is the approximate percentage of the proposed expansion and identify the units (e.g., acres, miles, house	Yes No No sing units,
	]Yes <b>⊉</b> No
<ul> <li>ii. Is a cluster/conservation layout proposed?</li> <li>iii. Number of lots proposed?</li> <li>iv. Minimum and maximum proposed lot sizes? Minimum</li> <li>Maximum</li> </ul>	]Yes □No
	Yes ✓ No  one phase may

	t include new resid				□Yes <b>☑</b> No
If Yes, show num	bers of units propo One Family	sed. <u>Two Family</u>	Three Family	Multiple Family (four or more)	
Initial Phase	One rann,	1 110 1 mmj	111100 1 111111	maniple running from or more,	
At completion					
of all phases					
- 11	1 21 . 1 1 . 1 .				CAN CAL
g. Does the propo	osed action include	new non-residentia	ll construction (inclu	iding expansions)?	<b>∠</b> Yes <b>N</b> o
i. Total number	of structures 1	(tower)			
ii. Dimensions (	in feet) of largest pr	roposed structure:	124'_height;	5' width; and length	
iii. Approximate	extent of building s	space to be heated	or cooled:	0 square feet	
h. Does the propo	sed action include	construction or oth	er activities that wil	l result in the impoundment of any	□Yes☑No
	s creation of a water	r supply, reservoir,	pond, lake, waste la	agoon or other storage?	
If Yes, <i>i</i> . Purpose of the	imnoundment:				
ii. If a water imp	oundment, the princ	cipal source of the	water:	☐ Ground water ☐ Surface water stream	ms Other specify:
<i>iii</i> . If other than w	vater, identify the ty	pe of impounded/o	contained liquids and	d their source.	
iv. Approximate	size of the proposed	d impoundment.	Volume:	million gallons; surface area:	acres
v. Dimensions o	f the proposed dam	or impounding str	ucture:	height; length	40102
vi. Construction	method/materials f	or the proposed da	m or impounding st	ructure (e.g., earth fill, rock, wood, cond	crete):
D.2. Project Ope	orations				
, ,			' duadaina d	·	Tsza ZNia
				uring construction, operations, or both? or foundations where all excavated	☐Yes ✓ No
materials will r		mon, grading or in	stananon or annaes	of foundations where an excavated	
If Yes:	,				
<i>i</i> .What is the pu	rpose of the excava	ition or dredging?			
ii. How much ma	terial (including roo	ck, earth, sediments	s, etc.) is proposed t	o be removed from the site?	
Volume     Over when	(specify tons or cut	oic yards):			
Over wh     iii. Describe natur	at duration of times	? es of materials to b	e excavated or dreds	ged, and plans to use, manage or dispos	e of them
	onsite dewatering				□Yes□No
If yes, descri	be				
v. What is the to	tal area to be dredg	ed or excavated?		acres	
vi. What is the m	aximum area to be	worked at any one	time?	acres	
vii. What would b	e the maximum de	pth of excavation of	or dredging?	feet	
	vation require blast				□Yes□No
-					
b Would the pror	posed action cause o	or result in alteration	on of increase or de	crease in size of, or encroachment	☐ Yes <b>/</b> No
			ch or adjacent area?		1000110
If Yes:		•	•		
				water index number, wetland map numb	er or geographic
description):					

ii. Describe how the proposed action would affect that waterbody or wetland, e.g. excavation, fill, placer alteration of channels, banks and shorelines. Indicate extent of activities, alterations and additions in sq	
iii. Will the proposed action cause or result in disturbance to bottom sediments?  If Yes, describe:	☐Yes ☐No
iv. Will the proposed action cause or result in the destruction or removal of aquatic vegetation?	□Yes□No
If Yes:	
<ul> <li>acres of aquatic vegetation proposed to be removed:</li> <li>expected acreage of aquatic vegetation remaining after project completion:</li> </ul>	
purpose of proposed removal (e.g. beach clearing, invasive species control, boat access):	
• proposed method of plant removal:	
if chemical/herbicide treatment will be used, specify product(s):  v. Describe any proposed reclamation/mitigation following disturbance:	
v. Describe any proposed reciamation/integration following distarbance.	
c. Will the proposed action use, or create a new demand for water?	□Yes <b>∠</b> No
If Yes:	
i. Total anticipated water usage/demand per day: gallons/day	
ii. Will the proposed action obtain water from an existing public water supply?	□Yes □No
<ul><li>If Yes:</li><li>Name of district or service area:</li></ul>	
<ul> <li>Name of district or service area:</li> <li>Does the existing public water supply have capacity to serve the proposal?</li> </ul>	☐ Yes ☐ No
<ul> <li>Is the project site in the existing district?</li> </ul>	☐ Yes ☐ No
<ul> <li>Is expansion of the district needed?</li> </ul>	☐ Yes☐ No
<ul> <li>Do existing lines serve the project site?</li> </ul>	☐ Yes☐ No
iii. Will line extension within an existing district be necessary to supply the project? If Yes:	□Yes □No
Describe extensions or capacity expansions proposed to serve this project:	
Source(s) of supply for the district:	
<i>iv.</i> Is a new water supply district or service area proposed to be formed to serve the project site? If, Yes:	☐ Yes☐No
Applicant/sponsor for new district:	
Date application submitted or anticipated:	
Proposed source(s) of supply for new district:	
v. If a public water supply will not be used, describe plans to provide water supply for the project:	
vi. If water supply will be from wells (public or private), what is the maximum pumping capacity:	_ gallons/minute.
d. Will the proposed action generate liquid wastes?	☐ Yes <b>☑</b> No
If Yes:	
i. Total anticipated liquid waste generation per day: gallons/day	
<i>ii.</i> Nature of liquid wastes to be generated (e.g., sanitary wastewater, industrial; if combination, describe a approximate volumes or proportions of each):	
<ul><li>iii. Will the proposed action use any existing public wastewater treatment facilities?</li><li>If Yes:</li></ul>	□Yes□No
Name of wastewater treatment plant to be used:	
Name of district:    Continue	
<ul> <li>Does the existing wastewater treatment plant have capacity to serve the project?</li> <li>Is the project site in the existing district?</li> </ul>	□Yes□No □Yes□No
<ul><li>Is the project site in the existing district?</li><li>Is expansion of the district needed?</li></ul>	☐ Yes ☐No

<ul> <li>Do existing sewer lines serve the project site?</li> </ul>	□Yes□No
Will a line extension within an existing district be necessary to serve the project?	☐Yes ☐No
If Yes:	
Describe extensions or capacity expansions proposed to serve this project:	
<i>iv.</i> Will a new wastewater (sewage) treatment district be formed to serve the project site?	□Yes□No
If Yes:	
Applicant/sponsor for new district:	
Date application submitted or anticipated:	
What is the receiving water for the wastewater discharge?	_
v. If public facilities will not be used, describe plans to provide wastewater treatment for the project, including spec	ifying proposed
receiving water (name and classification if surface discharge or describe subsurface disposal plans):	
vi. Describe any plans or designs to capture, recycle or reuse liquid waste:	
e. Will the proposed action disturb more than one acre and create stormwater runoff, either from new point	□Yes <b>☑</b> No
sources (i.e. ditches, pipes, swales, curbs, gutters or other concentrated flows of stormwater) or non-point	
source (i.e. sheet flow) during construction or post construction?	
If Yes:  i. How much impervious surface will the project create in relation to total size of project parcel?	
Square feet or acres (impervious surface)	
Square feet or acres (impervious surface) Square feet or acres (parcel size)	
ii. Describe types of new point sources.	
iii. Where will the stormwater runoff be directed (i.e. on-site stormwater management facility/structures, adjacent p	roperties,
groundwater, on-site surface water or off-site surface waters)?	
If to surface waters, identify receiving water bodies or wetlands:	
WWW.	
• Will stormwater runoff flow to adjacent properties? <i>iv.</i> Does the proposed plan minimize impervious surfaces, use pervious materials or collect and re-use stormwater?	□Yes□No
f. Does the proposed action include, or will it use on-site, one or more sources of air emissions, including fuel	<b>∠</b> Yes □No
combustion, waste incineration, or other processes or operations?  If Yes, identify:	
<i>i.</i> Mobile sources during project operations (e.g., heavy equipment, fleet or delivery vehicles)	
Construction equipment	
<i>ii.</i> Stationary sources during construction (e.g., power generation, structural heating, batch plant, crushers)	
N/A	
iii. Stationary sources during operations (e.g., process emissions, large boilers, electric generation)	
N/A	
g. Will any air emission sources named in D.2.f (above), require a NY State Air Registration, Air Facility Permit,	□Yes <b>☑</b> No
or Federal Clean Air Act Title IV or Title V Permit?	
If Yes:	
<i>i.</i> Is the project site located in an Air quality non-attainment area? (Area routinely or periodically fails to meet ambient air quality standards for all or some parts of the year)	□Yes□No
ii. In addition to emissions as calculated in the application, the project will generate:	
• Tons/year (short tons) of Carbon Dioxide (CO <sub>2</sub> )	
• Tons/year (short tons) of Carbon Bloxide (CO <sub>2</sub> ) • Tons/year (short tons) of Nitrous Oxide (N <sub>2</sub> O)	
• Tons/year (short tons) of Perfluorocarbons (PFCs)	
•Tons/year (short tons) of Fernitorocarbons (FFCs) •Tons/year (short tons) of Sulfur Hexafluoride (SF <sub>6</sub> )	
• Tons/year (short tons) of Carbon Dioxide equivalent of Hydroflourocarbons (HFCs)	
Tons/year (short tons) of Carbon Bloade equivalent of Hydronourocarbons (III es)     Tons/year (short tons) of Hazardous Air Pollutants (HAPs)	

h. Will the proposed action generate or emit methane (including, but not limited to, sewage treatment plants, landfills, composting facilities)?  If Yes:  i. Estimate methane generation in tons/year (metric):  ii. Describe any methane capture, control or elimination measures included in project design (e.g., combustion to generate heat or electricity, flaring):		
Will the proposed action result in the release of air pollutar quarry or landfill operations?  If Yes: Describe operations and nature of emissions (e.g., describe)		□Yes☑No
<ul> <li>j. Will the proposed action result in a substantial increase in new demand for transportation facilities or services?</li> <li>If Yes: <ul> <li>i. When is the peak traffic expected (Check all that apply)</li> <li>Randomly between hours of</li></ul></li></ul>	): ☐ Morning ☐ Evening ☐ Weekend	Yes <b>_</b> No s):
<ul> <li>iii. Parking spaces: Existing</li></ul>	isting roads, creation of new roads or change in existing available within ½ mile of the proposed site? portation or accommodations for use of hybrid, electric	□Yes□No
k. Will the proposed action (for commercial or industrial projects only) generate new or additional demand for energy?  If Yes:  i. Estimate annual electricity demand during operation of the proposed action:  Minimal increase in electrical power usage as necessary to operate the facility.  ii. Anticipated sources/suppliers of electricity for the project (e.g., on-site combustion, on-site renewable, via grid/local utility, or other):  Local utility  iii. Will the proposed action require a new, or an upgrade, to an existing substation?   □Yes No		
<ul> <li>l. Hours of operation. Answer all items which apply.</li> <li>i. During Construction: <ul> <li>Monday - Friday:</li> <li>Saturday:</li> <li>Sunday:</li> <li>Holidays:</li> </ul> </li> </ul>	<ul> <li>ii. During Operations:</li> <li>Monday - Friday:</li> <li>Saturday:</li> <li>Sunday:</li> <li>Holidays:</li> <li>24 hours</li> <li>24 hours</li> <li>24 hours</li> </ul>	

<ul> <li>m. Will the proposed action produce noise that will exceed existing ambient noise levels during construction, operation, or both?</li> <li>If yes: <ul> <li>i. Provide details including sources, time of day and duration:</li> <li>During construction, noise associated with the operation of construction equipment</li> </ul> </li> </ul>	✓ Yes □No
<ul> <li>ii. Will the proposed action remove existing natural barriers that could act as a noise barrier or screen?</li> <li>Describe:</li></ul>	☐ Yes <b>☑</b> No
<ul> <li>n. Will the proposed action have outdoor lighting?</li> <li>If yes:</li> <li>i. Describe source(s), location(s), height of fixture(s), direction/aim, and proximity to nearest occupied structures:</li> <li>One (1) switch operated LED light fixture attached to the h-frame at grade, designed to illuminate the area in and around the Verina</li> </ul>	✓ Yes ☐ No
ii. Will proposed action remove existing natural barriers that could act as a light barrier or screen? Describe:	☐ Yes <b>☑</b> No
o. Does the proposed action have the potential to produce odors for more than one hour per day?  If Yes, describe possible sources, potential frequency and duration of odor emissions, and proximity to nearest occupied structures:	☐ Yes ☑ No
p. Will the proposed action include any bulk storage of petroleum (combined capacity of over 1,100 gallons) or chemical products 185 gallons in above ground storage or any amount in underground storage?  If Yes:  i. Product(s) to be stored  ii. Volume(s) per unit time (e.g., month, year)  iii. Generally, describe the proposed storage facilities:	☐ Yes ☑ No
<ul> <li>q. Will the proposed action (commercial, industrial and recreational projects only) use pesticides (i.e., herbicides, insecticides) during construction or operation?</li> <li>If Yes: <ul> <li>i. Describe proposed treatment(s):</li> </ul> </li> </ul>	☐ Yes ☑No
<ul> <li>ii. Will the proposed action use Integrated Pest Management Practices?</li> <li>r. Will the proposed action (commercial or industrial projects only) involve or require the management or disposal of solid waste (excluding hazardous materials)?</li> <li>If Yes: <ul> <li>i. Describe any solid waste(s) to be generated during construction or operation of the facility:</li> <li>Construction:</li> <li>tons per</li> <li>(unit of time)</li> </ul> </li> <li>Operation:</li> <li>tons per</li> <li>(unit of time)</li> </ul>	☐ Yes ☐No ☐ Yes ☑No
<ul> <li>ii. Describe any proposals for on-site minimization, recycling or reuse of materials to avoid disposal as solid waste:</li> <li>Construction:</li> <li>Operation:</li> </ul>	
<ul> <li>iii. Proposed disposal methods/facilities for solid waste generated on-site:</li> <li>Construction:</li> <li>Operation:</li> </ul>	

s. Does the proposed action include construction or modification of a solid waste management facility?  If Yes:  i. Type of management or handling of waste proposed for the site (e.g., recycling or transfer station, composting, landfill, or			☐ Yes ☑ No
other disposal activities):	for the site (e.g., recycling		5, 141141111, 01
ii. Anticipated rate of disposal/processing:			
• Tons/month, if transfer or other non-c		ent, or	
• Tons/hour, if combustion or thermal t iii. If landfill, anticipated site life:			
		. 1' 1 C1 1	
t. Will the proposed action at the site involve the commer waste?	cial generation, treatment,	storage, or disposal of hazard	ous [] Yes [ No
If Yes:			
i. Name(s) of all hazardous wastes or constituents to be	generated, handled or mar	naged at facility:	
ii. Generally describe processes or activities involving h	azardous wastes or constitu	uents:	
iii. Specify amount to be handled or generated to	ns/month		
iv. Describe any proposals for on-site minimization, recy		is constituents:	
v. Will any hazardous wastes be disposed at an existing	offsite hazardous waste fa	cility?	□Yes□No
If Yes: provide name and location of facility:			
ICN			
If No: describe proposed management of any hazardous v	vastes which will not be se	ent to a nazardous waste facilit	y:
E. Site and Setting of Proposed Action			
E.1. Land uses on and surrounding the project site			
a. Existing land uses.			
i. Check all uses that occur on, adjoining and near the		1/ 0 )	
<ul><li>□ Urban</li><li>□ Industrial</li><li>□ Commercial</li><li>☑ Residence</li><li>☑ Forest</li><li>□ Agriculture</li><li>□ Aquatic</li><li>□ Other</li></ul>	ential (suburban) 🛮 💆 Ru (specify):	ral (non-farm)	
ii. If mix of uses, generally describe:	(specify).		
b. Land uses and covertypes on the project site.			
Land use or	Current	Acreage After	Change
Covertype	Acreage	Project Completion	(Acres +/-)
Roads, buildings, and other paved or impervious surfaces	13.46	13.66	+0.20
• Forested	22.51	22.29	-0.22
Meadows, grasslands or brushlands (non-			
agricultural, including abandoned agricultural)	18.52	18.51	-0.01
Agricultural			
(includes active orchards, field, greenhouse etc.)			
• Surface water features (lakes, ponds, streams, rivers, etc.)	0.28	0.28	0.0
Wetlands (freshwater or tidal)			
Non-vegetated (bare rock, earth or fill)			
, , , ,			
• Other Describe:			
Describe.			

c. Is the project site presently used by members of the community for public recreation?  i. If Yes: explain:	□Yes☑No
d. Are there any facilities serving children, the elderly, people with disabilities (e.g., schools, hospitals, licensed day care centers, or group homes) within 1500 feet of the project site?  If Yes,  i. Identify Facilities:	∐Yes <b>Z</b> No
e. Does the project site contain an existing dam?	☐ Yes ✓ No
If Yes:	I CSP_INO
i. Dimensions of the dam and impoundment:	
• Dam height: feet	
<ul> <li>Dam length: <ul> <li>Surface area:</li> <li>feet</li> <li>acres</li> </ul> </li> </ul>	
<ul><li>Surface area: acres</li><li>Volume impounded: gallons OR acre-feet</li></ul>	
ii. Dam's existing hazard classification:	
iii. Provide date and summarize results of last inspection:	
f. Has the project site ever been used as a municipal, commercial or industrial solid waste management facility,	□Yes☑No
or does the project site adjoin property which is now, or was at one time, used as a solid waste management facility,	
If Yes:	•
i. Has the facility been formally closed?	□Yes□ No
If yes, cite sources/documentation:	
ii. Describe the location of the project site relative to the boundaries of the solid waste management facility:	
iii. Describe any development constraints due to the prior solid waste activities:	
g. Have hazardous wastes been generated, treated and/or disposed of at the site, or does the project site adjoin property which is now or was at one time used to commercially treat, store and/or dispose of hazardous waste? If Yes:	☐Yes ✓ No
i. Describe waste(s) handled and waste management activities, including approximate time when activities occurr	ed:
h. Potential contamination history. Has there been a reported spill at the proposed project site, or have any	☐Yes <b>☑</b> No
remedial actions been conducted at or adjacent to the proposed site?	<u> </u>
If Yes:	
<i>i.</i> Is any portion of the site listed on the NYSDEC Spills Incidents database or Environmental Site Remediation database? Check all that apply:	□Yes□No
☐ Yes – Spills Incidents database       Provide DEC ID number(s):         ☐ Yes – Environmental Site Remediation database       Provide DEC ID number(s):	
Neither database	
ii. If site has been subject of RCRA corrective activities, describe control measures:	
<i>iii.</i> Is the project within 2000 feet of any site in the NYSDEC Environmental Site Remediation database? If yes, provide DEC ID number(s):	□Yes□No
iv. If yes to (i), (ii) or (iii) above, describe current status of site(s):	

	v. Is the project site subject to an institutional control limiting property uses?		
• If yes, DEC site ID number:			
Describe the type of institutional control (e.g.)	g., deed restriction or easement): _		
Describe any use limitations:			
<ul><li>Describe any engineering controls:</li><li>Will the project affect the institutional or engineering</li></ul>	gineering controls in place?		□Yes□No
Explain:			
- Explain.			
E.2. Natural Resources On or Near Project Site			
a. What is the average depth to bedrock on the project	site?	+7 feet	
b. Are there bedrock outcroppings on the project site?			☐ Yes ✓ No
If Yes, what proportion of the site is comprised of bed	lrock outcroppings?		
c. Predominant soil type(s) present on project site:	DwB	72.2 %	
Jr (c) r	DwC	24.6 %	
	Ca		
d. What is the average depth to the water table on the	project site? Average:+7	feet	
e. Drainage status of project site soils: Well Draine	d: 100 % of site		
☐ Moderately			
☐ Poorly Drain	ned% of site		
f. Approximate proportion of proposed action site with	h slopes: 🗹 0-10%:	90 % of site	
	<b>1</b> 0-15%:	<u>10</u> % of site	
	☐ 15% or greater:	% of site	
g. Are there any unique geologic features on the proje	ct site?		□Yes <b>☑</b> No
If Yes, describe:			
h. Surface water features.			
i. Does any portion of the project site contain wetland	ds or other waterbodies (including s	streams, rivers,	□Yes <b>☑</b> No
<i>i.</i> Does any portion of the project site contain wetland ponds or lakes)?	· -	streams, rivers,	
<ul><li>i. Does any portion of the project site contain wetland ponds or lakes)?</li><li>ii. Do any wetlands or other waterbodies adjoin the project site contain wetlands.</li></ul>	· -	streams, rivers,	□Yes <b>☑</b> No <b>☑</b> Yes□No
<ul><li>i. Does any portion of the project site contain wetland ponds or lakes)?</li><li>ii. Do any wetlands or other waterbodies adjoin the profession of the project site contain wetlands.</li><li>ii. The project site contains wetlands or lakes)?</li><li>iii. The project site contains wetlands or lakes and lakes are lakes and lakes are lakes and lakes are lakes are lakes and lakes are lakes ar</li></ul>	roject site?		<b>∠</b> Yes No
<ul> <li>i. Does any portion of the project site contain wetland ponds or lakes)?</li> <li>ii. Do any wetlands or other waterbodies adjoin the profession of the project site contains adjoin the project site contains wetlands or saterbodies adjoin the project site contains wetlands and project site site site site site site site sit</li></ul>	roject site?		
<ul> <li>i. Does any portion of the project site contain wetland ponds or lakes)?</li> <li>ii. Do any wetlands or other waterbodies adjoin the proof of the state of the project site contains and the project site contains adjoin the project site.</li> <li>iii. Are any of the wetlands or waterbodies within or a state or local agency?</li> </ul>	roject site? adjoining the project site regulated l	by any federal,	<b>∠</b> Yes No
<ul> <li>i. Does any portion of the project site contain wetland ponds or lakes)?</li> <li>ii. Do any wetlands or other waterbodies adjoin the proof of the properties.</li> <li>iii. Are any of the wetlands or waterbodies within or a state or local agency?</li> <li>iv. For each identified regulated wetland and waterbodies.</li> </ul>	roject site?  adjoining the project site regulated by on the project site, provide the fo	by any federal,	<b>∠</b> Yes No
<ul> <li>i. Does any portion of the project site contain wetland ponds or lakes)?</li> <li>ii. Do any wetlands or other waterbodies adjoin the profession of the project site of the project site. If No, skip to E.2.i.</li> <li>iii. Are any of the wetlands or waterbodies within or a state or local agency?</li> <li>iv. For each identified regulated wetland and waterboom of Streams: Name</li> </ul>	roject site? adjoining the project site regulated l	by any federal, ollowing information: Classification	<b>∠</b> Yes□No
<ul> <li>i. Does any portion of the project site contain wetland ponds or lakes)?</li> <li>ii. Do any wetlands or other waterbodies adjoin the project site contains wetlands or other waterbodies adjoin the project site.</li> <li>iii. Are any of the wetlands or waterbodies within or a state or local agency?</li> <li>iv. For each identified regulated wetland and waterboom of the wetlands:</li> <li>Name of the wetlands:</li> <li>Name of the wetlands or waterbodies within or a state or local agency?</li> <li>iv. For each identified regulated wetland and waterboom of the wetlands:</li> <li>Name of the wetlands or waterbodies within or a state or local agency?</li> <li>iv. For each identified regulated wetland and waterboom of the wetlands:</li> <li>Name of the wetlands or waterbodies within or a state or local agency?</li> <li>iv. For each identified regulated wetland and waterboom of the wetlands:</li> <li>Name of the wetlands or waterbodies within or a state or local agency?</li> <li>iv. For each identified regulated wetland and waterboom of the wetlands:</li> <li>Name of the wetlands or waterbodies within or a state or local agency?</li> <li>iv. For each identified regulated wetland and waterboom of the wetlands or waterbodies within or a state or local agency?</li> </ul>	roject site? adjoining the project site regulated l dy on the project site, provide the fo	by any federal, ollowing information: Classification	<b>∠</b> Yes□No
<ul> <li>i. Does any portion of the project site contain wetland ponds or lakes)?</li> <li>ii. Do any wetlands or other waterbodies adjoin the project site contain wetlands or other waterbodies adjoin the project site.</li> <li>iii. Are any of the wetlands or waterbodies within or a state or local agency?</li> <li>iv. For each identified regulated wetland and waterboom streams:  Name  Lakes or Ponds:  Wetlands:  Name  Wetland No. (if regulated by DEC)</li> </ul>	roject site? adjoining the project site regulated l dy on the project site, provide the fo	by any federal,  collowing information:  Classification  Classification  Approximate Size	✓Yes□No ✓Yes□No
<ul> <li>i. Does any portion of the project site contain wetland ponds or lakes)?</li> <li>ii. Do any wetlands or other waterbodies adjoin the project site contain wetlands or lakes)?</li> <li>iii. Are any of the wetlands or waterbodies within or a state or local agency?</li> <li>iv. For each identified regulated wetland and waterbooks are streams:  Name  Lakes or Ponds: Name  Wetlands: Name  Wetland No. (if regulated by DEC)  v. Are any of the above water bodies listed in the most</li> </ul>	roject site? adjoining the project site regulated l dy on the project site, provide the fo	by any federal,  collowing information:  Classification  Classification  Approximate Size	<b>∠</b> Yes□No
<ul> <li>i. Does any portion of the project site contain wetland ponds or lakes)?</li> <li>ii. Do any wetlands or other waterbodies adjoin the project site contain wetlands or lakes)?</li> <li>iii. Are any of the wetlands or waterbodies within or a state or local agency?</li> <li>iv. For each identified regulated wetland and waterbooms.</li> <li>Streams: Name</li> <li>Lakes or Ponds: Name</li> <li>Wetlands: Name</li> <li>Wetland No. (if regulated by DEC)</li> <li>v. Are any of the above water bodies listed in the most waterbodies?</li> </ul>	roject site?  adjoining the project site regulated by on the project site, provide the foundation of NYS water	by any federal,  collowing information:  Classification  Classification  PUBHX  Approximate Size  quality-impaired	✓Yes□No ✓Yes□No □Yes□No
<ul> <li>i. Does any portion of the project site contain wetland ponds or lakes)?</li> <li>ii. Do any wetlands or other waterbodies adjoin the project site contain wetlands or lakes)?</li> <li>iii. Are any of the wetlands or waterbodies within or a state or local agency?</li> <li>iv. For each identified regulated wetland and waterbooks are streams:  Name  Lakes or Ponds: Name  Wetlands: Name  Wetland No. (if regulated by DEC)  v. Are any of the above water bodies listed in the most</li> </ul>	roject site?  adjoining the project site regulated by on the project site, provide the foundation of NYS water	by any federal,  collowing information:  Classification  Classification  PUBHX  Approximate Size  quality-impaired	✓Yes□No ✓Yes□No □Yes□No
<ul> <li>i. Does any portion of the project site contain wetland ponds or lakes)?</li> <li>ii. Do any wetlands or other waterbodies adjoin the project site contain wetlands or lakes)?</li> <li>iii. Are any of the wetlands or waterbodies within or a state or local agency?</li> <li>iv. For each identified regulated wetland and waterbooms.</li> <li>Streams: Name</li> <li>Lakes or Ponds: Name</li> <li>Wetlands: Name</li> <li>Wetland No. (if regulated by DEC)</li> <li>v. Are any of the above water bodies listed in the most waterbodies?</li> </ul>	roject site?  adjoining the project site regulated by on the project site, provide the foundation of NYS water	by any federal,  collowing information:  Classification  Classification  PUBHX  Approximate Size  quality-impaired	✓Yes□No ✓Yes□No □Yes□No
<ul> <li>i. Does any portion of the project site contain wetland ponds or lakes)?</li> <li>ii. Do any wetlands or other waterbodies adjoin the project site to either i or ii, continue. If No, skip to E.2.i.</li> <li>iii. Are any of the wetlands or waterbodies within or a state or local agency?</li> <li>iv. For each identified regulated wetland and waterboout a streams:  Name  Lakes or Ponds: Name  Wetlands: Wetlands: Name  Wetland No. (if regulated by DEC)  v. Are any of the above water bodies listed in the most waterbodies?</li> <li>If yes, name of impaired water body/bodies and basis</li> </ul>	roject site?  adjoining the project site regulated by on the project site, provide the foundation of NYS water	by any federal,  collowing information:  Classification  Classification  PUBHX  Approximate Size  quality-impaired	✓Yes□No ✓Yes□No  ☐Yes□No
<ul> <li>i. Does any portion of the project site contain wetland ponds or lakes)?</li> <li>ii. Do any wetlands or other waterbodies adjoin the project site of the wetlands or waterbodies within or a state or local agency?</li> <li>iv. For each identified regulated wetland and waterboout of the streams:  Name  Lakes or Ponds: Name  Wetlands: Name  Wetland No. (if regulated by DEC)  v. Are any of the above water bodies listed in the most waterbodies?</li> <li>If yes, name of impaired water body/bodies and basis</li> <li>i. Is the project site in a designated Floodway?</li> </ul>	roject site?  adjoining the project site regulated by on the project site, provide the foundation of NYS water	by any federal,  collowing information:  Classification  Classification  PUBHX  Approximate Size  quality-impaired	✓Yes□No ✓Yes□No □Yes☑No □Yes☑No
<ul> <li>i. Does any portion of the project site contain wetland ponds or lakes)?</li> <li>ii. Do any wetlands or other waterbodies adjoin the project site of the project site in a designated Floodway?</li> <li>iii. Are any of the wetlands or waterbodies within or a state or local agency?</li> <li>iv. For each identified regulated wetland and waterboout streams: Name</li> <li>Lakes or Ponds: Name</li> <li>Wetlands: Name</li> <li>Wetland No. (if regulated by DEC)</li> <li>v. Are any of the above water bodies listed in the most waterbodies?</li> <li>If yes, name of impaired water body/bodies and basis</li> <li>i. Is the project site in a designated Floodway?</li> <li>j. Is the project site in the 100-year Floodplain?</li> </ul>	roject site?  adjoining the project site regulated be desired to the project site, provide the feature of the feature of the set recent compilation of NYS water for listing as impaired:	by any federal,  collowing information: Classification Classification Approximate Size quality-impaired	✓Yes□No  ✓Yes□No  —Yes☑No  —Yes☑No  —Yes☑No  —Yes☑No
<ul> <li>i. Does any portion of the project site contain wetland ponds or lakes)?</li> <li>ii. Do any wetlands or other waterbodies adjoin the project site of the project site in the project site contain wetlands or local agency?</li> <li>iv. For each identified regulated wetland and waterboout agency?</li> <li>iv. For each identified regulated wetland and waterboout agency?</li> <li>iv. For each identified regulated wetland and waterboout agency?</li> <li>iv. For each identified regulated wetland and waterboout agency?</li> <li>iv. For each identified regulated wetland and waterboout agency?</li> <li>iv. For each identified regulated wetland and waterboout agency?</li> <li>i. Wetlands: Name agency?</li> <li>i. Wetlands: Name agency?</li> <li>iv. Are any of the above water bodies listed in the most waterbodies?</li> <li>If yes, name of impaired water body/bodies and basis</li> <li>i. Is the project site in a designated Floodway?</li> <li>j. Is the project site in the 100-year Floodplain?</li> <li>k. Is the project site in the 500-year Floodplain?</li> <li>l. Is the project site located over, or immediately adjoint of Yes:</li> </ul>	adjoining the project site regulated by the project site, provide the formula of the project site, provide the formula of the formula of the project site, provide the formula of the project site regulated by the project site, provide the formula of the project site, provide the project site, provide the project site, provide the formula of the project site, provide the project site,	by any federal,  collowing information: Classification Classification Approximate Size quality-impaired  purce aquifer?	✓Yes No  Yes No  Yes No  Yes No  Yes No  Yes No  Yes No
<ul> <li>i. Does any portion of the project site contain wetland ponds or lakes)?</li> <li>ii. Do any wetlands or other waterbodies adjoin the project site of the project site in the project site contain wetlands or local agency?</li> <li>iii. Are any of the wetlands or waterbodies within or a state or local agency?</li> <li>iv. For each identified regulated wetland and waterboon waterbodies:  Name</li></ul>	adjoining the project site regulated by the project site, provide the formula of the project site, provide the formula of the formula of the project site, provide the formula of the project site regulated by the project site, provide the formula of the project site, provide the project site, provide the project site, provide the formula of the project site, provide the project site,	by any federal,  collowing information: Classification Classification Approximate Size quality-impaired  purce aquifer?	✓Yes No  Yes No  Yes No  Yes No  Yes No  Yes No  Yes No

T.1. 4'C. 4. 1. 1. 4. '111'C. 1	41 4 41 4 4		
m. Identify the predominant wildlife species	10	Skunks	
Rabbits	Squirrels	_	
Chipmunks	Oppossums	Foxes	
Birds	Raccoons	Deer	
n. Does the project site contain a designated of If Yes:	·		☐ Yes <b>Z</b> No
<i>i.</i> Describe the habitat/community (compos	ation, function, and basis for designation	on):	
<i>ii.</i> Source(s) of description or evaluation:			
<i>iii</i> . Extent of community/habitat:			
• Currently:		acres	
	proposed:		
		acres	
• Gain or loss (indicate + or -):		acres	
<ul> <li>o. Does project site contain any species of pleendangered or threatened, or does it contains</li> <li>If Yes: <ul> <li>i. Species and listing (endangered or threatened</li> </ul> </li> <li>Indiana Bat</li> </ul>	n any areas identified as habitat for an	endangered or threatened speci-	<b>☑</b> Yes□No es?
-			
p. Does the project site contain any species of	of plant or animal that is listed by NYS	as rare, or as a species of	□Yes <b>☑</b> No
special concern?			
If Yes:			
i. Species and listing:			
q. Is the project site or adjoining area current	ly used for hunting trapping fishing o	r shell fishino?	☐Yes ✓ No
If yes, give a brief description of how the proposed action may affect that use:			
-			
E.3. Designated Public Resources On or N	Near Project Site		
a. Is the project site, or any portion of it, loca	ted in a designated agricultural district	certified pursuant to	<b>✓</b> Yes  No
Agriculture and Markets Law, Article 25-		1	
If Yes, provide county plus district name/nu			
• • • • • • • • • • • • • • • • • • • •			
b. Are agricultural lands consisting of highly			<b>□</b> Yes <b>☑</b> No
<i>i</i> . If Yes: acreage(s) on project site?			
ii. Source(s) of soil rating(s):			
c. Does the project site contain all or part of	or is it substantially continuous to a r	egistered National	□Yes <b>∠</b> No
Natural Landmark?	of is it substantially configuous to, a re	egistered National	1 63 110
If Yes:			
<i>i</i> . Nature of the natural landmark:	Riological Community	ological Feature	
<i>ii.</i> Provide brief description of landmark, in			
110 vide offer description of fandillark, if	icidanig varues benind designation and	approximate size/extent.	
d. Is the project site located in or does it adjo	in a state listed Critical Environmental	Area?	□Yes <b>☑</b> No
If Yes:		·	
iii. Designating agency and date:			

e. Does the project site contain, or is it substantially contiguous to, a but which is listed on the National or State Register of Historic Places, of Office of Parks, Recreation and Historic Preservation to be eligible for	r that has been determined by the Commission	
If Yes:		
i. Nature of historic/archaeological resource: ☐ Archaeological Site ii. Name:	☐ Historic Building or District	
iii. Brief description of attributes on which listing is based:		
f. Is the project site, or any portion of it, located in or adjacent to an archaeological sites on the NY State Historic Preservation Office (SF		∏Yes <b>☑</b> No
g. Have additional archaeological or historic site(s) or resources been in If Yes:		□Yes <b>☑</b> No
i. Describe possible resource(s):		
ii. Basis for identification:		
h. Is the project site within fives miles of any officially designated and scenic or aesthetic resource?	publicly accessible federal, state, or local	□Yes <b>☑</b> No
If Yes:		
<ul><li>i. Identify resource:</li><li>ii. Nature of, or basis for, designation (e.g., established highway overl</li></ul>	ook, state or local park, state historic trail or	scenic byway,
etc.):		
	niles.	
i. Is the project site located within a designated river corridor under the Program 6 NYCRR 666?	e Wild, Scenic and Recreational Rivers	☐ Yes ✓ No
If Yes:		
<ul><li>i. Identify the name of the river and its designation:</li><li>ii. Is the activity consistent with development restrictions contained in</li></ul>	6NVCRR Part 666?	□Yes□No
ii. Is the activity consistent with development restrictions contained in	OIVI CIXX I art 000:	
F. Additional Information Attach any additional information which may be needed to clarify you If you have identified any adverse impacts which could be associated measures which you propose to avoid or minimize them.		npacts plus any
G. Verification I certify that the information provided is true to the best of my knowled Applicant/Sponsor Name Steven Matthews, agent on behalf of applicant	edge. Date 5/11/23	
Signature_Steven Matthews	Title_Director of Engineering	



**Disclaimer:** The EAF Mapper is a screening tool intended to assist project sponsors and reviewing agencies in preparing an environmental assessment form (EAF). Not all questions asked in the EAF are answered by the EAF Mapper. Additional information on any EAF question can be obtained by consulting the EAF Workbooks. Although the EAF Mapper provides the most up-to-date digital data available to DEC, you may also need to contact local or other data sources in order to obtain data not provided by the Mapper. Digital data is not a substitute for agency determinations.



B.i.i [Coastal or Waterfront Area]	No
B.i.ii [Local Waterfront Revitalization Area]	No
C.2.b. [Special Planning District]	Digital mapping data are not available or are incomplete. Refer to EAF Workbook.
E.1.h [DEC Spills or Remediation Site - Potential Contamination History]	Digital mapping data are not available or are incomplete. Refer to EAF Workbook.
E.1.h.i [DEC Spills or Remediation Site - Listed]	Digital mapping data are not available or are incomplete. Refer to EAF Workbook.
E.1.h.i [DEC Spills or Remediation Site - Environmental Site Remediation Database]	Digital mapping data are not available or are incomplete. Refer to EAF Workbook.
E.1.h.iii [Within 2,000' of DEC Remediation Site]	No
E.2.g [Unique Geologic Features]	No
E.2.h.i [Surface Water Features]	No
E.2.h.ii [Surface Water Features]	Yes
E.2.h.iii [Surface Water Features]	Yes - Digital mapping information on local and federal wetlands and waterbodies is known to be incomplete. Refer to EAF Workbook.
E.2.h.v [Impaired Water Bodies]	No
E.2.i. [Floodway]	No
E.2.j. [100 Year Floodplain]	No
E.2.k. [500 Year Floodplain]	No
E.2.I. [Aquifers]	No
E.2.n. [Natural Communities]	No
E.2.o. [Endangered or Threatened Species]	Yes
E.2.o. [Endangered or Threatened Species - Name]	Indiana Bat

E.2.p. [Rare Plants or Animals]	No
E.3.a. [Agricultural District]	Yes
E.3.a. [Agricultural District]	DUTC022
E.3.c. [National Natural Landmark]	No
E.3.d [Critical Environmental Area]	No
E.3.e. [National or State Register of Historic Places or State Eligible Sites]	Digital mapping data are not available or are incomplete. Refer to EAF Workbook.
E.3.f. [Archeological Sites]	No
E.3.i. [Designated River Corridor]	No