

ATTORNEYS AT LAW

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Writer's Telephone Extension: 258 solson@youngsommer.com

August 31, 2023

<u>Via Federal Express</u>

Barbara Roberti, Zoning Administrator Town of Wappinger 20 Middlebush Rd Wappinger Falls, New York 12590-0324

RE:

Verizon Wireless "Kent Road" Communications Facility

ROW adjacent to 2 Baldwin Drive

Dear Ms. Roberti:

In response to comments from the Planning Board, the site plans have been revised to include a line of site plan (Sheet LOS-1).

Enclosed please find eighteen (18) copies of Verizon Wireless' revised site plans.

We look forward to discussing this with the Planning Board at the continued public hearing on September 6, 2023.

Very truly yours, YOUNG SOMMER, LLC

Scott Olson

Enclosure

VERIZON WIRELESS OF THE EAST LP, d/b/a



KENT ROAD

WBS#: VZ-00228988.C.9116 MDG#: 5000913024 **UTILITY POLE #: TBD**



DIRECTIONS

DIRECTIONS TO SITE: FROM NORTH GREENBUSH SWITCH FACILITY GET ON 1-90 W FROM US-4 S AND NY-43 W (72.6± MI). TAKE EXIT 18 FOR NY-299 E (6.0± MI). TURN RIGHT ONTO RTE 9W (2.3± MI). TAKE RAMP TO MID HUDSON BRIDGE/POUGHKEEPSIE (0.4± MI). CONTINUE ONTO US-44 E (3.7± MI). TURN RIGHT ONTO RAYMOND AVE (0.9± MI). TURN LEFT ONTO NY-376 S (4.7± MI). CONTINUE ONTO ALL ANGELS HILL RD (2.2± MI). TURN RIGHT ONTO KENT RD (0.3± MI). SITE WILL BE ON THE LEFT.

SITE ADDRESS:	ADJ TO 2 BALDWIN DR WAPPINGERS FALLS, NY 12590				
MUNICIPALITY:	TOWN OF WAPPINGER				
COUNTY:	DUTCHESS				
TAX MAP NUMBER:	PUBLIC R.O.W.				
ZONING DISTRICT:	ONE-FAMILY RESIDENTIAL (R-20)				
STRUCTURE COORDINATES:	N 41° 35' 35.32" (41.593144°) W 73° 52' 23.64" (-73.873233°)				
GROUND ELEVATION:	247'± AMSL				
POLE OWNER:	VERIZON WIRELESS				
POLE #:	TBD				
APPLICANT:	VERIZON WIRELESS 1275 JOHN STREET, SUITE 100 WEST HENRIETTA, NY 14586				
CONTACT PERSON:	KATHY POMPONIO				
CONTACT PHONE:	(585) 321-5435				
PROJECT SUMMARY					

PROJECT DESCRIPTION

THE PROPOSED WORK CONSISTS OF:

- PROPOSED 50' (CLASS 2) WOODEN UTILITY POLE.
- INSTALL (1) CELLULAR ANTENNA & ASSOCIATED EQUIPMENT ON PROPOSED POLE.
- INSTALL ELECTRICAL, TELCO AND CABLE ROUTING AS NECESSARY.

SHT. NO.	DESCRIPTION	REV NO	REVISION DATE
T-1	TITLE SHEET	1	8/30/23
GN-1	GENERAL NOTES	1	8/30/23
C-1	SITE PLAN & EQUIPMENT PLAN	1	8/30/23
C-2	POLE ELEVATION & DETAIL	1	8/30/23
C-3	POLE MOUNT DETAILS	1	8/30/23
E-1	ELECTRICAL & GROUNDING DIAGRAMS & DETAILS	1	8/30/23
LOS	LINE OF SIGHT PLAN	1	8/30/23
SH	EET INDEX		

THIS SET OF PLANS SHALL NOT BE UTILIZED AS CONSTRUCTION DOCUMENTS UNTIL ALL ITEMS OF CONCERN HAVE BEEN ADDRESSED AND EACH OF THE DRAWINGS HAS BEEN REVISED AND ISSUED "FOR CONSTRUCTION"

UTILITY PROVIDERS	
ELECTRIC PROVIDER: ESR #: PLANNER: PHONE:	CHG&E TBD TBD (XXX) XXX-XXX
FIRFR.	VERIZON

Before You Dig, Drill Or Blast! **O**UDIG-NY

CALL US TOLL FREE 811 OR 1-800-962-7962 NY industrial code rule 753 requires no less than two working days notice, but not more than ten days notice

UDIGNY - NEW YORK

DO NOT SCALE DRAWINGS

THESE DRAWINGS ARE FORMATTED FOR 22"x34" FULL SIZE AND 11"x17" HALF SIZE. OTHER SIZED VERSIONS ARE NOT PRINTED TO THE SCALE SHOWN. CONTRACTOR SHALL VERIFY ALL PLANS, EXISTING DIMENSIONS & CONDITIONS ON THE JOB SITE & SHALL IMMEDIATELY NOTIFY THE ENGINEER IN WRITING OF ANY DISCREPANCIES BEFORE PROCEEDING WITH THE WORK OR BE RESPONSIBLE FOR SAME.

verizon/

1275 JOHN STREET, SUITE 100 WEST HENRIETTA, NY 14586



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ORIGINAL SIZE IN INCHES (22x34 FORMAT)

ORIGINAL SIZE IN INCHES (11x17 FORMAT)

SITE INFORMATION KENT ROAD WBS#: VZ-00228988.C.9116 MDG#: 5000913024

SITE ADDRESS UTILITY POLE# TBD ADJ TO 2 BALDWIN DR TOWN OF WAPPINGER DUTCHESS COUNTY NY 12590

TITLE SHEET

SHEET NUMBER

T-1

ELECTRICAL NOTES

- ALL ELECTRICAL WORK SHALL BE PERFORMED IN ACCORDANCE WITH THE PROJECT SPECIFICATIONS, NEC AND ALL APPLICABLE LOCAL CODES.
- 2. ALL ELECTRICAL EQUIPMENT AND ACCESSORIES SHALL BE U.L. APPROVED OR LISTED.
- CONDUIT ROUTINGS ARE SCHEMATIC. CONTRACTOR SHALL INSTALL CONDUITS SO THAT ACCESS TO EQUIPMENT IS NOT BLOCKED.
- . WRING, RACEWAY AND SUPPORT METHODS AND MATERIALS SHALL COMPLY WITH THE REQUIREMENTS OF THE NEC.
- 5. ALL CIRCUITS SHALL BE SEGREGATED AND MAINTAIN MINIMUM CABLE SEPARATION AS REQUIRED BY THE NEC.
- EACH END OF EVERY POWER, POWER PHASE CONDUCTOR (I.E., HOTS), GROUNDING, AND TI CONDUCTOR AND CABLE SHALL BE LABELED WITH COLOR—CODED INSULATION OR ELECTRICAL TAPE (3M BRAND, 1/2 INCH PLASTIC ELECTRICAL TAPE WITH UV PROTECTION, OR EQUAL). THE IDENTIFICATION METHOD SHALL CONFORM WITH NEC & OSHA.
- ALL ELECTRICAL COMPONENTS SHALL BE CLEARLY LABELED. ALL EQUIPMENT SHALL BE LABELED WITH THEIR VOLTAGE RATING, POWER OR AMPACITY RATING, AND BRANCH CIRCUIT ID NUMBERS (I.E., PANELBOARD AND CIRCUIT ID'S).
- 8. PANELBOARDS (ID NUMBERS) AND INTERNAL CIRCUIT BREAKERS (CIRCUIT ID NUMBERS)
- POWER, CONTROL, AND EQUIPMENT GROUND WIRING IN TUBING OR CONDUIT SHALL BE SINGLE CONDUCTOR (#14 AWG OR LARGER), 600 V, OIL RESISTANT THHN OR THWN-2, STRANDED COPPER CABLE RATED FOR 90°C (WET AND DRY) OPERATION; LISTED OR LABELED FOR THE LOCATION AND RACEWAY SYSTEM USED, UNLESS OTHERWISE SPECIFIED.
- 10. SUPPLEMENTAL EQUIPMENT GROUND WIRING LOCATED INDOORS SHALL BE SINGLE CONDUCTO (#6 AWG OR LARGER), 600 V, OIL RESISTANT THHN OR THWN-2 GREEN INSULATION, STRANDED COPPER CABLE RATED FOR 90°C (WET AND DRY) OPERATION; LISTED OR LABELED FOR THE LOCATION AND RACEWAY SYSTEM USED, UNLESS OTHERWISE SPECIFIED.
- 1. POWER AND CONTROL WIRING, NOT IN TUBING OR CONDUIT, SHALL BE MULTI-CONDUCTOR, TYPE USE-2 CABLE (#14 AWG OR LARGER), 600 V, OIL RESISTANT RHW-2 OR XHHW-2, STRANDED COPPER CABLE RATED FOR 90°C (WET AND DRY) OPERATION; WITH OUTER JACKET; LISTED OR LABELED FOR THE LOCATION USED, UNLESS OTHERWISE SPECIFIED.
- 12. ALL POWER AND GROUNDING CONNECTIONS SHALL BE CRIMP-STYLE, COMPRESSION WIRE LUGS AND WRE NUTS BY THOMAS AND BETTS (OR EQUAL). LUGS AND WIRE NUTS SHALL BE RATED FOR OPERATION AT NO LESS THAN 90°C.
- ELECTRICAL METALLIC TUBING (EMT) OR RIGID METALLIC CONDUIT (RMC) SHALL BE USED FOR EXPOSED OR CONCEALED LOCATIONS.
- 14. ALL OUTDOOR EXPOSED CONDUIT SHALL BE PVC SCHEDULE 80 AND SHALL BE SUPPORTED
- 15. LIQUID—TIGHT FLEXIBLE METALLIC CONDUIT (LIQUID—TITE FLEX) SHALL BE USED OUTDOORS, WHERE MARATION OCCURS OR FLEXIBILITY IS NEEDED. LFMC SHALL CONFORM TO NEC
- 16. CONDUIT AND TUBING FITTINGS SHALL BE THREADED OR COMPRESSION—TYPE AND APPROVED FOR THE LOCATION USED. SET SCREW FITTINGS ARE NOT ACCEPTABLE.
- 17. CABINETS, BOXES, AND WIREWAYS SHALL BE LISTED OR LABELED FOR ELECTRICAL USE IN ACCORDANCE WITH NEMA, UL, ANSI/IEEE, AND NEC.
- 18. EQUIPMENT CABINETS, TERMINAL BOXES, JUNCTION BOXES, AND PULL BOXES SHALL BE GALVANIZED OR EPOXY—COATED SHEET STEEL, SHALL MEET OR EXCEED UL 50, AND RATED NEMA 3R (OR BETTER) OUTDOORS.
- 19. IF REQUIRED, CONTRACTOR SHALL APPLY FOR ELECTRICAL SERVICE AS SOON AS POSSIBLE AND COORDINATE REQUIREMENTS, SERVICE ROUTING, AND METER SOCKET TYPE WITH LOCAL POWER COMPANY.
- 20. CONTRACTOR SHALL OBTAIN ALL PERMITS, PAY PERMIT FEES, AND SCHEDULE INSPECTIONS.
- 21. CONTRACTOR SHALL LABEL ELECTRICAL EQUIPMENT IN ACCORDANCE WITH NEC 110.16 AND
- 22. CONTRACTOR SHALL VERIFY THAT THE MAIN BONDING JUMPER AND GROUNDING ELECTRODE CONDUCTOR IS INSTALLED PROPERLY AT SERVICE ENTRANC
- 23. WHERE ELECTRICAL POWER IS TO BE SUB-FED FROM AN EXISTING DISTRIBUTION SYSTEM, THE FOLLOWING SHALL APPLY:
 A. CONTRACTOR SHALL PERFORM LOAD TESTING TO DETERMINE MAXIMUM FEEDER DEMAND
- A. CONTRACTOR SHALL PERFORM LUAD TESTING TO DETERMINE MISSING.
 PER N.E.C. ARTICLE 220.
 B. CONTRACTOR SHALL VERIFY WHETHER EXISTING FEEDER CAPACITY EXCEEDS VALUE
 CALCULATED PER N.E.C. ARTICLE 220.
 C. EACH BRANCH CIRCUIT PROTECTIVE DEVICE SHALL HAVE SAME INTERRUPTING RATING AS
- D. PREFERRED MEANS OF SUPPLY SHALL BE A BRANCH CIRCUIT PROTECTIVE DEVICE

ANTENNA MOUNTING NOTES

- 1. DESIGN AND CONSTRUCTION OF ANTENNA SUPPORTS SHALL CONFORM TO ANSI/TIA-222-H-2017 "STRUCTURAL STANDARD FOR ANTENNA SUPPORTING STRUCTURES, ANTENNAS AND SMALL WIND TURBINE SUPPORT STRUCTURES". THE BUILDING CODE OF NEW YORK STATE, AND ALL OTHER APPLICABLE LOCAL, STATE, AND FEDERAL CODES
- 2. ALL STEEL MATERIALS SHALL BE GALVANIZED AFTER FABRICATION IN ACCORDANCE WITH ASTM A123 "ZINC (HOT-DIP GALVANIZED) COATINGS ON IRON AND STEEL PRODUCTS", UNLESS OTHERWISE NOTED
- 3. ALL BOLTS, ANCHORS AND MISCELLANEOUS HARDWARE SHALL BE GALVANIZED IN ACCORDANCE WITH ASTM A153 "ZINC-COATING (HOT-DIP) ON IRON AND STEEL HARDWARE", UNLESS OTHERWISE NOTED.
- 4. DAMAGED GALVANIZED SURFACES SHALL BE REPAIRED BY COLD GALVANIZING IN ACCORDANCE WITH ASTM A780 "REPAIR OF DAMAGED AND UNCOATED AREAS OF HOT-DIP GALVANIZED COATINGS", USING COLD GALVANIZING COMPOUND AS MANUFACTURED BY ZINGA-USA OR ZINC KOTE, OR ENGINEER APPROVED EQUAL WITH A MINIMUM METALLIC ZINC CONTENT OF 95% BY WEIGHT IN DRY FILM. DRY FINISHED COATING THICKNESS SHALL BE 3 MILS MINIMUM.
- 5. ALL ANTENNA MOUNTS SHALL BE INSTALLED WITH DOUBLE NUTS AND SHALL BE INSTALLED IN ACCORDANCE WITH MANUFACTURER'S
- 6. DESIGN OF THE ANTENNA MOUNTING BRACKETS, SUPPORTS, AND ALL COMPONENTS THEREOF AND ATTACHMENT THERETO SHALL BE THE RESPONSIBILITY OF THE MANUFACTURER. MANUFACTURER SHALL PROVIDE THE OWNER DRAWINGS DETAILING ALL COMPONENTS OF THE ASSEMBLY. INCLUDING CONNECTIONS, DESIGN LOADS, AND ALL OTHER PERTINENT DATA. MANUFACTURER SHALL ALSO PROVIDE THE OWNER WITH A STATEMENT OF COMPLIANCE, INDICATING THAT THE ANTENNA SUPPORTS HAVE BEEN DESIGNED IN ACCORDANCE WITH ANSI/TIA-222-H STANDARDS. ALL SUBMISSIONS SHALL BEAR THE SIGNATURE AND SEAL OF A PROFESSIONAL ENGINEER LICENSED IN THE STATE OF NEW YORK.

STRUCTURAL NOTE

- THE VERIFICATION OF STRUCTURAL ADEQUACY AND DESIGN OF THE ATTACHMENTS MUST BE PERFORMED, PRIOR TO THE COMMENCEMENT OF CONSTRUCTION, BY A PROFESSIONAL ENGINEER LICENSED IN THE STATE OF NEW YORK.
- 2. REFER TO STRUCTURAL ANALYSIS REPORT PREPARED BY TECTONIC ENGINEERING CONSULTANTS, GEOLOGISTS & LAND SURVEYORS, D.P.C DATED 04/14/23.

GROUNDING NOTES

GROUND TESTING AFTER CONSTRUCTION:

- AFTER COMPLETION OF CONSTRUCTION OF THE CELL SITE GROUND SYSTEM, A POST INSTALLATION CLAMP—ON RESISTANCE TEST WILL BE PERFORMED BY THE CONTRACTOR AS REQUIRED BY NEC AND PROVIDED TO VERIZON BY THE CONTRACTOR AS REQUIRED BY NEC AND PROVIDED TO VERIZON WIRELESS, A SINGLE ROD, PIPE, OR PLATE ELECTRODE SHALL BE SUPPLEMENTED BY AN ADDITIONAL ELECTRODE OF A TYPE SPECIFIED IN 250.53(A)(2) THROUGH (A)(8). THE SUPPLEMENTAL ELECTRODE SHALL BE PERMITTED TO BE BONDED TO ONE OF THE FOLLOWING:

 A. ROD, PIPE OR PLATE ELECTRODE
 B. GROUNDING ELECTRODE CONDUCTOR

 IF A SINGLE ROD, PIPE, OR PLATE GROUNDING ELECTRODE HAS A RESISTANCE TO EARTH OF 25 OHMS OR LESS, THE SUPPLEMENTAL ELECTRODE SHALL NOT BE REQUIRED. GROUNDING TEST SHALL BE TAKEN DEFERDER A'C PROWER DISCIPLIANCE TO
- BEFORE A/C POWER, NEUTRAL/GROUND BOND IS CONNECTED.
- . USE OF 90' BENDS IN THE PROTECTION GROUNDING CONDUCTORS SHALL BE AVOIDED WHEN 45' BENDS CAN BE ADEQUATELY SUPPORTED. ALL BENDS SHALL BE MADE WITH 12" RADIUS OR LARGER.
- 3. APPROVED ANTIOXIDANT COATINGS (I.E. CONDUCTIVE GEL OR PASTE) SHALL BE USED ON ALL COMPRESSION AND BOLTED GROUND CONNECTIONS. ANTI-OXIDATION CONDUCTIVE COMPOUNDS ARE REQUIRED ON ALL GROUND CONNECTIONS. NO OX-ID (COSMOLINE GREASE BASED COMPOUND) SHALL BE USED FOR COPPER TO COPPER CONNECTIONS. ZINC BASED COMPOUND (GREY COLORED) OR APPROVED EQUAL SHALL BE USED FOR COPPER TO STEEL CONNECTIONS.
- 4. ALL LUG CONNECTIONS & THEIR MATING SURFACES SHALL BE CLEANED ALL LUG CONNECTIONS & HIELM MATING SURFACES SHALL BE CLEARED AND COATED WITH THE APPROPRIATE ANTI-OXIDIZING CONDUCTIVE COMPOUND. IF A LUG CONNECTION IS TO BE SECURED DIRECTLY TO A PAINTED SURFACE, THE PAINT SHALL BE REMOVED TO REVEAL BARE METAL AROUND THE AREA OF THE CONNECTION AND COATED WITH AN APPROPRIATE ANTI-OXIDATION CONDUCTIVE COMPOUNDS
- 5. THE POST INSTALLATION GROUND RESISTANCE TEST REPORT AND THE THIRD PARTY ELECTRICAL INSPECTION CERTIFICATION SHALL BE PROVIDED. TO THE CITY OF SCHENECTADY FLECTRICAL INSPECTOR
- 6. SURGE PROTECTORS ARE NOT APPLICABLE TO THIS DESIGN.

GENERAL NOTES

- ALL WORK SHALL CONFORM TO THE REQUIREMENTS OF THE NEW YORK STATE BUILDING CODE, AND ALL OTHER APPLICABLE CODES AND
- CONTRACTOR SHALL VISIT THE JOB SITE AND FAMILIARIZE HIMSELF WITH ALL CONDITIONS AFFECTING THE PROPOSED WORK AND MAKE PROVISIONS AS TO THE COST THEREOF. CONTRACTOR SHALL BE RESPONSIBLE FOR FAMILLARIZING HIMSELF WITH ALL CONTRACT DOCUMENTS, FIELD CONDITIONS AND DIMENSIONS AND CONFIRMING THAT THE WORK MAY BE ACCOMPLISHED AS SHOWN PRIOR TO PROCEEDING WITH CONSTRUCTION. ANY DISCREPANCIES SHALL BE BROUGHT TO THE ATTENTION OF THE ENGINEER PRIOR TO THE COMMENCEMENT OF WORK.
- PLANS ARE NOT TO BE SCALED. THESE PLANS ARE INTENDED TO BE A PLANTS ARE NOT TO BE SCALED. THESE PLANTS ARE INTERDED TO BE A DIAGRAMMATIC OUTLINE ONLY, UNLESS OTHERWISE NOTED. THE WORK SHALL INCLUDE FURNISHING MATERIALS, EQUIPMENT, APPURTENANCES, AND LABOR NECESSARY TO EFFECT ALL INSTALLATIONS AS INDICATED ON THE DRAWINGS.
- DIMENSIONS SHOWN ARE TO FINISH SURFACES. UNLESS OTHERWISE NOTED. SPACING BETWEEN EQUIPMENT IS REQUIRED CLEARANCE. THEREFORE, IT IS CRITICAL TO FIELD VERIFY DIMENSIONS. SHOULD THERE BE ANY QUESTIONS REGARDING THE CONTRACT DOCUMENTS, EXISTING CONDITIONS AND/OR DESIGN INTENT, THE CONTRACTOR SHALL BE RESPONSIBLE FOR OBTAINING A CLARIFICATION FROM THE CARRIER'S AUTHORIZED REPRESENTATIVE OR THE ENGINEER PRIOR TO PROCEEDING WITH THE WORK.
- DETAILS ARE INTENDED TO SHOW END RESULT OF DESIGN. MINOR MODIFICATIONS MAY BE REQUIRED TO SUIT JOB DIMENSIONS OR CONDITIONS, AND SUCH MODIFICATIONS SHALL BE INCLUDED AS PART OF THE WORK.
- CONTRACTOR SHALL RECEIVE CLARIFICATION IN WRITING, AND SHALL RECEIVE IN WRITING AUTHORIZATION TO PROCEED BEFORE STARTING WORK ON ANY ITEMS NOT CLEARLY DEFINED OR IDENTIFIED BY THE CONTRACT DOCUMENTS.
- CONTRACTOR SHALL NOTIFY THE CONSTRUCTION MANAGER OF ALL PRODUCTS OR ITEMS NOTED AS "EXISTING" WHICH ARE NOT FOUND TO BE IN
- CONTRACTOR SHALL SUPERVISE AND DIRECT THE WORK USING THE BEST CONSTRUCTION SKILLS AND ATTENTION. CONTRACTOR SHALL BE SOLELY RESPONSIBLE FOR CONSTRUCTION MEANS, METHODS, TECHNIQUES, SEQUENCES, PROCEDURES, AND FOR COORDINATING ALL PORTIONS OF THE WORK UNDER CONTRACT, UNLESS OTHERWISE NOTED.
- ERECTION SHALL BE DONE IN A WORKMANLIKE MANNER BY COMPETENT EXPERIENCED WORKMEN IN ACCORDANCE WITH APPLICABLE CODES AND THE BEST ACCEPTED PRACTICE. ALL MEMBERS SHALL BE LAID PLUMB AND TRUE AS INDICATED ON THE DRAWINGS.
- 10. CONTRACTOR SHALL BE RESPONSIBLE FOR THE SAFETY OF THE WORK AREA, AND ADJACENT AREAS, THAT ARE LIKELY TO BE AFFECTED BY THE WORK UNDER THIS CONTRACT. WORK SHALL CONFORM TO ALL OSHA REQUIREMENTS.
- 11. CONTRACTOR SHALL COORDINATE HIS WORK AND SCHEDULE HIS ACTIVITIES AND WORKING HOURS IN ACCORDANCE WITH THE REQUIREMENTS OF THE
- 12. CONTRACTOR SHALL BE RESPONSIBLE FOR COORDINATING HIS WORK WITH THE WORK OF OTHERS AS IT MAY RELATE TO RADIO EQUIPMENT, ANTENNAS AND ANY OTHER PORTIONS OF THE WORK.
- 13. CONTRACTOR SHALL MAINTAIN LIABILITY INSURANCE TO PROTECT THE OWNER
- 14. INSTALL ALL EQUIPMENT AND MATERIALS IN ACCORDANCE WITH MANUFACTURER'S RECOMMENDATIONS UNLESS SPECIFICALLY INDICATED OR WHERE LOCAL CODES OR REGULATIONS TAKE PRECEDENCE.
- 15. MAKE NECESSARY PROVISIONS TO PROTECT EXISTING SURFACES, EQUIPMENT IMPROVEMENTS, PIPING, ANTENNA AND ANTENNA CABLES, REPAIR AN' DAMAGE THAT OCCURS DURING CONSTRUCTION
- 16. REPAIR ALL EXISTING SURFACES DAMAGED DURING CONSTRUCTION SUCH THAT THEY MATCH AND BLEND WITH ADJACENT SURFACES.
- 17. KEEP CONTRACT AREA CLEAN, HAZARD FREE, AND DISPOSE OF ALL DEBRIS AND RUBBISH. EQUIPMENT NOT SPECIFIED AS REMAINING ON THE PROPERTY OF THE OWNER SHALL BE REMOVED. LEAVE PREMISES IN CLEAN CONDITION AND FREE FROM PAINT SPOTS, DUST, OR SMUDGES OF ANY NATURE. CONTRACTOR SHALL BE RESPONSIBLE FOR MAINTAINING ALL ITEMS UNTIL COMPLETION OF CONSTRUCTION.
- 18. CONTRACTOR SHALL VERIFY ALL DIMENSIONS AND CONDITIONS IN THE FIELD PRIOR TO FABRICATION AND ERECTION OF ANY MATERIAL. ANY UNUSUAL CONDITIONS SHALL BE REPORTED TO THE ATTENTION OF THE ENGINEER.
- CONTRACTOR SHALL SECURE ALL NECESSARY BUILDING PERMITS AND INSPECTIONS AND PAY ALL REQUIRED FEES.
- 20. PROVIDE A PORTABLE FIRE EXTINGUISHER WITH A RATING OF NOT LESS THAN 2-A OR 2-A/10-BC WITHIN 75 FEET TRAVEL DISTANCE TO ALL PORTIONS OF THE BUILDOUT AREA DURING CONSTRUCTION.
- 21. ALL BROCHURES, OPERATING AND MAINTENANCE MANUALS, CATALOGS, SHOP DRAWINGS AND OTHER DOCUMENTATION SHALL BE TURNED OVER TO CARRIER AT COMPLETION OF CONSTRUCTION.
- 22. COMPLETE JOB SHALL BE GUARANTEED FOR A PERIOD OF ONE (1) YEAR AFTER THE DATE OF ACCEPTANCE BY CARRIER. ANY WORK, MATERIALS, OR EQUIPMENT FOUND TO BE DEFECTIVE DURING THAT PERIOD SHALL BE CORRECTED IMMEDIATELY UPON WRITTEN NOTIFICATION AT NO ADDITIONAL COST TO CARRIER.
- 23. RIGGING OPERATIONS SHALL BE DONE IN ACCORDANCE WITH STATE AND . RIGGING OFERATIONS SALE BE DONE IN ACCORDANCE WITH STATE AND THE OWNER FEDERAL SAFETY REGULATIONS (OSHA). ENGINEER, CARRIER AND THE OWNER SHALL BE HELD HARMLESS IN THE EVENT THE CONTRACTOR DOES NOT FOLLOW SUCH SAFETY REGULATIONS
- 24. CONTRACTOR SHALL PROVIDE ACCESS TO THE SITE AND ASSIST THE RADIO EQUIPMENT VENDOR AND THE ANTENNA INSTALLATION CONTRACTOR AS THEY MAY REQUIRE.



1275 JOHN STREET, SUITE 100 WEST HENRIETTA, NY 14586



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Horized Alteration or additions to a plan kg the Seal of a licensed engineer or land yor is a volation of Section 7209 Wision 2 of the New York State Education

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ORIGINAL SIZE IN INCHES (22x34 FORMAT)




KENT ROAD WBS#: VZ-00228988.C.9116 MDG#: 5000913024

SITE ADDRESS UTILITY POLE# TBD ADJ TO 2 BALDWIN DR TOWN OF WAPPINGER DUTCHESS COUNTY NY 12590

SHEET TITL GENERAL NOTES

SHEET NUMBER

GN-1

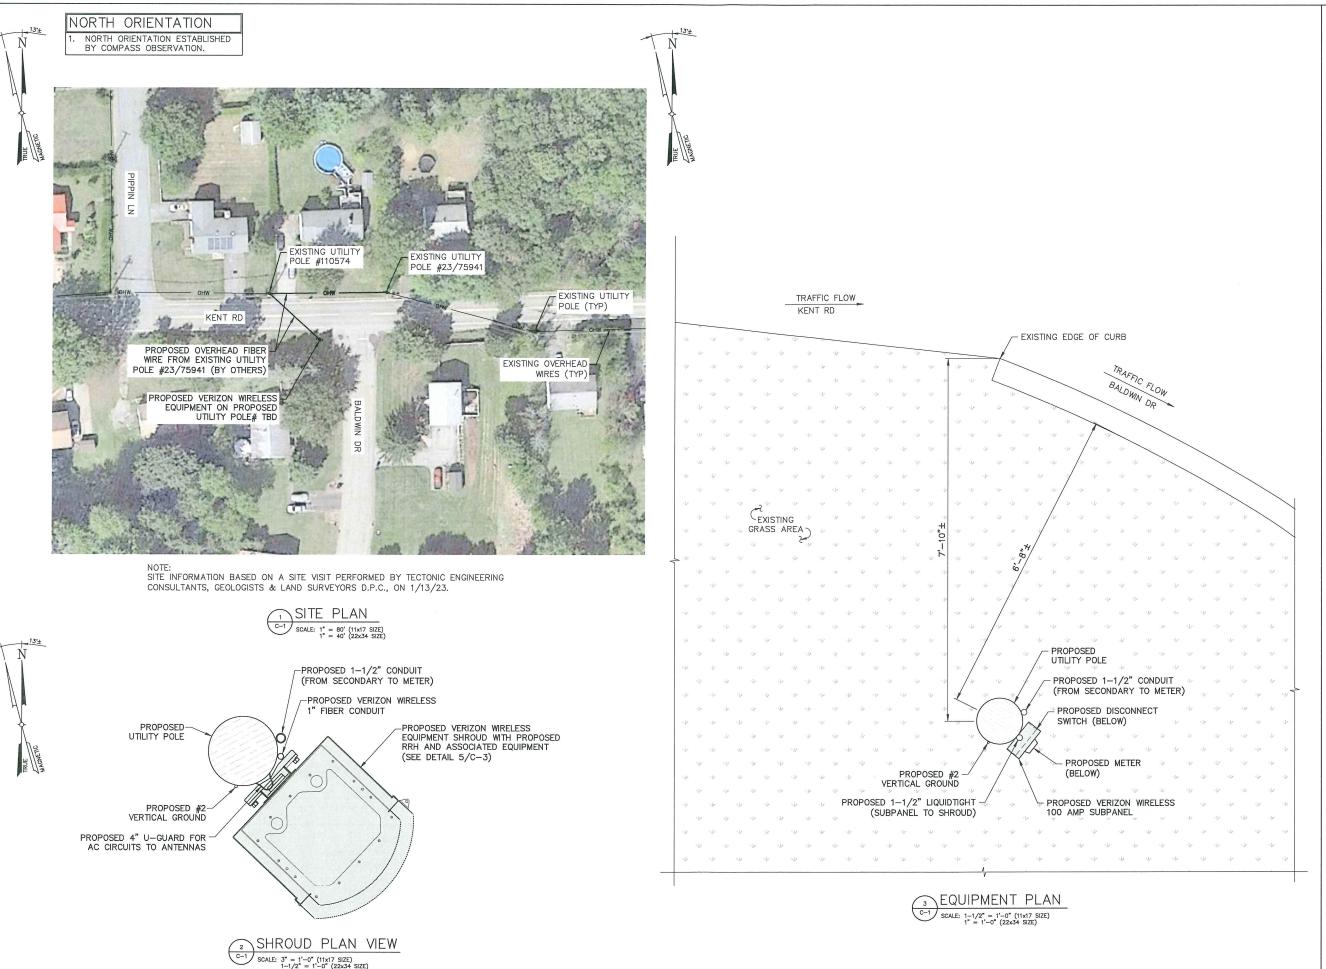



1275 JOHN STREET, SUITE 100 WEST HENRIETTA, NY 14586

Tectonic

PRACTICAL SOLUTION, EXCEPTIONAL SERVICE.
Tectors: Explanating at land Surveys, D.P.C.

| NO. DATE | ISSUE | NO. DATE | NO. DATE | ISSUE | NO. DATE | NO. D

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UNAUTHORIZED ALTERATION OR ADDITIONS TO A PLAN BEARING THE SEAL OF A LICENSED ENGINEER OR LAND SURVEYOR IS A VIOLATION OF SECTION 7209 SUBDIVISION 2 OF THE NEW YORK STATE FOLICATION

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ORIGINAL SIZE IN INCHES (22x34 FORMAT)

ORIGINAL SIZE IN INCHES
(11x17 FORMAT)

SITE INFORMATION

KENT ROAD

WBS#: VZ-00228988.C.9116 MDG#: 5000913024

SITE ADDRESS


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NY 12590


SHEET TITLE

SITE PLAN & EQUIPMENT PLAN

SHEET NUMBER

C-1

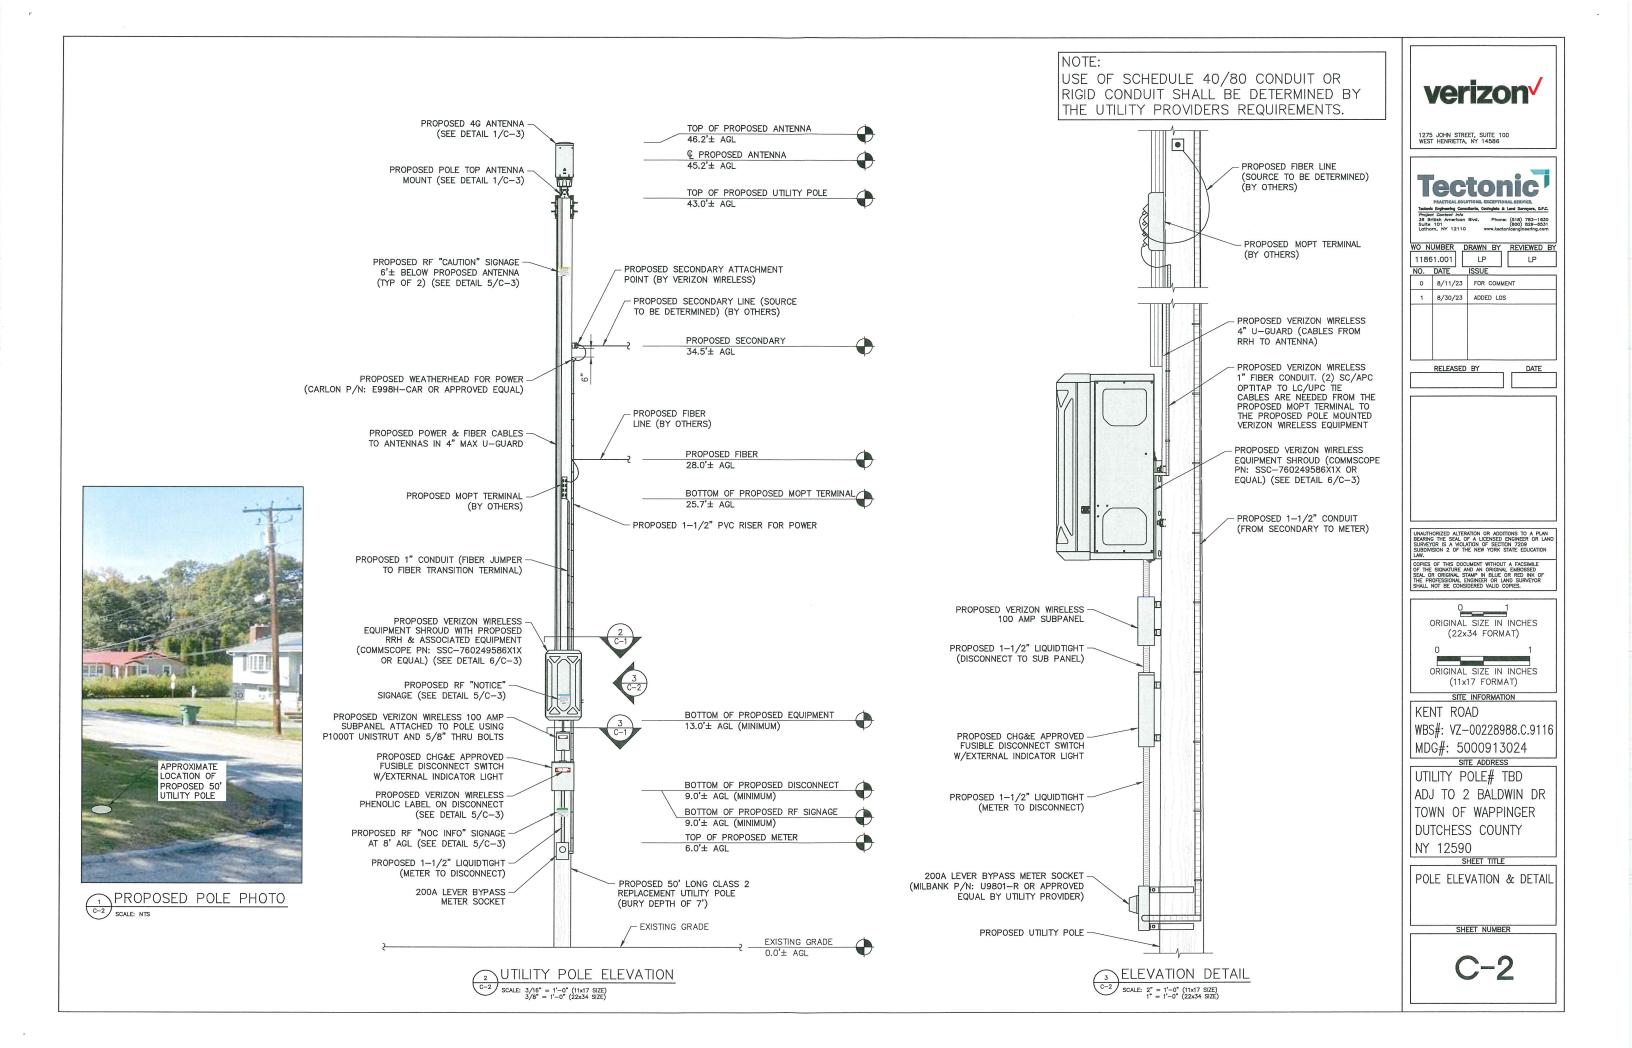

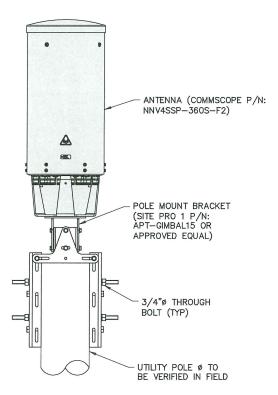

POLE-TOP ANTENNA MOUNTING POLE C-3 SCALE: NTS








VERIZON WIRELESS AC SERVICE DISCONNECT & RF SHUTOFF

NOTE:

- 1. CONTRACTOR TO FURNISH AND INSTALL PHENOLIC LABEL APPLIED TO LOAD CENTER.
- 2. ATTACH RF "NOTICE" AND "INFORMATION" SIGNAGE TO FACE OF UTILITY POLE USING 1" WOOD SCREWS.
- 3. RF SIGNS ARE APPROXIMATELY 6"x7.5" IN SIZE.



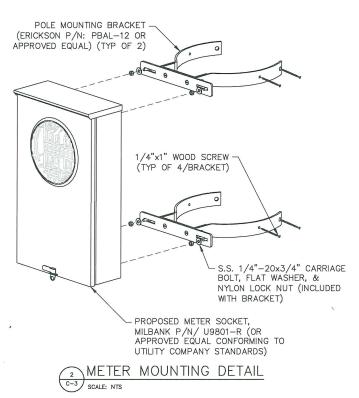

Metro Cell Solutions

Universal Single Part Number Radio Enclosure

One pole mounted Radio Enclosure for all your radio configurations under a single part number

Highly configurable – supports varying configurations with a universal mounting solution Aesthetically curved front Accepts Radios for:
Ericsson SSC-760249586E1X
Nokia SSC-760249586S1X
Samsung radios SSC-760249586S1X

The radio concealment enclosure is designed to concea

small cell radios and be mounted to existing metal, concrete and wood pole structures as well as pole replacements where low-visual impact is des

Unique, universal internal mounting system
Can be kitted with Rectifiers, Raycap,

System Dimensioning & Configuration

Height / Width / Depth / Volume

Power/Fiber Input Conduit

Finish

MV2 Micro Radio Concealment Enclosure

48 in. (1219.2 mm) / 24 in. (609.6 mm) / 26 in (660.4 mm) 17.3 cu ft.

2.5in-8.5 in. Dla by clamping (Larger diameter poles by steel banding)
Up to 12in Dia Wood Pole with included 5/8* threaded rod for through bolting


"1" for Light Grey, "2" for Green, "3" for Black, "4" for Brown, "6" for Fairfax Brown, "8" Federal Park Brown, "9" for Metallic Silver, "W" for White

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70lbs. (32kg) with no radio equipment installed Approx. 279lbs (127kg) fully loaded* (max) *weight varies on configuration

UV-resistant powder coat; Various color options available

SSC-760249586X1X

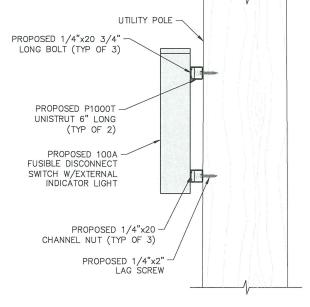

DISCONNECT MOUNTING DETAIL

SCALE: 4" = 1'-0" (11x17 SIZE) 2" = 1'-0" (22x34 SIZE

Metro Cell Solutions

COMMSCOPE®

SSC-760249586X1X

COMMSCOPE°

Samsung Configurations "SSC-760249586S1X"

• (1) AWS PCS 320W dual band radio, (1) RT4401-48A CBRS radio, (1) RT2201-46A LAA radio, (1) Delta 2.0kW DC rectifier, (1) SDX1926Q-43JSDX1926T-43
"Please see CommScope representative for additional configurations"

**Preases see Commiscope representative for adoutcard comingurations

Nokia Configurations "SC-760494568HX"

* (2) Dual Band 160W and/or 320W and/or Tri Band 370W Radios with Associated Rectifiers

Supported Dual or Tri Band Radios:

AHFIG

AHFIG

AHFIG

AHFIG

AHIGA

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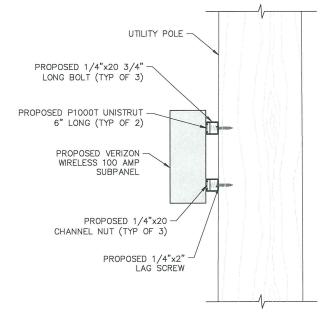





EQUIPMENT SHROUD DETAILS C-3 SCALE: NTS

NOTE:

USE OF SCHEDULE 40/80 CONDUIT OR RIGID CONDUIT SHALL BE DETERMINED BY THE UTILITY PROVIDERS REQUIREMENTS.





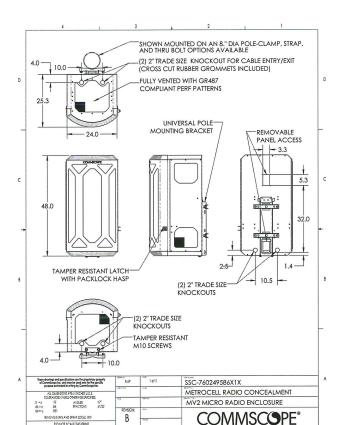




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SITE INFORMATION KENT ROAD


WBS#: VZ-00228988.C.9116 MDG#: 5000913024

SITE ADDRESS UTILITY POLE# TBD ADJ TO 2 BALDWIN DR TOWN OF WAPPINGER DUTCHESS COUNTY NY 12590

SHEET TITLE


POLE MOUNT DETAILS

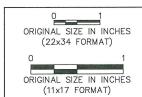SHEET NUMBER

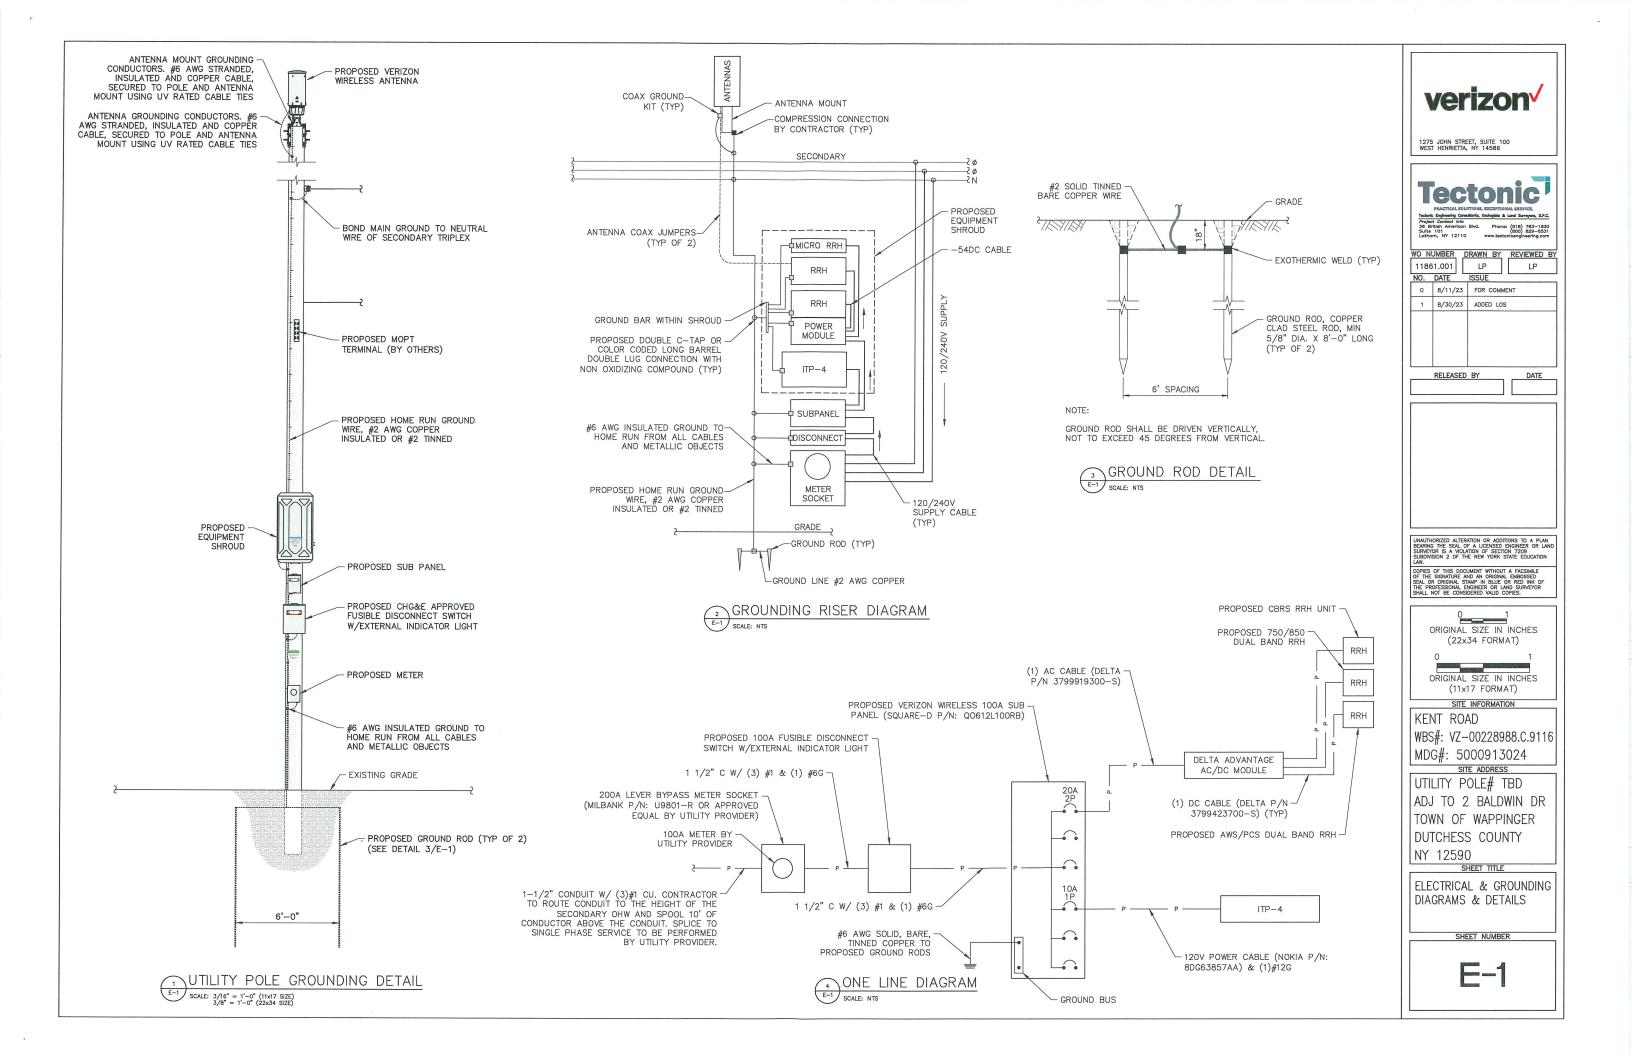

IRUE MAGNETIC NORTH ORIENTATION

NORTH ORIENTATION ESTABLISHED BY COMPASS OBSERVATION.

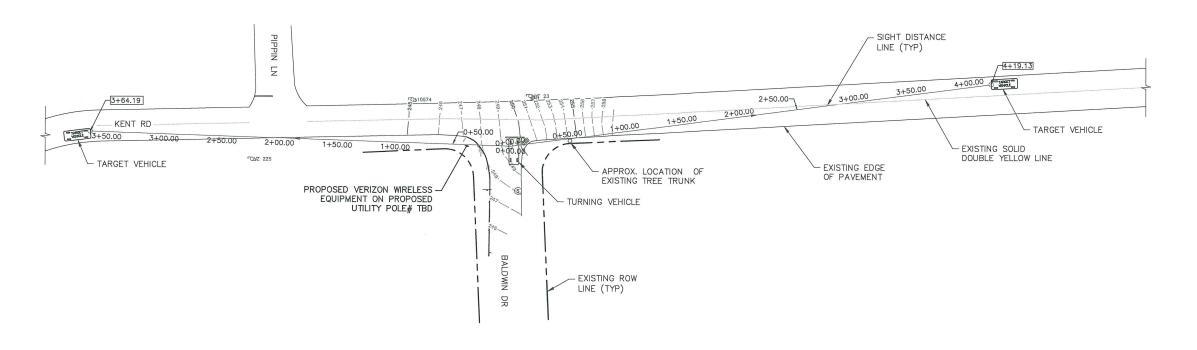

NOTE: KENT ROAD IS A PUBLIC HIGHWAY WITH POSTED SPEED LIMIT OF 30 MPH.

1 LINE OF SIGHT PLAN

1 SCALE: 1* = 80' (11x17 SIZE)
1* = 40' (22x34 SIZE)

TABLE 5C-3 DESIGN INTERSECTION SIGHT DISTANCE (IN FEET) — CASE B1 — LEFT TURN FROM STOP

DESIGN PASSENGER CAR SINGLE-UNIT TRUCK COMBINATION TRUCK SPEED

TABLE DESIGN INTERSECTION SIGHT DISTANCE (IN FEET) — CASE B2 — RIGHT TURN FROM STOP AND

5C-4			_	CASE B3	- CRÓSSIN	IG MANEUV	ER		
DESIGN SPEED	PASSENGER CAR			SING	SINGLE-UNIT TRUCK		COMBINATION TRUCK		
(MPH)	1	2	3	1	2	3	1	2	3
15	145	155	170	190	205	220	235	250	265
20	195	210	225	250	275	295	310	330	350
25	240	260	280	315	340	365	390	415	440
30	290	310	335	375	410	440	465	495	525
35	335	365	390	440	475	510	545	580	615
40	385	415	445	500	545	585	620	660	700
45	430	465	500	565	610	655	695	745	790
50	480	515	555	625	680	730	775	825	875
55	530	570	610	690	745	805	850	910	965
60	575	620	665	750	815	875	930	990	1050
65	625	670	720	815	880	950	1005	1075	1140
70	670	725	775	875	950	1020	1085	1155	1225



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O 1 ORIGINAL SIZE IN INCHES (22×34 FORMAT)

ORIGINAL SIZE IN INCHES
(11x17 FORMAT)

| SITE INFORMATION | KENT ROAD | WBS#: VZ-00228988.C.9116 | MDG#: 5000913024

SITE ADDRESS

UTILITY POLE# TBD

ADJ TO 2 BALDWIN DR

TOWN OF WAPPINGER

DUTCHESS COUNTY

NY 12590

LINE OF SIGHT PLAN

SHEET NUMBER

LOS-1