IGLESIA CRISTIANA "EL SEMBRADOR"

2368 ROUTE 9D, WHAPPINGER FALLS DUCHESS COUNTY

NY. 11792

SCOPE OF WORK **NEW 2 STORY & CELLAR ADDITION**

SITE PLAN NOTES

1. ALL ELEVATIONS SHALL BE MEASURED IN NAVORS DATUM

2.FOOTPRINT DIMENSIONS ON SITE PLAN MAY NOT REFLECT ACTUAL DIMENSIONS OF NEW/EXIST FOUND DUE TO THICKNESSES OF VARIOUS MATERIALS (IE. SIDING)

3.ALL UTILITY DESIGNATIONS ARE APPROXIMATE AND ARE FOR REFERENCE PURPOSES ONLY.

4. THIS IS AN ARCHITECTS SITE PLAN & IS SUBJECT TO VERIFICATION BY A LICENSED SURVEYOR. THE INFORMATION REPRESENTED ON THIS SITE PLAN IS THE ARCHITECT'S BEST OF KNOWLEDGE AND WAS OBTAINED FROM A SURVEY PREPARED

PJM LAND SUVEYING, PLLC. LAND SURVEYOR 132 CLYDE ST/SUITE 16, WEST SAYVILLE, NY 11796 TEL. (631) 563-0400 DATED:

BUILDING PLAN REVIEW NOTE

TOWN OF WHIPPINGERS BUILDING PLANS EXAMINER HAS REVIEWED THE ENCLOSED DOCUMENT FOR MIN. ACCEPTABLE PLAN SUBMITTAL REQUIREMENTS OF THE TOWN OF ISLIP IN THE BUILDING AND/OR RESIDENTIAL CODE OF THE STATE OF NEW YORK, THIS REVIEW DOES NOT GUARANTEE COMPLIANCE WITH THAT CODE, THAT RESPONSIBILITY IS GUARANTEED UNDER THE SEAL AND SIGNATURE OF THE STATE OF NEW YORK LICENSED DESIGN PROFESSIONAL OF RECORD. THAT SEAL AND SIGNATURE HAS BEEN INTERPRETED AS AN ATTESTATION THAT, TO THE BEST OF THE LICENSEE'S BELIEF AND INFORMATION, THE WORK IN THE DOCUMENT IS:

- CONFORMS WITH THE GOVERNING CODES APPLICABLE AT THE TIME OF
- CONFORMS WITH REASONABLE STANDARDS OF PRACTICE AND WITH VIEW TO THE SAFEGUARD OF LIFE, HEALTH, PROPERTY AND PUBLIC WELFARE
- THE RESPONSIBILITY OF THE LICENSEE
- * THESE PLANS ARE IN CONFORMANCE WITH THE 2020 RESIDENTIAL CODE OF NEW YORK STATE *

DESIGN CRITERIA

BUILDING CODE:

COMERCIAL CODE OF NEW YORK STATE IBC 2018

ELECTRICAL CODE:

2020 NATIONAL ELECTRICAL CODE (NEC)

GAS CODE:

2017 INTERNATIONAL FUEL GAS CODE (IFGC)

MECHANICAL CODE 2020 INTERNATIONAL MECHANICAL CODE (IMC)

PLUMBING CODE:

2020 INTERNATIONAL PLUMBING CODE (IPC)

2020 INTERNATIONAL FIRE CODE (IFC)

FIRE PROTECTION CODE

2020 INTERNATIONAL FIRE PROTECTION CODE (INFP)

NYC EXISTING BUILDING CODE 2018

2018 WOOD FRAME CONSTRUCTION MANUAL (WFCM) BY THE AMERICAN WOOD COUNCIL (AWC)

SPECIES - DOUGLAS FIR LARCH (NORTH) #2 w/ MIN. Fb = 850 PSI (OR BETTER)

SHEARWALL METHOD: PERFORATED SHEARWALL

INSCRIBED STRUCTURE METHOD

2020 ENERGY CONSERVATION CODE OF NEW YORK STATE (COMERCIAL ZONE)

TO THE BEST OF MY KNOWLEDGE, BELIEF, AND PROFESSIONAL JUDGEMENT, THESE PLANS AND/OR SPECIFICATIONS ARE IN COMPLIANCE WITH THE 2020 ENERGY CONSERVATION CODE OF NEW YORK

ZONING DISTRICT HM

		CLI	MATIC AND GE	EOGRAPHIC DES	IGN CRITERIA	CLIMATE ZON	NE C5		
GROUND SNOW LOAD	WIND SPEED	SEISMIC DESIGN CATEGORY	WEATHER INDEX	FROST LINE DEPTH	TERMITE	DECAY	FLOOD HAZARDS	WINTER DESIGN TEMP.	ICE SHIELD UNDERLAYMENT REQUIRED
30 PSF	GROUND SNOW	3	SEVERE	5'-0'	SLIGHT TO MODERATE	SLIGHT	NO	11	YES



RECEIVED

MAR 1 2 2024

Planning Department Town of Wappinger

SCHEDULE OF DRAWING

Z-001 EXISTING-PROPOSED PLOT PLAN

G-001 GENERAL NOTES

G-002 GENERAL NOTES

A-001 EXISTING FIRST FLOOR PLAN & ROOF

A-002 PROPOSED CELLAR FLOOR PLAN

A-003 PROPOSED FIRST FLOOR PLAN

A-004 PROPOSED SECOND FLOOR PLAN

A-005 PROPOSED ROOF PLAN


A-006 SECTION

A-007 SECTION A-008 ELEVATIONS

A-009 ELEVATION

A-010 ELEVATIONS

A-011 DETAILS

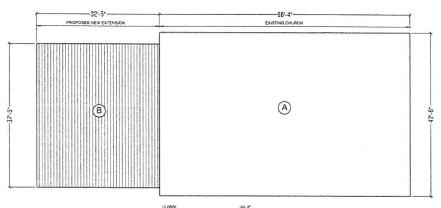

FLOOR DIAGRAM CELLAR FLOOR PLAN

(A) = 66'-4" x 42'-6" = 2819.19 sf (EXISTING) (B) = 32'-5" x 37'-5" = 1212.41 sf (NEW) TOTAL = 4.031.6 sf

FLOOR DIAGRAM 1ST FLOOR PLAN $(A) = 66'-4'' \times 42'-6'' = 2819.19 \text{ sf (EXISTING)}$ (B) = 32'-5" x 37'-5" = 1212.41 sf (NEW) TOTAL = 4.031 6 sf

FLOOR DIAGRAM 2ND FLOOR PLAN (B) = 32'-5" x 37'-5" = 1212.41 sf (NEW) TOTAL = 1212.41 sf

DISTRICT: HI PRINCIPAL BUILDINGS MAXIMUM HEIGHT MIN LOT AREA 35.282 SF ELLAR STORY 2819 19 SE CELLAR STORY | 1 212 41 SE 1ST STORY 2,819.19 SF 1ST STORY 1,212.41 SF GROSS FLOOR AREA 2ND STORY 1.212.41 SF 3,637.23 SF MIN FRONT YARD MIN 2ND FRONT YARD MIN SIDE YARD MIN TOTAL SIDE YARD

ALL DIMENSIONS O BE FIELD /FRIFIFD

COPYRIGHT @

THIS AND ALL DOCUMENTS PRODUCED BY THIS FIRM UNDER THIS AGREEMENT, SHALL REMAIN THE SOLE PROPERTY OF THIS FIRM AND MAY NOT BE USED. COPIED, CHANGED OR DISTRIBUTED BY THE CLIENT OR OTHERS WITHOUT WRITTEN CONSENT OF THIS FIRM.

SCOPE OF WORK:

NEW 2 STORY & CELLAR ADDITION

REVISIONS	DATE	BY
	02-02-2024	
	+	
		_



PROJECT

HARVESTS CHURCH


2368 ROUTE 90 WAPPINGER FALLS 12590 DUCHESS COUNTY NY

INFO



DATE: 11-17-2023 PROJECT No.: DRAWING BY: CHECKED BY: DWG. No.: G-000.00

OF

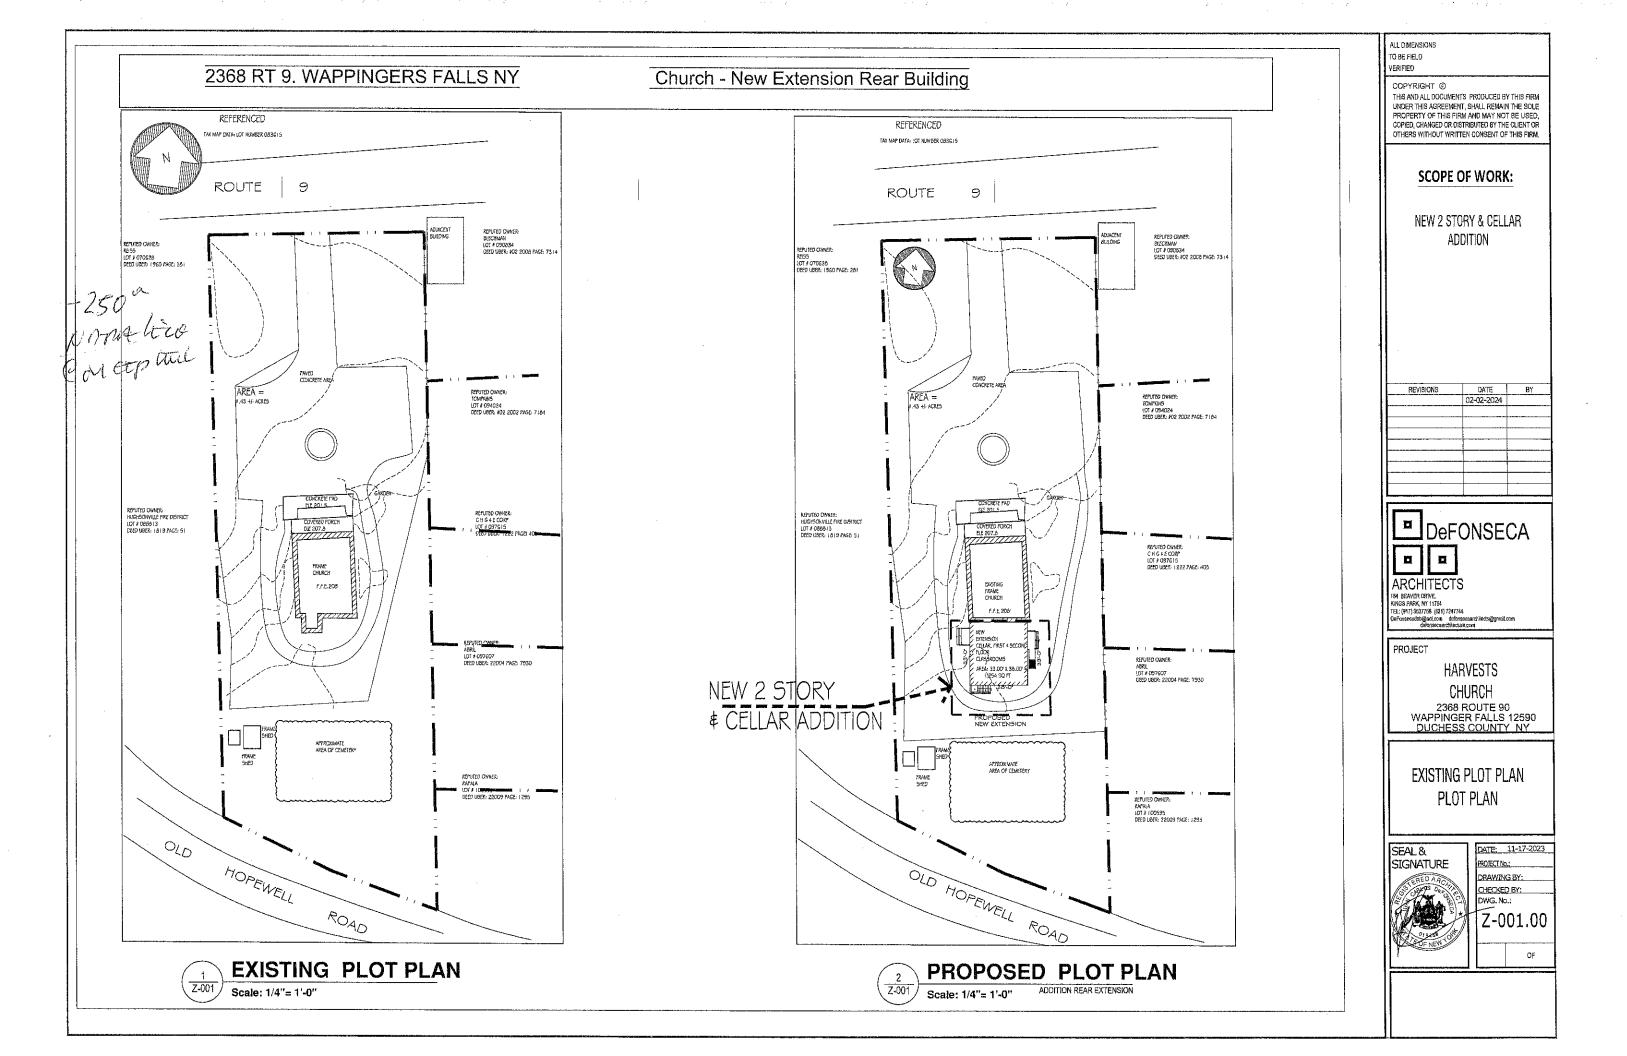

NOTES & SPECIFICATIONS

T IS THE CONTRACTOR'S RESPONSIBILITY TO KEEP THIS CONSTRUCTION OCCUMENT BHOED TOGETHER AT ALL THES, IT IS ALSO THE CONTRACTOR'S RESPONSIBILITY TO READ ALL NOTES, SPECIFICATIONS, AND BE FAMILIARIZED WITH THE PLANS PRIOR TO WORK

CENERAL.

1. NO WORK TO START UNTIL APPROVED PLANS ARE DISTANCO FROM THE APPLICABLE DULLDING DEPARTMENT COMERCIAL CODE OF THE MY.

E. ALL CONSTRUCTION SHALL BE PERFORMED IN A WORKMAN LIKE MANNER ALL DIMENSIONS, CONDITIONS, AND APPLICABLE INFORMATION OF EXISTING STRUCTURE/SITE SHALL BE FIELD VERIFIED BY GENERAL CONTRACTOR.

S. ALL, WORK SHALL CONFORM TO NATIONAL, STATE, AND LOCAL CODES AND AUTHORITIES HAVING JURISDICTION.

4. ALL UNNOTED OR NON-VISIBLE EASEMENTS ARE THE RESPONSIBILITY OF THE OWNER/BUILDER

1 5. ANY OXISSIONS OR DISCREPANCIES OF PLANS AND/OR JOB CONDITIONS SHALL BE CLARIFIED WITH THE ARCHITECT/ENGINEER BEFORE PROCEEDING WITH THE WORK.

B. NO DEVIATIONS OR CHANGES TO THE STRUCTURAL SYSTEM SHALL BE MADE UNLESS APPROVED BY THE ARCHITECT/ENGINEER.

7. CONTRACTOR TO VERIFY DIMENSIONS OF FOUNDATION WITH FLOOR PLANS BEFORE THE START OF FRAMING

B, ORY WELLS AS REQUIRED BY STATE AND LOCAL CODES.

DO NOT SCALE ORAWINGS, WRITTEN DIMENSIONS TAKE PRECEDENCE

O. OWNER/BUILDER ARE RESPONSIBLE FOR ALL INSPECTIONS, APPROVALS, CERTIFICATES, CERT. OF OCCUPANCY OR COMPLETION AND U.L. APPROVAL

1. THESE SET OF DRAWINGS APE THE PROPERTY OF JAMES M. BOULER JR.,
R.A. OR NICHOLAS J. PELUGER, R.A. (WHICH EVER HAS SIGNED AND SEALED THESE PRIMTS)
AND SHALL NOT BE ALTERED OR BE REPRODUCED WITHOUT WRITTEN PERMISSION FROM

2. THE ARCHITECT IS NOT RETAINED FOR SUPERVISION OF THE WORK AND IS RESPONSIBLE FOR DESIGN INTENT ONLY.

3. THE CONTRACTOR SHALL OBTAIN CERTIFICATE OF OCCUPANCY.

4. THE CONTRACTOR SHALL KEEP PREMISES REASONABLY CLEAN AT ALL TIMES. AT THE COMPLETION OF WORK, THE CONTRACTOR SHALL REMOVE ALL RUBBESH, WASTE WATERIAS, TOOLS, ETC., CLEAN GLASS AND LEAVE WORK BROOM CLEAN.

15. THE CONTRACTOR SHALL CARRY WORKMAN'S COMPENSATION AND GENERAL LIMBLITY INSURANCE. ALL SHALL COMPLY WITH STATE AND LOCAL CODES AND ORDINANCES,

6. THE CONTRACTOR SHOULD FULLY GUARANTEE HIS WORK AND THE WORK OF THE SUB-CONTRACTORS FOR A PERIOD OF AT LEAST ONE YEAR AFTER COMPLETION OF PROJECT.

7. THE CONTRACTOR SHALL INDEMNIFY AND HOLD HARMLESS THE DWNER 17. THE CONTRACTOR SHALL INDEMNIFY AND HOLD HANDLESS THE OWNER, MCHIETCH CHOINER, AND THER MOST AND EMPLOYEES FROM AND AGAINST ALL CLAMB. AND AGAINST ALL CLAMB. AND AGAINST ALL CLAMB. AND AGAINST ALL CLAMB. AND AGAINST AND EXPENSES, INCLUDING ATTORREYS FEE ARRING OUT OF RESULTING FROM THE PERFORMANCE OF THE WORK PROVIDED THAT ANY SLOCK CLAMB, DAMAGE, LOSS OF EXPENSE (A) IS ATTRIBUTERLE TO SODBLY MAURY, SICONESS, DISSASE, AND PART OF A MARKET AND AGAINST AGAI ANYONE FOR WHOSE ACTS ANY OF THEM MAY BE LABLE REGARDLESS OF WHETHER OR NOT IS CAUSED IN PART BY A PARTY INDEMNIFIED HEREUNDER.

8. ALL WATERALS, ASSEMBLIES, AND METHOD OF CONSTRUCTION INCLUDING BUT NO BUTE TO FORM-WORK, BLOCK-WORK, FRAMMS, MAILING, PLACING OF CONCRETE, E ARE TO BE CAREFULLY SUPERVISED BY THE CONTRACTOR TO BE SURE THEY ARE MACORDANCE WITH THE DAMINOS, SPECIFICATIONS, APPLICABLE CODES AND GOOD PRACTICE, DEVIATIONS FROM THE DRAWINGS AND SPECIFICATIONS WILL NOT BE PERMITTED WITHOUT WRITTEN AUTHORIZATION OF THE ARCHITECT/ENGINEER.

19. THE CONTRACTOR SHALL BE RESPONSIBLE FOR ANY SHOP DRAWINGS NEEDED, UNLESS DIFFERMISE SPECIFIED. ALL DIMENSIONS AND CONDITIONS PERTAINING ARE TO BE FIELD WERFIELD.

20. CONTRACTOR TO REMOVE & RELOCATE AS REQUIRED ALL EXISTING WORK WHICH INTERFERES WITH NEW CONSTRUCTION IN A WORKMAN LIKE MANNER.

21. ALL MATERIALS ARE TO BE INSTALLED AS PER MANUFACTURER'S SPECIFICATIONS, UNLESS NOTED OTHERWISE.

22. PROVIDE FIREBLOCKING AND DRAFTSTOFFING AS PER 2020 COMERCIAL CODE OF NEW YORK STATE, SECTIONS; RS02.8, R302.7, R302.11, R302.11, R302.12, R1003.19, R1001.12

23. PLEASE NOTE THAT THESE PLANS ARE PROTECTED ASAINST ANY UNAUTHORIZED USE JUDGE FEDERAL LAW BY THE ARCHITECTURAL WORKS COPYRIGHT PROTECTION ACT OF 1990 (AMCPA), WHICH HAS SEVERE PENALTIES.

WHEN KRAFT FACED FIBERGLASS BATT INSULATION IS SPECIFIED IT SHALL BE BY JOHN MANVILLE (OR EQUAL), UNLESS OTHERWISE NOTED. KRAFT FACE TO BE PLACED TOWARD WARM SIDE.

2. When rigio foam insulation is specified for exterior face of foundation walls, care should be taken not to danage foundation waterproofing or insulation from Backfilling.

ALL INSULATION SHALL BE OF THE SPECIFIED VALUE STATED IN PLANS, SECTIONS, STAILS, AND CIAGRAMS. ALL INSULATION SHALL INSTALLED AS PER MANU. SPEC.'S.

4. ALL FOAM PLASTIC INSULATIONS SHALL ADHERE TO THE 2020 COMERCIAL CODE OF NEW YORK STATE.

SYPSUM WALL BOARD

I. CYPSUM WALL BOARD SYSTEMS SHALL BE OF A TAPE JOINT AND JOINT COMPOUND METHOD.

2. ALL GYPSUM BOARD SHAIL BE 1/2" ON WALLS AND CEILING, UNLESS OTHERWISE NOTED. WAYER RESISTANT (W.R.) AT BATHROOMS AND WHERE DEEMED APPLICABLE,

5. 5/8", ONE HOUR RATED, TYPE "X" GYPSUM BOARD ON CELLING AND WALLS (WHERE APPLICABLE) AT HEAT PRODUCING COUPIEKT TO EXTEND THREE FEET IN EACH ORRECTION BETTON THE UNITS). ALSO AT HEAT PRODUCING COUPIEKT, CONCRETE FLOOR OF FULCED ON WOOD FRAME, INSTAIL. CONCRETE PANELS OF 5/8" THICKNESS MINIMUM.

A. FINISH JOINTS, J-BEADS, MAIL DIMPLES, CORNERS, AND EDGES SHALL BE TAPED AND RECEIVE THREE COATS OF JOINT COMPOUND. ALLOW 24 HOURS TO ORY BETWEEN COATS. FINAL COAT TO BE SANDED SMOOTH.

5. METAL CORNER BEAD TO BE USED ON ALL OUTSIDE CORNERS AND AROUND ALL OPENINGS

5. FASTEN GYPSUM BOARD AS PER FASTENING SCHEDULE ON PAGE A601,

1. ALL LUMBER SHALL BE COUGLAS FIR LARCH (NORTH) #2 OR BETTER (Fb = 850 PSI), UNLESS OTHERWISE NOTED.

ALL LUMBER IN CRAWL SPACES TO BE 18" ABOVE SCRATCH COAT. MAINTAIN 8" MIN. FOUNDATION EXPOSURE.

3. SILLS TO BE P.T. AND SECURELY FLASHED WITH A TERMITE SHIELD, ALSO PROWIDE SILL SCAL/MINULATION. SIZE OF SILL TO BE (2) $2^*\kappa^6$. UNLESS (1) $2^*\kappa^6$ IS NECESSARY TO MATCH FLOOR REGISTS WITH THE ENSITING STRUCTURE.

4. AT FLUSH FRAMING USE 16 GAGE METAL JOISTS HANGERS BY "SIMPSON" (OR EQUAL) 5. MINIMUM, DOUBLE HEADERS AND TRIMMERS AROUND ALL OPENINGS IN FLOORS, ROOFS, AND WALLS - UNLESS OTHERWISE NOTED

6. DOUBLE ALL JOISTS UNDER PARALLEL PARTITIONS, POSTS, AND BATH TUBS, U.O.N.

7. ALL SEAMS, GIRDERS, ETC. TO HAVE MIN. OF 3-1/2" BEARING B. MIN. HEADER TO BE (2) 2"x10" UNLESS OTHERWISE NOTED.

9. ALL WOOD SILLS AND WOOD IN CONTACT WITH MASONRY/CONCRETE TO BE P.T.

10. ALL EXTERIOR SHEATHING SHALL BE NAILED AS PER FASTERING SCHEDULE ON PAGE A601. GENERALLY, SHEATHING IS OF 1/2" THICKNESS ON WALLS AND ROOF AND IS OF GRADE, LANESS OTHERWISE, NOTED, SEE FLOOR PLANS FOR ADDITIONAL MAILING OR OFFERENT MAILING REQUIREMENTS WHEN APPLICABLE.

11. SUB FLOORING, GENERALLY, TO BE OF 3/4" THICKNESS AND OF CDX GRADE, MAILING AS PER FASTENING SCHEDULE ON PAGE ABOT AND GLUED, U.O.N.

12. EXTERIOR SHEATHING TO BE COVERED WITH 'TYVEK' HOUSE WRAP OR APPROVED ROLLS.

13. BLOCK EXTERIOR STUD WALLS AT HALF STORY HEIGHTS AND AT UNSUPPORTED EDGE SEAKS OF EXTERIOR SHEATHING.

14. PROVIDE 'X' CROSS BRACING AT JOISTS, STUDS, AND RAFTERS WHEN SPANS EXCEED $8'\!-\!0''$ AND AT EVERY $8'\!-\!0''$.

15. TOP PLATES TO BE DOUBLED AND LAPPED AT CORNERS, SEE ALSO PAGE A600 TO A604

16. APPLY ALL CONDITIONS ADDRESSED IN FASTENING SCHEDULE AS NECESSARY

17. PROVIDE ALL NAILING AND STRAPPING ADDRESSED ON PAGES AGOD TO AGO4 18. AT "WET WALL" PARALLEL TO JOIST'S FRAME DOUBLE JOIST AS PER CODE. GENERALLY, SEPARATE GOUSE, JOIST THE THICKNESS OF WALL ABOVE. SUB FLOOR SHALL NEVER EXCEED A 16" SPAIN.

19, AT ROUGH OPENINGS PROVIDE ALL APPLICABLE MAILING AND STRAPPING AS PER PAGE

20. "P.1." SPECIFIES PRESSURE PRESERVATIVELY IDEATED LUMBER IM ACCORDANCE W/ AWPA C22; WHERE DRILLING AND/OR CUTTING GOCURS, FIELD TREAT LUMBER W/ COPPER NAPTHENATE WHICH SHALL CONTRAIN 22 COPPER METAL 8Y REPEATED REUSHING, GUPPENC, OR SOARNE UNITL. HE WOOD ABSORBS NO MORE. ALSO, FOR HARDWARE LUSED WITH P.T. LUMBER CONTRACTOR IS TO INSTALL HARDWARE FLAT IS SPECIFIED BY P.T. LUMBER MANUFACTURER SUCH AS: HANGERS, NALS, SCREWS, FLASHING, ANCHOR BOLTS, ETC. FOR LOCATIONS SUCH AS: LOCGER BD, SILL PLATE, DECK CONSTRUCTION, ETC. ANY REFERENCES TO CCA ARE TO REPLACED WITH P.T.

21. LYL (LAMINATED VENEER LUMBER) DENOTES EITHER OF THE FOLLOWING: A. TRUSS JOIST MEMILIAN 2,0C MICROLAM 8. GEORGIA PACIFIC 2,0E G-P LAM PSL (PARALLEL STRAND LUMBER) DENOTES A. TRUSS JOIST MEMILIAN 2,0C PARALLAM ALL TO BE INSTALLED AS PER MANU, SPEC.'6

22. SEE PAGES AGOD TO AGO2 FOR SHEARWALL INFORMATION

GLASS WINDOWS AND DOORS

1.ALL CLAZING SHALL COMPLY WITH SECTION R308 OF INTERNATIONAL COMERCIAL CODE OF THE NY.

2. ALL GLAZING SHALL BE IDENTIFIED AS PER SECTION R308 OF 2020 RCNYS

3. ALL GLASS TO BE A NIM, OF INSULATED LOW-E, DOUBLE PANE GLASS, UNLESS OTHERWISE SPECIFIED.

4. GLASS DOORS AND WINDOWS SHALL NOT BE INSTALLED UNTIL PROPER CLEARANCES ARE PROVIDED.

5, CLAZING IN ALL SKYLIGHTS SHALL BE TEMPERED GLASS

6. GLAZING IN WINDOWS THAT ARE 18" OR LESS OF FINISHED FLOOR, AND HAVE AN INDOMULAL PANE OF GLASS 9 SC OR LARGER, AND HAVE THE TOP EDGE OF GLASS 36" OR MORE ADOVE THE FINISHED FLOOR, AND ARE CAJACENT A WALKING SURFACE SHALL BE TEMPERED GLASS, UNLESS OTHERWISE MOTED.

7. GLAZING IN ALL DOORS SHALL BE TEMPERED GLASS.

8. ALL CLASS UNITS SHALL BE INSTALLED IN STRICT ACCORDANCE WITH MANUFACTURER'S SPECIFICATIONS.

9. ALL WINDOWS TO BE CAULKED AND SEALED AS PER 2020 ENERGY CONSERVATION CODE OF NEW YORK STATE.

10. PROVIDE FLASHING PAINS UNDER ALL SLIDING GLASS DOORS, WINDOWS, OR ANY OTHER TYPE OF GLASS UNIT WHEN WITHIN 6" OF AN EXTERIOR SURFACE.

II. ALL EXTERIOR DOORS ARE TO BE WEATHERED STRIPPED AND PROVIDE ALL SCREENS AND HARDWARE NECESSARY FOR PROPER FUNCTION OF SUCH UNITS.

12. ALL GLASS IS TO BE FREE OF SCRATCHES AND IMPERFECTIONS. GLASS SHOULD BE GLARANTEED BY THE MANUFACTURER FOR A PERIOD OF 5 YEARS. 13. FOR WINDOW MANUFACTURER SUBSTITUTIONS — IT IS THE RESPONSIBILITY OF THE CONTRACTOR TO VERTY HAT THE CHARACTERISTICS OF THE WINDOWS SPECIFIED ON THE PLANS. THE CHARACTERISTICS OF THE WINDOWS SPECIFIED ON THE PLANS. THE CHARACTERISTICS ARE AS FOLLOWS, BUT NOT LUMBED TO: DESIGN PRESSURE, ROUGH OPENING, U. FACIOR, CLIENT MEAN, VENT AREA, AND EGRESS AREA / WORTH AT HEIGHT.

14. ALL WINDOWS AND DOORS SHALL MEET A DESIGN PRESSURE EXCEEDING VALUES IN TABLE 301.2(2) OF 2020 RESIDENTIAL CODE OF NEW YORK STATE.

15, WINDOWS / CLAZING IN TUB/SHOWER ENCLOSURES (INCLUDING "SHOWER DOORS") AND WITHIN STARWAYS SHALL BE TEMPERED CLASS AS PER 2020 RESIDENTIAL CODE, OF NEW YORK STATE, SECTION R308.

PLUMBING

1. CONTRACTOR SHALL INSTALL WATER SUPPLY, DRAIN, WASTE, AND VENT (DWV) SYSTEMS TO NASSAU/SUFFOLK COUNTY OPPT. OF HEALTH SERVICES, LOCAL, BLDG, DEPT., AND PLUMBING SECTIONS OF THE COMERCIAL CODE OF THE MY

2. SITE SANITARY SYSTEMS ARE TO COMPLY W/ N.C.D.H.S./S.C.D.H.S. REQUIREMENTS. 3. PROVIDE HOT AND COLD SHUT OFF VALVES AT ALL FIXTURES.

4. ALL WATER PIPING TO HAVE CLEAN OUTS AT ALL CHANGES IN DIRECTION AND AT BASE OF VERTICAL WASTE PIPES.

5, USE 4" CAST IRON THROUGH FOUNDATION WALL AND PITCHED AT 1/8" PER FOOT.

8. GENERAL TRAP AND WASTE SIZES AS FOLLOWS, UNLESS OTHERWISE NOTED:

- TOILET..... 7. ALL SYSTEMS TO HAVE ONE 3" MAIN VENT STACK AND INCREASED TO 4" THROUGH ROOF. 8, PROVIDE FROST-PROOF HOSE BIBS WITH EASILY ACCESSIBLE DRAIN & DRAIN COCKS AS REO'D. HOSE BIBS SHALL BE PROVIDED WITH BACKFLOW PROTECTION.

9. WASTE FROM CLOTHES WASHERS AND LAUNDRY TUBS ARE TO BE PROVIDED WITH BACK FLOW PROTECTION.

10. THE WATER SUPPLY AND SANITARY SYSTEM SHALL COMPLY WITH LOCAL HEALTH DEPARTMENT STANDARDS AND REGULATIONS.

11. APPROVAL AND INSPECTION IS REQUIRED BY LOCAL JURISDICTION PRIOR TO CONCEALMENT OF PLUMBING.

12. NOTCHING AND BORING OF STUDS, JOISTS, RAFFERS AS PER BUILDING CODE. NO NOTCHING AND BORING OF STRUCTURAL MEMBERS SHALL BE PERMITTED NOR ANY POTENTIAL DAMAGE THEREO.

ELECTRICAL:

1. ALL NEWLY INSTALLED ELECTRICAL WORK OR APPLIANCES SHALL CONFORM TO THE COMERCIAL CODE OF THE NY. SECTIONS FOR ELECTRICAL.

2. CONTRACTOR WILL FURNISH A FIRE UNDERWRITERS CERTIFICATE UPON COMPLETION OF WORK.

ELECTRICAL WIRING AND EQUIPMENT TO COMPLY W/ CHAPTERS 34-43 AND LOCAL BUILDING DEPARTMENT.

4. SMOKE DETECTORS AS PER N.Y.S. CODE SECTION R314.

— GENERALLY, VERIFY OR PROVIDE MARD WIRED SMOKE DETECTORS W/ BATTERY BACK-UP IN:

A. EACH SLEEPING ROOM

B. OUTSIDE OF EACH SEPARATE SLEEPING AREA IN THE IMMEDIATE VICINITY OF THE BEDROOMS (GENERALLY THE HALLWAY)

C. EVERY LEVEL OF DWELLING (BASMENT, FIRST FLOOR, & SECOND FLOOR, ETC.)

MECHANICAL, FUEL GAS:

1. MECHANICAL AND FUEL GAS SYSTEMS SHALL COMPLY W/ OF THE NEW YORK CITY BUILDING CODE. SECTIONS FOR MECHANICAL AND FUEL GAS.

FOR ELECTRICAL, PLUMBING, FUEL GAS, AND MECHANICAL SYSTEMS: 1. TRADE CONTRACTORS ARE TO VERIFY THAT THE EXISTING AND PROPOSED SYSTEMS OF THEIR TRADE ARE ABLE TO SUSTAIN THE EXISTING AND PROPOSED LOADING APPLIED TO THAT SYSTEM.

ASPHALT ROOFING SHINGLES

ALL SLOPED ROOFING SHINGLES SHALL BE CAF-CLASS-A ASPHALT ROOFING SHINGLES OR APPROVED EQUAL,

2. SHINGLES SHALL BE APPLIED OVER 15# BUILDING FELT, UNLESS OTHERMISE NOTED, ALSO, CONTRACTORS OPPION TO APPLY GAF—WEATHER—WATCH ICE AND WATER SHRERE FROM EDGE OF EAVE TO 24" INSIDE EXTERIOR WALL LINE. & 24" FROM ALL VALLEYS, AND ROOF FLASHING CONDITIONS.

3. PROVIDE FLASHING NECESSARY FOR WATER TIGHT AND WEATHERPROOF CONSTRUCTION.

RODFING IS TO BE APPLIED IN STRICT ACCORDANCE WITH MANUFACTURER'S SPECIFICATIONS.

5. NAILING OF ROOFING SHALL BE TO CODE.

6. CORROSION RESISTANT 11 CAGE ROOFING NAILS AND 18 GAGE STAPLES ARE PERMITTED

7. PROMDE (2) LAYERS OF 15# ASPHALT BUILDING FELT UNDERLAYMENT FOR 2:12 PITCHES TO 4:12 PITCHES

SITE WORK 1. STAKEOUT IS TO BE PERFORMED BY A LICENSED SURVEYOR

2. VERIFY ALL GIVEN DATA ON DRAWINGS. IF THERE IS A DISCREPANCY, RECEIVE CLARIFICATION FROM ARCHITECT/ENGINEER PRIOR TO PROCEEDING.

3. EXCAYATE AND BACK FILL FOR WORK INDICATED ON DRAWINGS. STOCKPILE TOPSOID OBTAINED FROM STRIPPING DRIVEWAY AND BUILDING SITE. STOCKPILE ALL EXCAYATED MATERIALS.

4. NEW AND EXISTING BACK FILL MATERIAL ARE TO BE FREE OF WEEDS, TREE ROOTS, ROCKS, AND DEBRIS. ALL SURPLUS MATERIAL THAT IS UNSUITABLE FOR BACK FILL MATERIAL SHALL BE REMOVED FROM SITE.

5. PROTECT TREES WITHIN EIGHT FEET OF THE BUILDING

NOTCHING AND BORING OF SOLID SAWN RAFTERS
NOTCHES IN THE TOP OR BOTTOM EDGE OF SOLID SAWN RAFTERS SHALL NOT BE CUIT IN
THE MIDDLE ONE—THING OF THE RAFTER SHAN, NOTCHES IN THE CUITER THINDS OF THE
SPAN SHALL NOT EXCEED ONE—SIXTH OF THE ACTUAL, RAFTER DEPTH, WHERE NOTCHES ARE
MADE AT SUPPORTS THEY SHALL NOT EXCEED ONE—FORTH THE ACTUAL, RAFTER DEPTH
BORED HOLES ARE LWIFED IN DIAMETER TO GNE—THIRD THE ACTUAL, RAFTER DEPTH AND
THE EDGE OF THE HOLE SHALL NOT BE CLOSER THAN 2 INCHES TO THE TOP OR BOTTOM
EDGES.

NOTCHING AND BORNG OF STUDS SHALL NOT BE LOCATED IN THE MIDDLE DIRE-THIRD NOTCHES IN BITHER EDGE OF STUDS SHALL NOT BE LOCATED IN THE MIDDLE DIRE-THIRD OF THE STUD LENGTH SHALL NOT EXCEDE 25% OF THE ACTUAL DEPTH. BORED HOLES SHALL NOT EXCEDE 40% OF THE ACTUAL STUD DEPTH AND THE EDGE OF THE HOLE SHALL NOT BE CLOSED THAN 5/P TO THE EDGE OF THE STUD. NOTCHES AND HOLES SHALL NOT OCCUR IN THE SAME CROSS-SECTION

MATERIALS STANDARDS

THE PROVISIONS OF THIS STANDARD ARE NOT INTENDED TO PREVENT THE USE OF ANY MATERIAL OR METHOD OF CONSTRUCTION NOT SPECIFICALLY PRESORIED HEREIN, WHEN IT CAN BE SHOWN, AND THE AUTHORITY HANGE JURISDICTION FINDS BY EXPERIENCE.

MODELING, OR TESTING BY AN APPROVED AGENCY, THAT A PRODUCT OR PROCEDURE PROVIDES EQUIVALENT OR GREATER STRUCTURAL SAFETY OR DURABILITY, SUCH PRODUCT OR PROCEDURE SHALL BE DEEMED TO CONFORM TO THE REQUIREMENTS OF THIS DOCUMENT (THIS DOCUMENT IS TO MEAN A REFERENCE TO THE CURRENT AMERICAN

WOOD COUNCIL'S WECH WOOD FRAME CONSTRUCTION MANUAL, AS APPLICABLE AS A

M1 IDENTIFICATION

MI TUBERT FICATION

ALL SOUL—SAMM LUMBER, GLUED LAMINATED TIMBER, PREFABRICATED WOOD I—JOISTS,
STRUCTURAL COMPOSITE LUMBER, PREFABRICATED WOOD TRUSSES, GYPSUM, HARDBOARD,
AND STRUCTURAL PARIELS, SHALL CONFORM TO THE APPLICABLE STANDARDS OR GRACING
BUILDS SECRETED IN M. TUBERLICH M. 9.

M 1.1 LUMBER
ALL WOOD MEMBERS USED FOR LOAD-BEARING PURPOSES, INCLUDING END-JOINTED AND
EDGE-GLIED LUMBER, SHALL BE IDENTIFIED BY THE GRADEMARK OF A LUMBER GRADING OR
INSPECTION AGENCY WHICH PARTICIPATES IN AN ACCREDITATION PROGRAM, SUCH AS THE
AMERICAN LUMBER STANDARDS COMMITTEE OR EQUIVALENT. THE GRADEMARK SHALL INCLUDE AN EASILY DISTINGUISHABLE MARK OR INSIGNIA OF THE GRADING AGENCY WHICH COMPLIES WITH THE REQUIREMENTS OF U.S. DEPARTMENT OF COMMERCE PS20-99.

M 1.2 GLUED LAMINATED TIMBERS
GLUED LAMINATED TIMBERS SHALL MEET THE PROVISIONS OF ANSI/ALTC A 1 90.1 STRUCTURAL GLUED LAMINATED TIMBERS.

M 1.3 PREFABRICATED WOOD I-JOISTS

M 1.3 PREFABRICATED WOOD 1-JOISTS
ASSEMBLES USING PREFABRICATED WOOD 1-JOISTS SHALL MEET THE PROVISIONS OF ASTM
DS055 STANDARD SPECIFICATION FOR ESTABLISHING AND MONITORING STRUCTURAL
CAPACITIES OF PREFABRICATED
WOOD 1-JOISTS, THIS DOCUMENT, THE COVERNING BUILDING CODE AND ANY ADDITIONAL
REQUIREMENTS AS SET FORTH IN THE MANUFACTURER'S CODE EVALUATION REPORT.

M 1.4 STRUCTURAL COMPOSITE LUMBER SINGLE MEMBERS OR ASSEMBLIES USING STRUCTURAL COMPOSITE LUMBER SHALL MEET THE PROVISIONS OF ASSEMBLIES USING STRUCTURAL COMPOSITE LUMBER SHALL MEET THE PROVISIONS OF ASSEMBLIAND LOCAL COMPOSITE LUMBER SHALL MEET THE PROVISIONS OF ASSEMBLIAND SPECIFICATION FOR EVALUATION OF STRUCTURAL COMPOSITE LUMBER GROUNDS ASSEMBLIAND SPECIFICATION FOR EVALUATION OF STRUCTURAL

COMPOSITE LUMBER PRODUCTS,
THIS DOCUMEN, THE GOVERNING BUILDING CODE, AND ANY ADDITIONAL REQUIREMENTS AS SET FORTH IN THE MANUFACTURER'S CODE EVALUATION REPORT.

M 1.5 PREFABRICATED WOOD TRUSSES ASSEMBLIES USING PREFABRICATED WOOD TRUSSES SHALL MEET THE PROVISIONS OF THIS DOCUMENT, OF THE NEW YORK CITY BUILDING CODE., AND ANY ADDITIONAL REQUIREMENTS AS SET FORTH IN ANSI/TPI I NATIONAL DESIGN STANDARD FOR METAL PLATE CONNECTED WOOD TRUSS CONSTRUCTION, THE TRUSS

DESIGN DRAWINGS, OR THE MANUFACTURER'S CODE EVALUATION REPORT. M 1.5 GYPSUM
GYPSUM MATERIAL USED IN A STRUCTURAL APPLICATION SHALL MEET THE PROVISIONS OF
ASTM 0.35 6 SPECIFICATION FOR GYPSUM WALEBOARD, ASTM 0.37 SPECIFICATION FOR GYPSUM LATH, OR C7ASTM 9 SPECIFICATION FOR GYPSUM SHEATHING BOARD.

M 1.7 HARDBOARD HARDBOARD USED IN A STRUCTURAL APPLICATION SHALL MEET THE PROVISIONS OF ANSI/AHA A135.4 BASIC HARDBOARD OF ANSI/AHA AL35.6 HARDBOARD SIDING. M 1.8 STRUCTURAL PANELS

M 1.8.1 PLYWOOD
PLYWOOD USED IN STRUCTURAL APPLICATIONS SHALL MEET THE PROVISIONS OF
U.S. DEPARTMENT OF COMMERCE VOLUNTARY PRODUCT STANDARD I (PS 1) CONSTRUCTION
AND INDUSTRIAL PLYWOOD, U.S. DEPARTMENT OF COMMERCE VOLUNTARY PRODUCT
STANDARD 2 (PS2) PERFORE STANDARD FOR WOOD-BASED STRUCTURAL— USE PANELS,

M 1.8.2 ORIENTED-STRAND BOARD (OSB), WATERBOARD ORIENTED-STRAND BOARD OR WATERBOARD USED IN STRUCTURAL IONS SHALL MEET THE PROVISIONS OF U.S. DEPARTMENT OF CORNINERCE VOLUNEARY PRODUCT STANDARD 2 (PSE) PERFORMANCEVOLUNEARY PRODUCT STANDARD FOR WOOD-BASED STRUCTURAL- USE PANELS OR APPLICABLE CODE EVALUATION

M 1.8.3 PARTICLEBOARD
PARTICLEBOARD USED IN STRUCTURAL APPLICATIONS SHALL CONFORM TO ANSI A208.1 AND ANY REQUIREMENTS AS SET FORTH IN THE MANUFACTURER'S CODE EVALUATION REPORT.

IN 1.3.4 FIDEADORAU FIBERGOARD USED IN STRUCTURAL APPLICATIONS SHALL MEET THE PROMISIONS OF ANSI/AHA A194.1 CELLULOSIC FIBERBOARD OR ASTM C208 STANDARD SPECIFICATION FOR CELLULOSIC FIBER INSULATING BOARD.

M 1.6.3. STRUCTURAL PANEL SIDING STRUCTURAL PANEL SIDING USED IN STRUCTURAL APPLICATIONS SHALL MEET THE REQUIREMENTS OF U.S. SEPARTMENT OF COMMERCE VOLUNTARY PRODUCT STANDARD (FG= 1), THE GOVERNING BUILDING CODE, AND ANY ADDITIONAL REQUIREMENTS AS SET FORTH IN APPLICABLE CODE EVALUATION REPORTS.

M 2.2 FASTENERS AND CONNECTORS ALL FASTENERS AND CONNECTORS SHALL CONFORM TO THE STANDARDS SPECIFIED IN M 2.2.1 THROUGH M 2.2.7. M 2.2.1 BOLTS

BOLTS STALL COMPLY WITH ANSI/ASME B 18.2.1 SQUARE AND HEX BOLTS AND SCREWS (INCH SERIES).

M 2.2.2 LAC SCREWS LAG BOLTS SHALL COMPLY WITH ANSI/ ASME 818.2.1 SQUARE AND HEX BOLTS AND SCREWS (MCH SERIES). M 2.2.3 TRUSS METAL CONNECTOR PLATES
TRUSS METAL CONNECTOR PLATES SHALL MEET THE REQUIREMENTS OF
ANALYTPI 1 ANTIONAL DESIGN STANDARD FOR METAL PLATE CONNECTED WOOD TRUSS
CONSTRUCTION, THE GOVERNING BUILDING CODE, AND ANY ADDITIONAL REQUIREMENTS AS

M Z2.2" METAL CONNECTORS WHERE METAL PLATE OR STRAPPING SIZE AND GAGE ARE SPECIFIED, MINIMAIN ASTM A653, STRUCTURAL QUALITY, GRADE 33 STEE SHALL BE USED. OTHER METAL CONNECTORS SHALL MEET THE REQUIREMENTS OF THE OVERNING BUILDING CODE AND ANY ADDITIONAL REQUIREMENTS AS SET FORTH IN THE MANUFACTURER'S CODE EVALUATION

M 2.2.5 NAILS NAILS SHALL COMPLY WITH ASTM F 1667 STANDARD SPECIFICATION FOR DRIVEN FASTENERS: NAILS, SPIKES, AND STAPLES.

M 2.2.6 PNEUMATIC MAILS AND STAPLES
PNEUMATIC NAILS AND STAPLES SHALL MEET THE REQUIREMENTS OF THE NEW YORK CITY
BUILDING CODE AND ANY ADDITIONAL REQUIREMENTS AS SET FORTH IN THE MANUFACTURER'S CODE EVALUATION REPORTS.

M 2.2.7 SCREWS SCREWS SHALL COMPLY WITH ANSI/ASME 8 18.6.1 WOODSCREWS (INCH SERIES).

SET FORTH IN THE MANUFACTURER'S CODE EVALUATION REPORTS.

FOUNDATION, CONCRETE, AND MASONRY

2. ALL FOOTINGS TO BEAR ON FIRM, VIRGIN, UNDISTURBED SOIL

3. SOIL TO HAVE MIN. BEARING CAPACITY OF (1) TON/SO. FT.

7. FOOTINGS TO BE POURED CONCRETE OF SIZE SHOWN ON DRAWINGS. 8, ALL OPENINGS FOR BEAM POCKETS, UTILITIES, ETC. TO BE FILLED SOLID WITH CONCRETE.

9. ANCHOR BOLTS SHALL BE IN ACCORDANCE WITH PAGE AGOD.

11. CONG, SLABS TO REST ON MIN, OF 6" FINE GRAVEL OR SAND WITH 8 MIL POLYETHYLENE VAPOR BARRIER UNDER OCCUPIED SPACE

12. FLASH ALL JOINTS WHERE SLAS ABUTS FRAMING.

13. BRICK VENEER TO BE ANCHORED WITH (1) WALL TIE PER (3) SQ. FT.

16. NO CONCRETE OR MASONRY WORK IS TO BE PERFORMED IN TEMPERATURES OF 40°F AND FALLING, UNLESS APPROVED BY ARCHITECT/ENGINEER, NO CONCRETE SHALL BE PLACED ON FROZEN SURFACES.

19. UNLESS OTHERWISE INDICATED, ALL FOUNDATION FOOTINGS ARE TO BE A MIN. 10" DEEP PROJECTING 6" ON EACH SIDE OF THE FOUNDATION WALL. PROVIDE TWO #4DEFORMED BARS CONTINUOUS IN THE FOOTING. ALL 4" THICK CONCRETE SLABS TO HAVE 6x6 10/10 WELDED WIRE REINFORCING.

ALL MECHANICAL CONNECTIONS SPECIFIED AS "SIMPSON" MAY BE SUBSTITUTED WITH AN APPROVED EQUAL PRODUCT.

MANUFACTIONEN,
ALL LODGE CAPACITIES SHALL MATCH EXACTLY OR EXCEED VALUES INDICATED IN SAMPSON PRODUCT LITERATURE, THERE MAY BE SEVERAL LOADING VALUES, CONTRACTOR SHALL CONTROL THE ANY LOADING VALUES ARE LESS THAN WAY IS SPECIFIED E

THE THROUGH DEEN MISHALED PARAMETERS AND ASSESSED BY ARCHITECT ALL CONNECTORS SPECIFIC AS A "SIMPSON" TOP MOUNTED BEAM HANGER SHALL BE ALLONED TO BE SUBSTITUTED WITH A TOP MOUNTED SEAM HANGER CHLY ALONG WITH SPECIFICATIONS LISTED ASSIVE. HE PRODUCT BEING INSTALLED

I. CONTRACTORS TO VERIFY ALL OMENSIONS OF EXISTING FOUNDATION AS IT APPLIES TO THE NEW WORK BEING PERFORMED AND SHALL COORDINATE THE SUB-CONTRACTORS IN SUCH A MANNER TO ASSURE THAT THE CONDITIONS OF THE FIRST AND SECOND FLOORS ARE TAKEN NTO ACCOUNT.

4. FOOTINGS TO REST A MIN. OF $3^\prime\!-\!0^{\prime\prime}$ BELOW GRADE, UNLESS OTHERWISE NOTED

5. WALLS TO BE POURED CONCRETE OF SIZE SHOWN ON DRAWINGS. 6, NO BACK FILL SHALL BE PLACED AGAINST FOUNDATION WALLS UNTIL 15T TIER OF FRAMING IS IN PLACE.

10. SEE FOUNDATION PLAN FOR CONCRETE COMPRESSIVE STRENGTH.

15. APPLY (1) COAT OF TAR BASED WATERPROOFING TO EXTERIOR OF FOUND. FROM FOOTING TO 2" ABOVE FINISH GRADE.

17. NO ADDITIVES SHALL BE PLACED IN CONCRETE UNLESS SPECIFIED BY ARCHITECT/

18. PROVIDE diffuningus joints between slags and foundation walls and where ever applicable.

20. FOR SECOND STORY ADDITIONS, EXIST, FOUNDATIONS ARE TO BE VERIFIED AS IN SOLID & SOUND CONDITION WITH AN EXIST, FOOTING OF MIN. 18" WHOE X 8" DEEP & 3"-0" BELOW GRUDE.

21. ALL P. CONC. SHALL BE AIR ENTRAINED

THE SUBSTITUTION SHALL MEET ALL OF THE MINIMUM CRITERIA SPECIFIED BY "SIMPSON"
HAN IFACTISFER

"Samson"

ALL Mediamacal Connections shall be hot dipped galvanized
installation procedures shall always be carried out as per manufacturer
specifications of the product being installation.

ALL Fastening criteria shall be carried out as per manufacturer specifications.

NEW 2 STORY & CELLAR ADDITION

DATE

02-02-2024

DeFONSECA

HARVESTS

CHURCH

2368 ROUTE 90

WAPPINGER FALLS 12590

DUCHESS COUNTY NY

GENERAL NOTES

BY

REVISIONS

ARCHITECTS

TEL: (917) 3537758 (631) 7247744

delonsecaarchitecture,com

64 BEAVER DRIVE.

KINGS PARK, NY 1175

PROJECT

THIS AND ALL DOCUMENTS, PRODUCED BY THIS FIRM

UNDER THIS AGREEMENT, SHALL REMAIN THE SOLE

PROPERTY OF THIS FIRM AND MAY NOT BE USED, COPIED, CHANGED OR DISTRIBUTED BY THE CLIENT OR

OTHERS WITHOUT WRITTEN CONSENT OF THIS FIRM.

SCOPE OF WORK:

ALL DIMENSIONS TO BE FIELD VERIFIED COPYRIGHT (0)

SEAL & SIGNATURE

ROJECT No.: DRAWING BY: CHECKED BY: DWG. No.: G-001.00

DATE: 11-17-2023

OF

POURED CONCRETE AND STEEL REINFORCEMENT NOTES:

- ALL EXCAVATIONS SHALL NOT UNDERMINE EXIST, ADJACENT FOUNDATIONS BY AN ANGLE OF 45' PROJECTED OUTWARD AND DOWNWARD FROM THE BOTTOM OF EXISTING ADJACENT FOOTINGS
- 2. IF WATER ENCOUNTERED DURING POURING OF CONC., EXCAVATION SHALL BE DEWATERED. THE POUR SITE SHALL REMAIN DRY FOR ENTIRETY OF POUR CONTACT ARCHITECT WHEN WATER ENCOUNTERED
- CONCRETE MIX DESIGN SHALL BE PERFOMED BY THE CONCRETE PLANT'S PROFESSIONAL ENGINEER AND IN ACCORDANCE WITH ACI 318
- 4. POURED CONCRETE SHALL BE KEPT MOIST FOR A MIN. OF 14 DAYS
- ALL FOUNDATION WORK SHALL BE MIN. 3,000 PSI POURED CONCRETE AT 28 DAYS AND SHALL CONFORM TO THE CURRENT ACI 318 CODE (3,500 MIN. PSI FOR PORCH, PATIO, GARAGE SLABS, AND BASEMENT
- ALL RÈINFORCEMENT BARS SHALL BE DEFORMED EPOXY COATED CARBON. STEEL ASTM A615 GRADE 60, WWM FOR SLABS DO NOT NEED TO BE
- 7. U.O.N., REBAR LAPS SHALL BE A MIN. OF 40 DIAMETERS. ALL LAPS SHALL BE STAGGERED
- 8. PROVIDE MECHANICAL DEVICES TO HOLD STEEL & HARDWARE IN PLACE AT TIME OF POURING & MAINTAIN REQUIRED CLEARANCES, COVERAGES, AND PLUMBNESS
- 9. CEMENT SHALL CONFORM TO ASTM C-33 FOR STANDARD WEIGHT CONCRETE
- 10. ALL POURED CONCRETE SHALL BE AIR ENTRAINED
- 11. 1/2" EXPANSION JOINTS @ PERIMETER OF ALL SLABS

ADDITIONAL FOUNDATION NOTES:

- 1. SEE FLOOR PLANS FOR LOCATIONS OF HOLDOWNS AND COORDINATE AS SEO,D
- 2. SOLID BLOCK ALL POINT LOADS TO THE FOUND, OR BEAM RELOW IT
- 3. PRESSURE TREATED LUMBER (DENOTED AS "P.T.) SHALL BE ACQ IN ACCORDANCE w/ AWPA U1
- 4. ALL EXTERIOR HARDWARE (BOLTS, HANGERS, NUTS, WASHERS ETC.) SHALL BE STAINLESS STEEL AS PER ASTM F1667 OR HOT DIPPED GALV. STEEL AS RECOMMENDED BY MANUFACTURER OR AS PER ASTM A153 AND ASTM A653 TYPE G185 ZINC COATED GALV, STEEL,
- 5. V.I.F. ALL EXIST. FOUND,'s TO BE OF MIN. 8" THK, WALL w/ MIN. 16"x8" DEEP P. CONC. FOOTING TO 3'-0" BELOW GRADE; IF NOT, CONTACT ARCHITECT PRIOR TO CONSTRUCTION.
- 6. MASON TO DETERMINE HEIGHT OF NEW FOUND. WALL IN FIELD TO ACCOUNT FOR:
- 6.1, FINISHED FLOORING TO ALIGN W/ EXIST.
- 6.2. DIFFERENCE IN JOIST SIZE
- 6.3. NUMBER/THICKNESS OF SILL PL's
- 6.4. SUB-FLOOR THICKNESS, ETC.
- 6.5. MAINTAIN 8" FOUND. EXPOSURE @ EXT. (VERIFY THIS CONDITION IN FIFLO)

INTERIOR F.J. LEDGER:

1. SEE NOTED DETAIL FOR MORE INFORMATION

SPREAD FOOTING 'A':

- 1. 30"x30"x15" DEEP P. CONC. SPREAD FOOTING w/ (4) #4 REBAR EACH WAY, UPON UNDISTURBED SOIL.
- 2. MIN 3" REBAR COVER

TYPICAL STEEL COLUMN SUPPORT:

- 1. 3.5" OUTSIDE DIAMETER SCH. 40 STL. PIPE COLUMN
- 2. CAP PLATE 6" WIDE x 8" LONG x 3/8" THK. STL.
- CAP.L WELDED TO TOP OF STL. COL. FASTENED w/ (4) 1/2" 0 x 4" LONG LAG BOLTS
- (PREDRILLED TO WD. BM)
- 3. BASE PLATE 8" x 8" x 3/8" THK. STL. BASE PL.
- WELDED TO BOTTOM OF STL. COL. FASTENED w/ (4) 1/2" HOOKED ANCHOR BOLTS EMBEDDED
- MIN. 6" INTO FOOTING

PROTECTION FROM HEAT PRODUCING EQUIPMENT:

- 1. PROVIDE 5/8" TYPE 'X' GYPSUM BOARD @ CEILING OVER HEAT PRODUCING FOUIPMENT
- 2. CONFIGURE GYP. DB. TO MIN. 3'-0" BEYOND EACH EDGE OF THE FOUIPMENT

FOR WOOD STAIRS @ GRADE:

- 4" THK. P. CONC. PAD 8" WIDE x REQ'D LENGTH UPON 6" GRAVEL
- 2. DECK STAIR SHALL HAVE 2"x12" P.T. STRINGERS @ MAX. 12" O.C., U.O.N. (MIN 3 STRINGERS)
- 3. FASTEN STRINGERS TO SLAB w/ "L" BRACKETS BY 'SIMPSON' (OR EQUAL)

DECK TIE:

- 1. 'SIMPSON' DTT1Z DECK TENSION TIE
- 2. INSTALL AS PER MANU. SPEC.'s

PROVIDE SOLID BLOCKING FROM POST ABOVE TO BEAM

CANTILEVER NEW BEAM TO CARRY EXIST. DBL JOIST

FOUNDATION KEY NOTES

TYPICAL P. CONC. FOUNDATION WALL & P. CONC. FOOTING CONSTRUCTION:

- 1. 8" P. CONC. FOUND. WALL AS PER NOTED DETAIL
- 2. 20"x8" DEEP P. CONC. FOOTING AS PER NOTED DETAIL
- 3. SEE DETAIL 1/A603 FOR MORE INFORMATION

TYPICAL BASEMENT SLAB CONSTRUCTION:

- 1. 4" THICK (MIN.) P. CONC. SLAB w/ 6x6 10/10 WWM OVER 6 MIL POLY VAPOR BARRIER OVER 6" COMPACTED FILL
- V.I.F. PRIOR TO ALL CONSTRUCTION THAT EXIST, FOUNDATION IS IN SOLID AND SOUND CONDITION w/ MIN. 8" THK. WALL AND 16"x8" P. CONC. FOOTING. IF NOT, CONTACT ARCHITECT.

NEW ACCESS WAY:

- 1. BREAK OUT OR SAW CUT EXIST. FOUND. FOR NEW ACCESSWAY
- 2. APPROX. SIZE OF CLEAR OPENING SHALL BE 3'-0"x6'-4" (VI.E.)
- 3. PROVIDE P.T. HDR AND POSTS AS NOTED ON PLANS
- 4. PROVIDE COPPER FLASHING @ ALL INTERFACES OF CONC. AND FRAMING.

POINT LOAD FROM ABOVE POST (TYP.)

BEAM POCKET IN EXIST, FOUND.:

- 1. FORM OUT BEAM POCKET TO FIT NOTED BEAM DEPTH AND WIDTH. MINIMUM 4" BEARING FOR ALL BEAMS/GIRDERS
- WIDTH SHALL HAVE 1/2" CLEARANCES ON BOTH SIDES OF BEAM PROVIDE ALUM, OR COPPER FLASHING WITH NON-TREATED HIMBER
- 4. ONLY COPPER FLASHING SHALL BE USED WITH TREATED LUMBER

GENERAL CONSTRUCTION NOTES

- 1. THE GENERAL CONTRACTOR AND ALL SUBCONTRACTORS ARE REQUIRED TO CHECK AND VERIFY ALL DIMENSIONS AND FILED CONDITIONS AT BUILDINGS SITE AND PREMISES AND NOTIFY THE LANDLORD, THE INTERIOR DESIGNER OR TENANTS CONSTRUCTION REPRESENTATIVE OF ANY AND ALL DISCREPANCIES AND LIST ANY WORK NOT YET COMPLETED BY LANDLORD BEFORE STARTING WORK.
- ALL WORK ON THIS PROJECT SHALL BE IN ACCORDANCE WITH ALL CODES, (COMERCIAL CODE OF THE NY) SUB CODES AND BUILDING DEPARTMENTS HAVING JURISDICTION GENERAL CONTRACTOR TO CONTACT LOCAL BUILDING OFFICIALS FOR SECONIC REQUIREMENTS FOR THIS USE. ALL NEW PLUMBRING FIXTURES SHALL COMPLY WITH LL29.
- 3. ALL CONTRACTORS SHALL CHECK AND VERIFY ALL FIELD CONDITIONS AND SHALL HAVE SOLE RESPONSIBILITY FOR VERIFICATION OF CLEAR HEIGHTS WITHIN THE PREMISES, ANY DISCREPANCES SHALL BE REPORTED TO THE APPLICANT IMMEDIATELY. THE GENERAL CONTRACTOR IS TOTALLY RESPONSIBLE FOR ALL IMMEDIATED. THE VENERAL CONTRACTOR IS TOTAL RESPONSIBLE FOR ALL PROLING DIMENSIONS AND IS TO CONTACT THE INTERIOR DESIGNER AND/OR THE TENANT'S CONSTRUCTION REPRESENTATIVE FIRST, PRIOR TO BUILDING WALLS, IF THERE IS A QUESTION, TENANTS FIXTURES FIT INTO PLACE WITH NO ROOM FOR
- 4. THE GENERAL CONTRACTORS AND ALL SUBCONTRACTORS WORKING ON THIS PROJECT ARE RESPONSIBLE FOR CONTACTING THE PUBLIC UTILITY COMPANIES SUPPLYING UTILITIES TO THE AREA WHERE THE PROJECT IS LOCATIONS OF UTILITIES, UNDERGROUND OR OVERHEAD, AND SECURE THE PROPER PROCEDURES WHILE WORKING ADJACENT TO, ABOVE OR NEAR SUCH UTILITIES TO AVOID ANY PROBLEMS WITH LOCATIONS OF UNDERGROUND UTILITIES EXPLOSIONS, DISCONNECTION, REMOVAL, ETC.
- 5. GENERAL CONTRACTOR SHALL LAY OUT WORK AS SPECIFIED IN THE DRAWINGS AND SHALL BE HELD RESPONSIBLE FOR PROPER ESTABLISHMENT AND MAINTENANCE OF ALL LINES AND DIMENSIONS. BEFORE DOING ANY WORK, THIS GENERAL CONTRACTOR SHALL VERIFY ALL MEASUREMENTS AND CONDITIONS AT THE SITE AND NOTIFY THE APPLICANT OF RECORD OF ANY DISCREPANCIES VERBALLY AND THEN IN WRITING.
- 6. ALL CONTRACTORS SHALL BE BONDABLE, LICENSED CONTRACTORS POSSESSING GOOD LABOR RELATIONS AND MUST BE CAPABLE OF QUALITY WORKMANSHIP, IN HARMONY WITH OTHER CONTRACTORS WORKING ON THE PROLETY.
- 7. PRIOR TO COMMENCEMENT OF ANY WORK, THE GENERAL CONTRACTOR SHALL CONTACT AND MEET WITH OWNER FOR A PRE—CONSTRUCTION MEETING, AT WHICH THE GENERAL CONTRACTOR WILL PRESENT TO ALL PARTIES A LIST OF NAMES, ADDRESSES, BUSINESS AND HOME TELEPHONE NUMBERS OF THE SUBCONTRACTORS FOR THIS PROJECT.

 THE CENERAL CONTRACTOR, ALL SUBCONTRACTORS OR OUTSIDE SERVICES COMPLETING WORK ON THIS PROJECT SHALL COMPLY WITH ALL THE PROVISIONS
- OF G.S.H.A. (OCCUPATIONAL SAFETY AND HEALTH ACT).
- B. ALL CLEARANCES OF PIPES AND DUCT WORK INSTALLED BY THE GENERAL CONTRACTOR OR SUBCONTRACTORS MUST BE MAINTAINED FOR ADEQUATE HEIGHTS REQUIRED FOR CEILING SYSTEM AND LIGHT FIXTURES. THE STOCK ROOM CEILING (F REQUIRED) SHOULD BE AS HIGH AS POSSIBLE AND WITHIN CODE REQUIREMENTS.
- 9. THE GENERAL CONTRACTOR IS TO ARRANGE WITH THE OWNER FOR THE BUILDING, WHERE BUILDING EQUIPMENT AND MATERIALS AREA TO BE LOCATED AND HOW TRUCK TRAFFIC IS TO BE ROUTED TO AND FROM THE BUILDING. ALL REMOVAL OF CONSTRUCTION DEBRIS TO AN APPROVED DUMPING SITE TO BE INCLUDED IN THE GENERAL CONTRACTOR'S WORK
- 10. AN APPROVAL BY THE OWNER WILL BE REQUIRED IN WRITING AND SIGNED BY THE OWNER, FOR ANY STRUCTURAL CHANCES DURING THE COURSE OF THE CONSTRUCTION PHASE OF PROLECT, AS WELL AS VERIFICATION OF CORRECT INSTALLATION AND SPECIFICATION FOR MISCELLANEOUS STEEL FOR H.V.A.C. EQUIPMENT (IF APPLICABLE), DUCTS, CONDUCTS, ETC. THE GENERAL CONTRACTOR IS TO SUPPLY THE MILLWORK, AS WELL AS SHOP BRAWINGS OF ALL MILLWORK, POR APPROVAL OF ARCHITECT OR OWNER.
- 11. ALL EQUIPMENT, MILLWORK AND FIXTURES SUPPLIED BY THE CONTRACTOR TO BE UNLOADED ASSEMBLED AND INSTALLED BY THE GENERAL CONTRACTOR UNLESS OTHERWISE DIRECTED BY THE OWNER OR ARCHITECT.
- 12. ANY SUBSTITUTIONS OF FINISH MATERIALS MUST BE APPROVED BY THE ARCHITECT OR TENANT'S CONSTRUCTION REPRESENTATIVE IN WRITING, THE TENANT'S GENERAL CONTRACTOR IS RESPONSIBLE FOR SUBMITTING TWO (2) SAMPLES OF EACH SUBSTITUTION.
- 13. EACH CONTRACTOR OR HIS SUBCONTRACTOR PERFORMING WORK SHALL
 MAINTAIN CONTINUOUS PROTECTION OF ADJACENT PREMISES IN SUCH MANNER AS TO PREVENT ANY DAMAGE TO TENANT'S WORK OR ADJACENT PROPERTY AND IMPROVEMENTS BY REASON OF THE PERFORMANCE OF TENANT'S WORK.

 14. PROTECTION OF WORK IN PLACE WORK IN PLACE THAT IS SUBJECT
- 14. PROTECTION OF WORK IN PLACE WORK WORK IN PLACE THAT IS SUBJECT O INJURY SECAUSE OF OPERATIONS BEING CARRIED ON ADJACENT HERETO SHALL BE COVERED, BOARDED UP, OR SUBSTANTIALLY ENCLOSED WITH ADEQUATE PROTECTION. ALL FORMS OF PROTECTION SHALL BE CONSTRUCTED IN A MANNER SUCH THAT, UPON COMPLETION, THE ENTIRE WORK WILL BE DELIVERED TO THE OWNER IN PROPER, WHOLE, AND UNBLEMISHED CONDITION.
- THE APPLICANT IS NOT RESPONSIBLE FOR JOB SITE SAFETY OR EXISTING
- 16. THE STRUCTURAL SYSTEM OF THE BUILDING HAS BEEN DESIGNED TO CARRY A MINIMUM LIVE LOAD AS SPECIFIED IN THE BUILDING CODE OF THE MY. LOADING IMPOSED BY THE CONTRACTOR ON A TEMPORARY OR PERMANENT BASIS SHALL NOT EXCEED SUCH SPECIFIED LOAD.
- 17. ALL WORK SHALL BE PERFORMED IN A MANNER WHICH WILL NOT CREATE ANY WORK STOPPAGE, PICKETING, LABOR DISRUPTION OR DISPUTE OR VIOLATE OWNER'S LABOR CONTRACTS AFFECTING THE BULLING OR INTERFERE WITH THE BUSINESS OR USE OF THE BUILDING. IN THE EVENT OF THE OCCURRENCE OF ANY WORK STOPPAGE, PICKETING, LABOR DISRUPTION OR DISPUTE RESULTING FROM ACTIONS OR OMISSIONS OF THE GENERAL CONTRACTOR OR SUBCONTRACTORS OR ANY SUBTENANT OR CONCESSICAMER, OR THEIR RESPECTIVE EMPLOYEES, CONTRACTORS OR SUBCONTRACTORS, GENERAL CONTRACTOR SHALL, IMMEDIATELY UPON NOTICE FROM LANDLORD, CEASE THE CONDUCT GIVING RISE TO SUCH CONDITION. THIS CLAUSE MUST BE PART OF ALL GENERAL CONTRACTOR AGREEMENTS AND IF SUCH CLAUSE IS NOT INCLUDED, IF WILL NOT RELIEVE THE GENERAL CONTRACTOR OF THE REQUIREMENTS OR WORK STATED HEREIN.
- 18. THE CONTRACTOR SHALL BE SOLELY RESPONSIBLE FOR AND HAVE CONTROL OVER CONSTRUCTION MEANS, METHODS, TECHNIQUES, SEQUENCES, AND PROCEDURES AND FOR COORDINATING ALL PORTION OF THE WORK UNDER THE CONTRACT, UNLESS CONTRACT DOCUMENTS GIVE OTHER SPECIFIC INSTRUCTIONS CONCERNING THESE MAHERS, SEE A.I.A. DOCUMENT A021 GENERAL CONDITIONS OF THE CONTRACT FOR CONSTRUCTION, ARTICLE 3, SECTION 33.1 (1987 EDITION).
- 19. THE INTERIOR DESIGNER SHALL NOT HAVE CONTROL OVER OR CHANGE OF AND SHALL NOT BE RESPONSIBLE FOR CONSTRUCTION MEANS, METHODS, TECHNIQUES, SEQUENCES, OR PROCEDURES, OR FOR SAFETY PRECAUTIONS AND PROCRAMS IN CONNECTION WITH THE WORK, SINCE THESE ARE SOLE CONTRACTOR'S RESPONSIBLITY UNDER THE CONTRACT FOR CONSTRUCTION. SEE ALA. DOCUMENT B141 STANDARD FORM OF AGREEMENT BETWEEN OWNER AND INTERIOR DESIGNER, ARTICLE 2. SECTION 2.6.6 (1987 EDITION)

20. WHEN BIDDING THIS PROJECT, EACH CONTRACTOR SHALL BE RESPONSIBLE FOR VISITING THE SITE PRIOR TO BIDDING AND VERIFYING EXISTING CONDITIONS AS REFLECTED IN THESE CONTRACT DOCUMENTS. ANY EXTRA WORK REQUIRED BUT NOT INCLUDED IN THE DOCUMENTS SHALL BE REPORTED TO THE TENANT OR TENANT'S INTERIOR DESIGNER IMMEDIATELY. THE GENERAL CONTRACTORS AND ALL SUBCONTRACTORS ARE REQUIRED TO FURNISH THE FOLLOWING MINIMUM COVERAGE AND LIMITS OF LIABILITY. IF THE

OWNER'S REQUIREMENT'S ARE MORE STRINGENT, CONTRACTORS ARE REQUIRED TO ADHERE TO MOST STRINGENT REQUIREMENTS.

- WORKMAN'S COMPENSATION, AS REQUIRED BY STATE LAW, AND INCLUDING A. WORKMAN'S COMPENSATION, AS REQUIRED BY STATE LW, AND INCLUDING EMPLOYER'S LIABILITY INSURANCE WITH A LIMIT OF NOT LESS THAN \$2,000,000 AND ANY INSURANCE REQUIRED BY ANY EMPLOYEE BENEFITS ACTS OR OTHER STATUTES APPLICABLE WHERE THE WORK IS TO BE PERFORMED AS WILL PROTECT THE CONTRACTOR AND SUB CONTRACTORS FROM ANY AND ALL LIABILITY UNDER THE AFOREMENTIONED ACTS.
- COMPREHENSIVE GENERAL LIABILITY INSURANCE (INCLUDING CONTRACTOR'S PROTECTIVE LIABILITY) IN AN AMOUNT NOT LESS THAN \$2,000,000 FOR AND ONE OCCURRENCE WHETHER INVOLVING BOOILY INJURY LIABILITY (OR DEATH RESULTING THEREFROM) OR PROPERTY DAMAGE HABILITY OR A COMBINATION RESULTING THEREFROW) OR PROPERTY DAMAGE LIABILITY OR A COMBINATION THEREOF WITH A A GORGEATE LIMIT OF \$2,000.000.5 UICH INSURANCE SHALL PROVIDE FOR EXPLOSION, COLLAPSE AND UNDERGROUND COVERAGE. SUCH INSURANCE SHALL INSURE THE OWNER, FROM GENERAL CONTRACTOR'S AGAINST ANY AND ALL CLAIMS FOR BODILY INJURY. INCLUDING DEATH RESULTING THEREFROM AND DAMAGE TO OR DESTRUCTION OF PROPERTY OF ANY KIND WHATSOEVER AND TO WHOMEVER BELDNING AND ARISING FROM IT'S OPERATIONS UNDER THE CONTRACT AND WHETHER SUCH OPERATIONS ARE PERFORMED BY THE GENERAL CONTRACTOR, SUBGONTRACTORS, OR ANY OF THEIR SUBCONTRACTORS, OR BY ANY ONE DIRECTLY OR INDIRECTLY EMPLOYED BY ANY OF THEM.
- 21. THE GENERAL CONTRACTOR AND OWNER, TO THE FULLEST EXTENT PERMITTED BY LAW ARE TO INDENNIFY, HOLD HARNLESS, AND DEFEND THE ARCHITECT/ENGINEER, ITS CONSULTANTS, AND THE EMPLOYEES AND AGENTS OF ANY OF THEM FROM AND AGAINST ANY AND ALL CLAIMS, SUITS, DEMANDS, LIABILITIES, LOSSES, DAMAGES, AND COSTS ("LOSSES"), INCLUDING BUT NOT LIMITED TO COSTS OF DEFENSE, ARISING IN WHOLE OR IN PART OUT OF THE NEGLIGENCE OF THE CONTRACTOR, ITS SUBCONTRACTORS, THE OFFICERS, EMPLOYEES, AGENTS AND SUBCONTRACTORS OF ANY OF THEM, OR ANYONE FOR WHOSE ACTS ANY OF THEM MAY BE LIABLE, REGARDLESS OF WHETHER OR NOT SUCH LOSSES ARE CAUSED IN PART BY A PARTY INDEWNIFIED HEREUNDER. SPECIFICALLY EXCLUDED FROM THE FOREGOING ARE LOSSES ARISING OUT OF (1) THE PREPARATION OR APPROVAL OF MAPS. DRAWINGS. HERCUNDER. SPECIFICALLY EXCLUDED FROM THE FOREGOING ARE LOSSES ARISING OUT OF (1) THE PREPARATION OR APPROVAL OF MAPS, DRAWINGS, OPINIONS, REPORTS SURVEYS, CHANGE ORDERS, DESIGNS, OR SPECIFICATIONS, AND (2) THE GIVING OF OR FAILURE TO GIVE DIRECTIONS BY THE INTERIOR DESIGNER. ITS CONSULTANTS, AND THE AGENTS AND EMPLOYEES OF ANY OF THEM. PROVING SUCH GIVING OR FAILURE TO GIVE IS THE PRIMARY CAUSE OF TORSE.
- 22. THE GENERAL CONTRACTOR IS REQUIRED TO FAMILIARIZE ALL PERSONS AND SUBCONTRACTOR WORKING ON THIS PROJECT WITH THESE GENERAL NOTES AND THE CONTRACT DOCUMENTS NOTED IN THESE BRAWNIGS.
- 23. THE CONTRACTORS SHALL BE RESPONSIBLE FOR FULLY ACQUAINTING THEMSELVES WITH THE CONTENT AND SCOPE OF THESE SPECIFICATIONS, AND SPECIAL ATTENTION SHOULD BE CIVEN TO THE SPECIFICATIONS THROUGHOUT THE SPAN OF THIS PROJECT. IF WORK IS DECLARED UNACCEPTABLE BY THE OWNER, IT SHALL BE CORRECTED IN A MANNER AND TO A DEGREE OF QUALITY WHICH IS ACCEPTABLE BY THE OWNER.
- THE GENERAL CONDITIONS OF THE "CONTRACT FOR CONSTRUCTION" OCCUMENT A-201, ISSUED BY THE AMERICAN INSTITUTE OF ARCHITECTS, 198-EDITION, RELATES TO THE WORK OF THIS PROJECT AND IS HEREBY MADE A THESE DRAWINGS AS THOUGH FULLY CONTAINED IN THESE DRAWINGS.
- THE TENANT'S GENERAL CONTRACTORS AND ALL SUBCONTRACTORS SHALL 24. HE LEMANTS GENERAL CONTINACTORS AND ALL SUBCONTRACTORS SHALL BE RESPONSIBLE FOR DETAINING THE NECESSARY NUMBER OF COPIES OF DOCUMENT A-201, TO ACQUAINT HIMSELF WITH THE ARTICLES CONTAINED THEREIN AND TO REVIEW WITH ALL SUBCONTRACTORS, SUPPLIERS AND ANY OTHER PARTIES TO THE CONTRACT OR INDIVIDUALS OR AGENCIES ENGAGED ON THE WORK AS TO ITS CONTENTS.
- INE WORK AS IU ITS CONTENTS.

 25. THE AGCHIECT OR OWNER MAY ORDER EXTRA WORK, ALTER, ADD TO, OR DEDUCT FROM THE CONTRACT WORK, THE CONTRACT SUM SHALL BE ADJUSTED ACCORDINGLY, AND SUCH COSTS SHALL BE COMPETITIVE WITH LOCAL CONSTRUCTION COSTS.
- AT THE TIME OF FINAL SUBMITTAL OF BID: ALL COSTS BY THE GENERAL CONTRACTORS TO COMPLETELY FURNISH AND COMPLETE THE WORK CONTINED IN THESE PLANS.
- A WRITTEN GUARANTEE STIPULATING THE WORKMANSHIP & MATERIALS ARE TO BE GUARANTEE FOR ONE YEAR AT NO ADDITIONAL COST TO THE OWNER. ANY DEFECTIVES IN WORKMANSHIP OR MATERIALS SHALL BE REPAIRED OR REPLACED FOR THE SAME PERIOD OF ONE YEAR AFTER ACCEPTANCE OF WORK, UNLESS OTHERWISE NOTED.
- NO CONSTRUCTION EXTRAS FOR MATERIALS OR LABOR WILL BE CONSIDERED OR PAID WITHOUT THE DIRECT AUTHORIZATION AND APPROVAL IN WRITING BY THE ARCHITECT OR OWNER, AGREEING TO SUCH COST.

 THE ISSUANCE OF CREDITS TO BE CALCULATED BASED ON COMPETITIVE RATES AND EQUIPMENT COSTS APPROVED BY THE ARCHITECT.
- THE GENERAL CONTRACTOR SHALL UNLOAD, PROTECT AND INSTALL (INSTALL ONLY IF NOTED TO DO SO). FIXTURES AND FURNISHINGS.
- THE ARCHITECT LEAVES ZERO OR MINIMAL CLEARANCE FOR ERROR IN REGARD TO FIXTURE LAYOUT. "HOLD DIMENSION" INDICATIONS ARE TO BE ADHERED.

ALL DIMENSIONS TO BE FIELD VERIEFO

COPYRIGHT @

THIS AND ALL DOCUMENTS PRODUCED BY THIS FIRM UNDER THIS AGREEMENT, SHALL REMAIN THE SOLE PROPERTY OF THIS FIRM AND MAY NOT BE USED, COPIED, CHANGED OR DISTRIBUTED BY THE CLIENT OR OTHERS WITHOUT WRITTEN CONSENT OF THIS FIRM.

SCOPE OF WORK:

NEW 2 STORY & CELLAR ADDITION

REVISIONS	DATE	BY
	02-02-2024	



PROJECT

HARVESTS CHURCH 2368 ROUTE 90

WAPPINGER FALLS 12590


DUCHESS COUNTY NY

GENERAL NOTES

SEAL & SIGNATURE DATE: 11-17-2023 PROJECT No DRAWING BY: CHECKED BY: DWG. No.:

G-002.00

OF

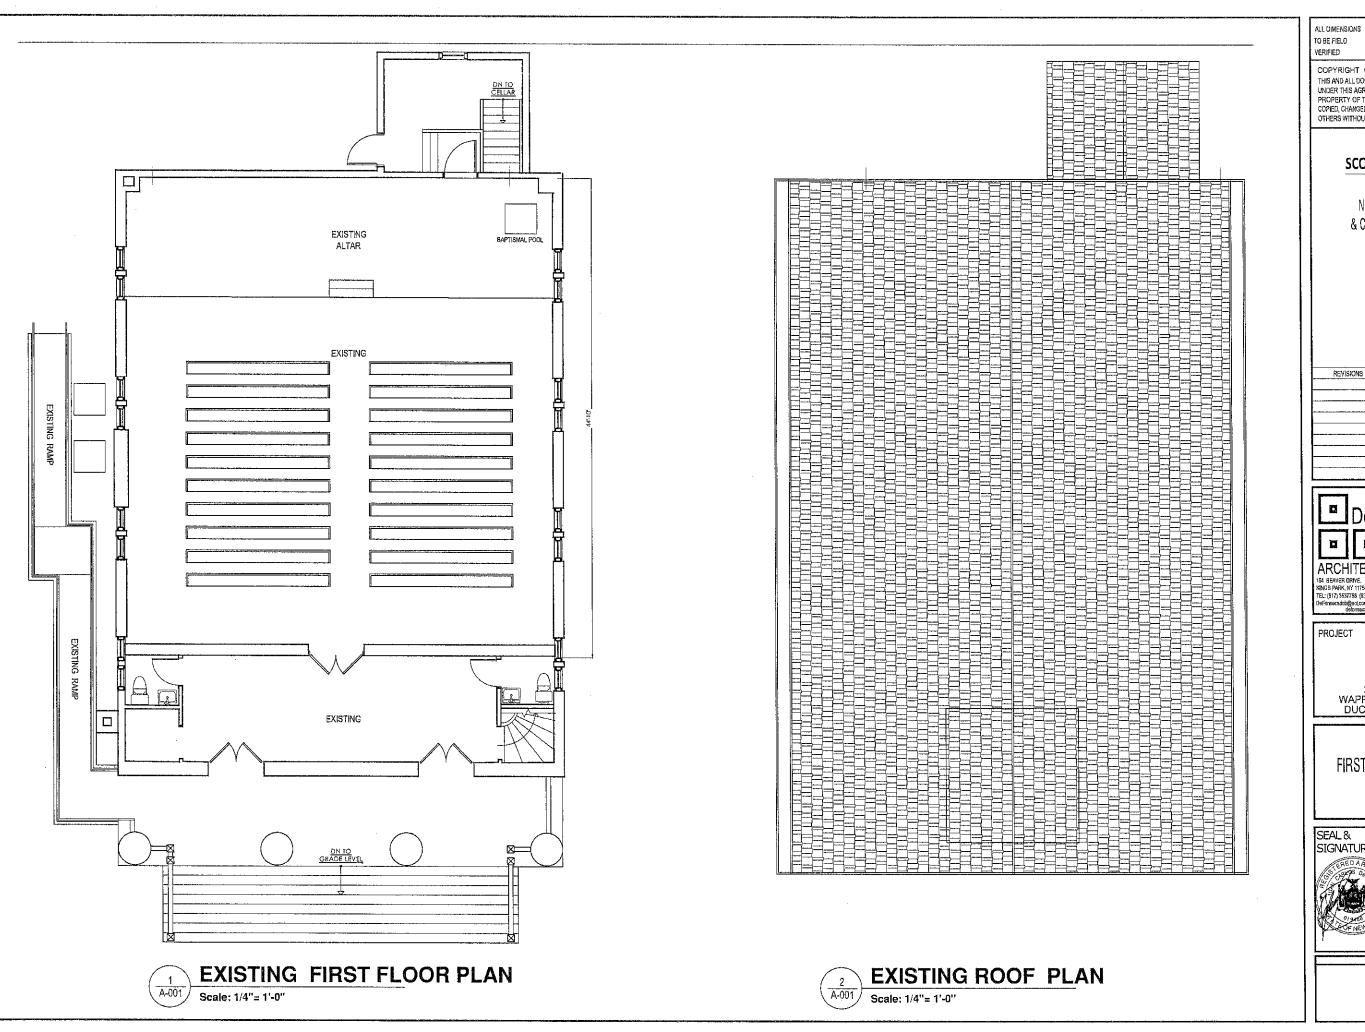

COPYRIGHT

THIS AND ALL DOCUMENTS PRODUCED BY THIS FIRM UNDER THIS AGREEMENT, SHALL REMAIN THE SOLE PROPERTY OF THIS FIRM AND MAY NOT BE USED, COPIED, CHANGED OR DISTRIBUTED BY THE CLIENT OR OTHERS WITHOUT WRITTEN CONSENT OF THIS FIRM.

SCOPE OF WORK:

NEW 2nd STORY & CELLAR ADDITION

REVISIONS	DATE	BY
	1	
	+	
· · · · · · · · · · · · · · · · · · ·		



PROJECT


HARVEST CHURCH 2368 ROUTE 90 WAPPINGER FALLS 12590 DUCHESS COUNTY NY

EXISTING FIRST FLOOR & ROOF PLAN

DATE: 11-17-2023



PROJECT No.: OHECKED BY: DWG, No.: A-001.00 SHEET No.

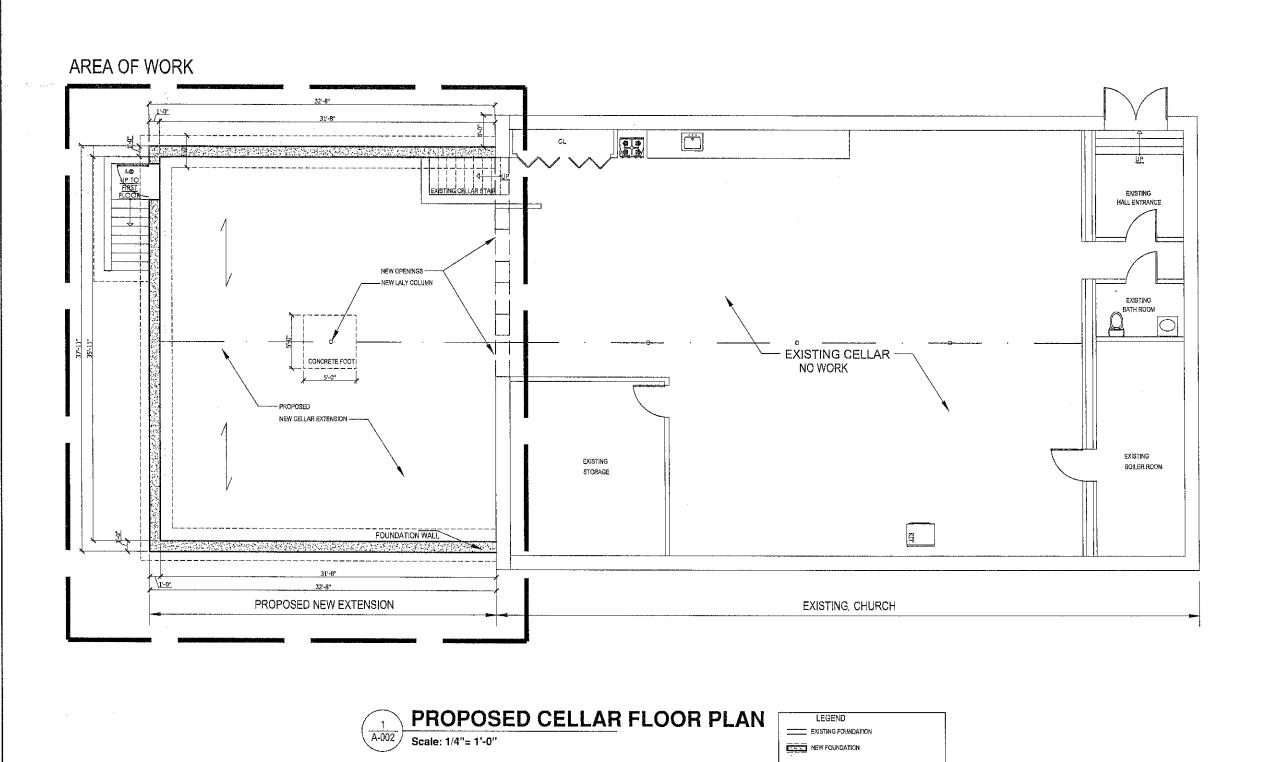

COPYRIGHT ①

THIS AND ALL DOCUMENTS PRODUCED BY THIS FIRM UNDER THIS AGREEMENT, SHALL REMAIN THE SOLE PROPERTY OF THIS FIRM AND MAY NOT BE USED, COPIED, CHANGED OR DISTRIBUTED BY THE CLIENT OR OTHERS WITHOUT WRITTEN CONSENT OF THIS FIRM.

SCOPE OF WORK:

NEW 2nd STORY & CELLAR ADDITION

REVISIONS	DATE	BY
	1	




ROJECT
HARVESTS
CHURCH

2368 ROUTE 90 WAPPINGER FALLS 12590 DUCHESS COUNTY NY

> PROPOSED CELLAR FLOOR PLAN



PROJECT No.: DRAWING BY: CHECKED BY: DWG. No.: A-002.00	
SMEET No. OF	

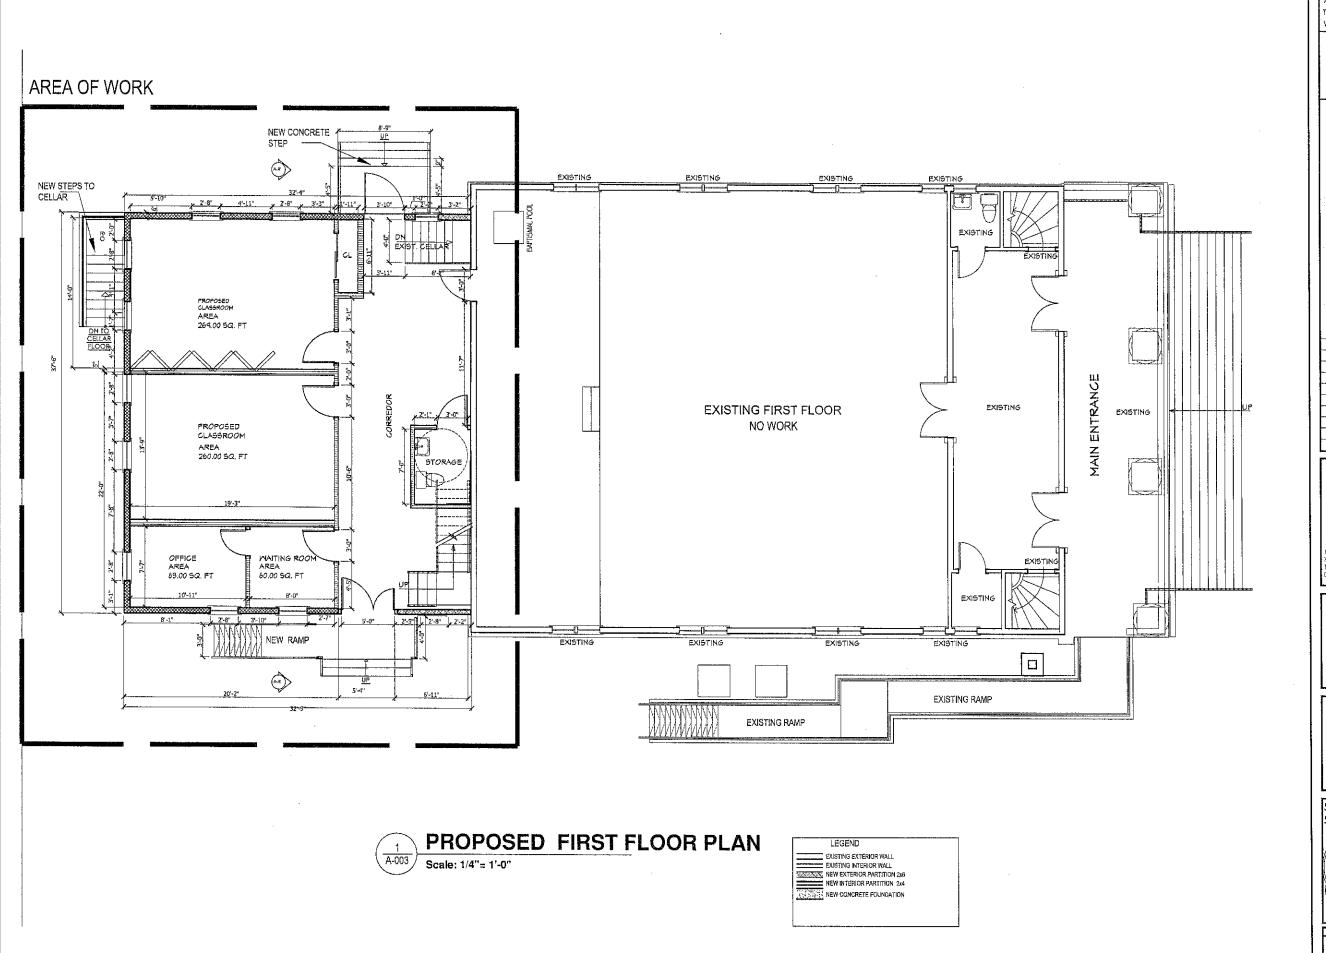

COPYRIGHT ®

THIS AND ALL DOCUMENTS PRODUCED BY THIS FIRM UNDER THIS AGREEMENT, SHALL REMAIN THE SOLE PROPERTY OF THIS FIRM AND MAY NOT BE USED, COPIED, CHANGED OR DISTRIBUTED BY THE CLIENT OR OTHERS WITHOUT WRITTEN CONSENT OF THIS FIRM.

SCOPE OF WORK:

NEW 2nd STORY & CELLAR ADDITION

REVISIONS	DATE	BY



PROJECT

HARVESTS

CHURCH

2368 ROUTE 90


WAPPINGER FALLS 12590
DUCHESS COUNTY NY

PROPOSED FIRST FLOOR PLAN



DRAWIN CHECKE DWG. No	DBY:
A-0	03.00
SHEET No.	OF

PROJECT No.:

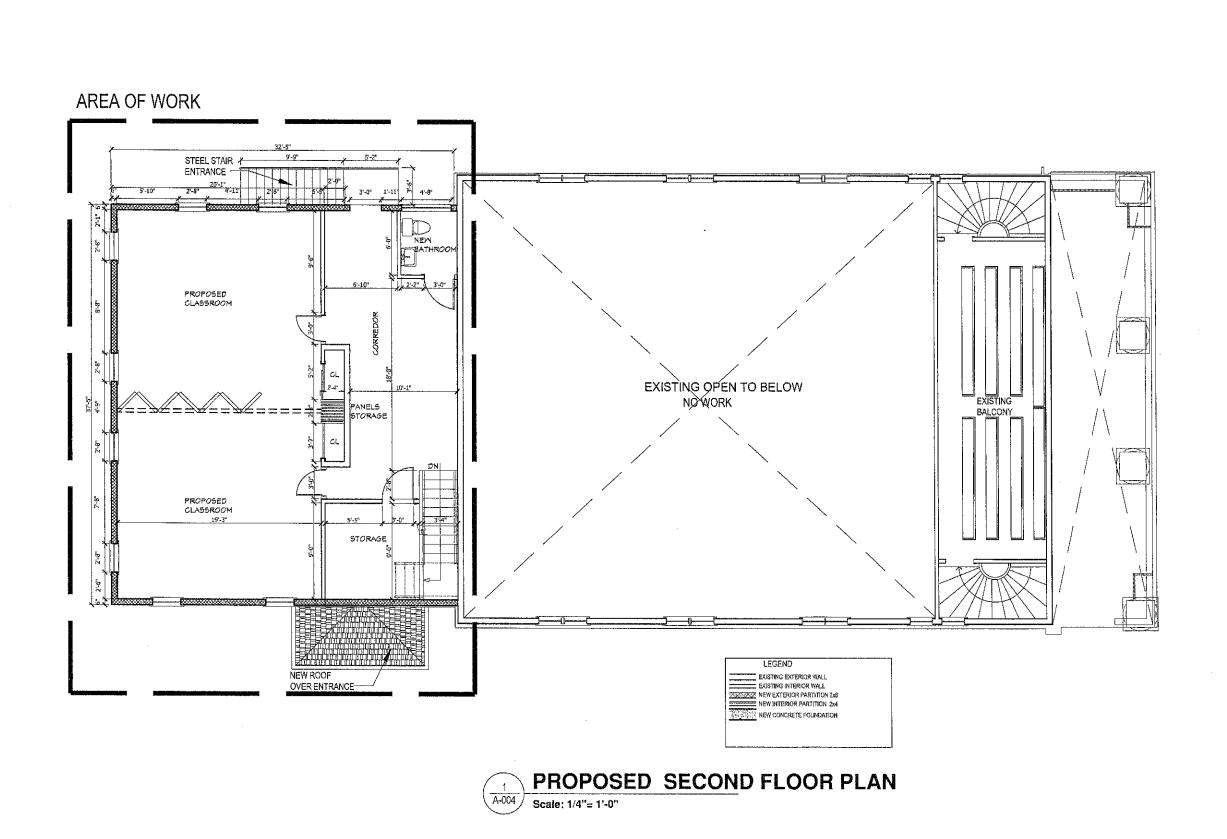

COPYRIGHT @

THIS AND ALL DOCUMENTS PRODUCED BY THIS RIRM UNDER THIS AGREEMENT, SHALL REMAIN THE SOLE PROPERTY OF THIS FIRM AND MAY NOT BE USED, COPIED, CHANGED OR DISTRIBUTED BY THE CLIENT OR OTHERS WITHOUT WRITTEN CONSENT OF THIS FIRM.

SCOPE OF WORK:

NEW 2nd STORY & CELLAR ADDITION

revisions	DATE	BY
	+	
	1	



PROJECT

HARVESTS

CHURCH
2368 ROUTE 90
WAPPINGER FALLS 12590
DUCHESS COUNTY NY


PROPOSED SECOND FLOOR PLAN



DATE: 11-17-2023

ROPCTING:
DRAWING BY:
CHECKED BY:
DWG, NO.:

A-004.00

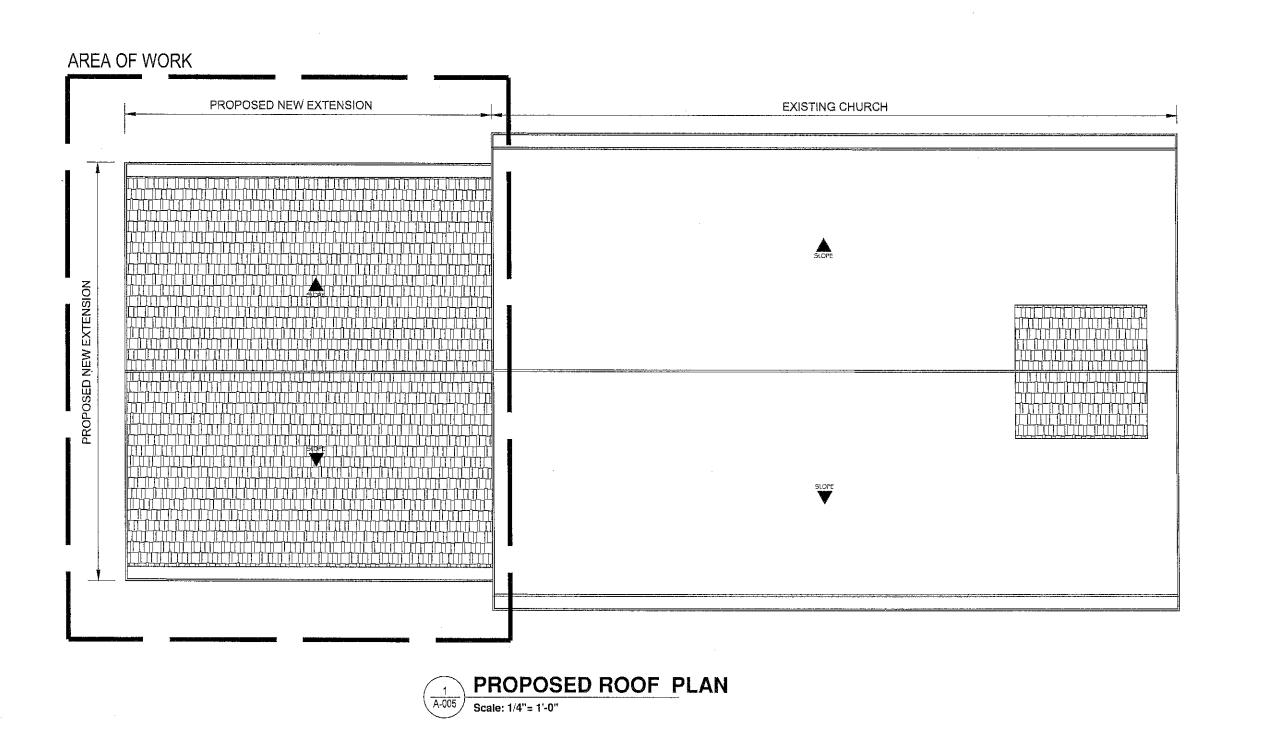

COPYRIGHT @

THIS AND ALL DOCUMENTS PRODUCED BY THIS FIRM UNDER THIS AGREEMENT, SHALL REMAIN THE SOLE PROPERTY OF THIS FIRM AND MAY NOT BE USED, COPIED, CHANGED OR DISTRIBUTED BY THE CLIENT OR OTHERS WITHOUT WRITTEN CONSENT OF THIS FIRM.

SCOPE OF WORK:

NEW 2nd STORY & CELLAR ADDITION

REVISIONS	DATE	BY
	1	
	-	
 	-	



PROJECT

HARVESTS
CHURCH
2368 ROUTE 90
WAPPINGER FALLS 12590
DUCHESS COUNTY NY

PROPOSED ROOF PLAN



DATE: 11-17-2023

PROFICT No.:


DRAWING BY:

OHECKED BY:

DWG, No.:

A-005.00

SHEET No. OF

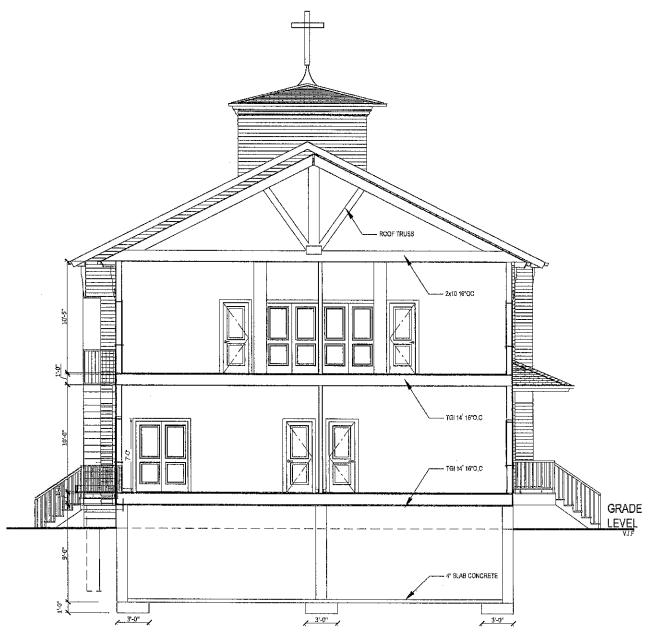

PROPOSED SECTION A-A'
Scale: 1/4"= 1'-0"

ALL DIMENSIONS TO BE FIELD VERIFIED

COPYRIGHT ©

THIS AND ALL DOCUMENTS PRODUCED BY THIS FIRM UNDER THIS AGREEMENT, SHALL REMAIN THE SOLE PROPERTY OF THIS FIRM AND MAY NOT BE USED, COPIED, CHANGED OR DISTRIBUTED BY THE CLIENT OR OTHERS WITHOUT WRITTEN CONSENT OF THIS FIRM,

SCOPE OF WORK:

NEW 2nd STORY & CELLAR ADDITION

REVISIONS	DATE	BY
	-	
	1	
· · · · · · · · · · · · · · · · · · ·	+	



PROJECT


HARVESTS CHURCH

2368 ROUTE 90 WAPPINGER FALLS 12590 DUCHESS COUNTY NY

SECTION



DATE: 11-17-2023
PROJECTINO:
DRAWTING BY:
CHECKED BY:
DWG. NO.:
A-006.00
SHEET NO. OF

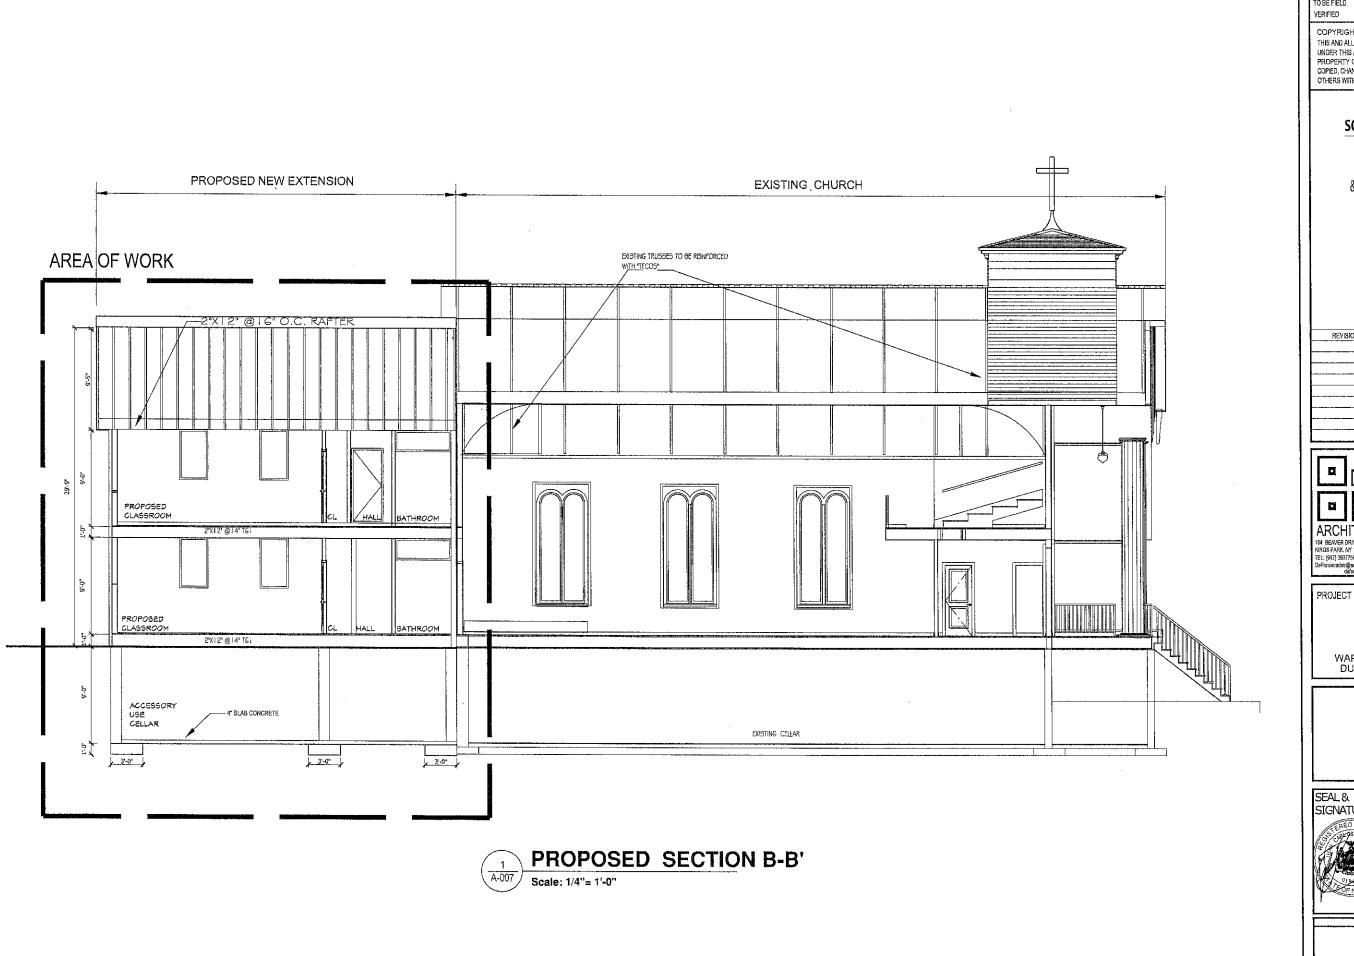

ALL DIMENSIONS TO BE FIELD

COPYRIGHT @

THIS AND ALL OOCUMENTS PRODUCED BY THIS FIRM UNDER THIS AGREEMENT, SHALL REMAIN THE SOLE PROPERTY OF THIS FIRM AND MAY NOT BE USED, COPIED, CHANGED OR DISTRIBUTED BY THE CLIENT OR OTHERS WITHOUT WRITTEN CONSENT OF THIS FIRM.

SCOPE OF WORK:

NEW 2nd STORY & CELLAR ADDITION

		
REVISIONS	DATE	BY
- · · · · · · · · · · · · · · · · · · ·	·	



HARVESTS CHURCH

2368 ROUTE 90 WAPPINGER FALLS 12590 DUCHESS COUNTY NY


SECTION



DATE: 11-17-2023 PROJECT No.: DRAWING BY: CHECKED BY:

A-007.00

SHEET No. OF

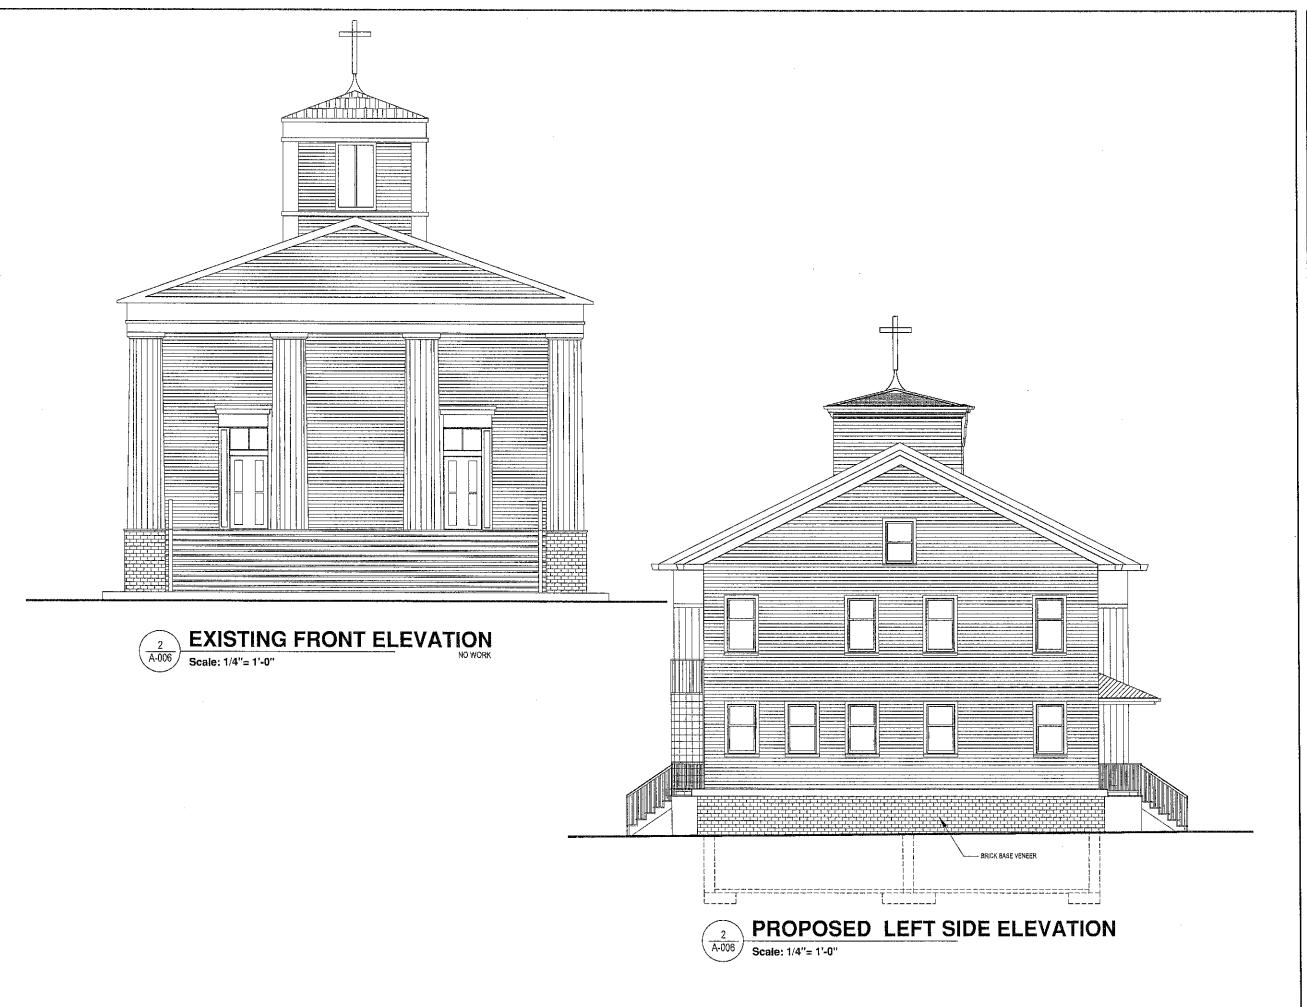

COPYRIGHT
THIS AND ALL DOCUMENTS PRODUCED BY THIS FIRM UNDER THIS AGREEMENT, SHALL REMAIN THE SOLE PROPERTY OF THIS FIRM AND MAY NOT BE USED, COPIED, CHANGED OR DISTRIBUTED BY THE CLIENT OR OTHERS WITHOUT WRITTEN CONSENT OF THIS FIRM.

SCOPE OF WORK:

NEW 2nd STORY & CELLAR ADDITION

REVISIONS	DATE	BY
	1	
	İ	
	1	



PROJECT

HARVESTS CHURCH


2368 ROUTE 90 WAPPINGER FALLS 12590 DUCHESS COUNTY NY

ELEVATIONS



DATE: 11-17-2023 PROJECT No.: DRAWING BY: CHECKED BY: DWG, No.: A-008.00

SHEET No.

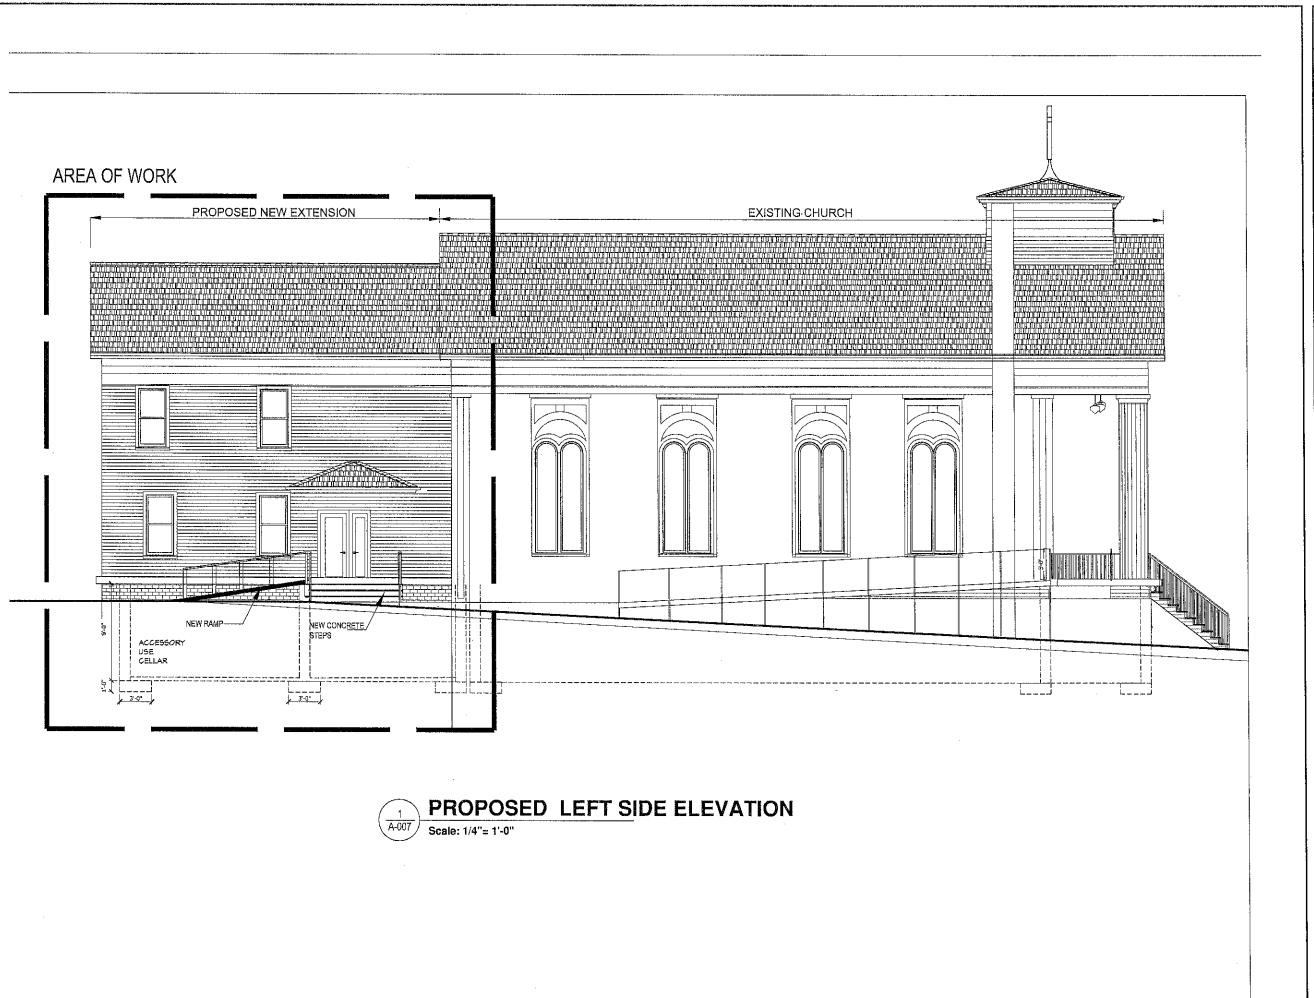

COPYRIGHT ©

THIS AND ALL DOCUMENTS PRODUCED BY THIS FIRM UNDER THIS AGREEMENT, SHALL REMAIN THE SOLE PROPERTY OF THIS FIRM AND MAY NOT BE USED, COPEC HANGED OR DISTRIBUTED BY THE CLIENT OR OTHERS WITHOUT WRITTEN CONSENT OF THIS FIRM.

SCOPE OF WORK:

NEW 2nd STORY & CELLAR ADDITION

REVISIONS	DATE	BY
	ļ	
	1 "	



PROJEC

HARVESTS
CHURCH
2368 ROUTE 90
PINGER FALLS 129

2368 ROUTE 90 WAPPINGER FALLS 12590 DUCHESS COUNTY NY

> LEFT ELEVATION



DATE: 11-17-2023

PROPECT NO:


DRAWTING BY:

CHECKED BY:

DWG, No.:

A-009.00

SHEET OF

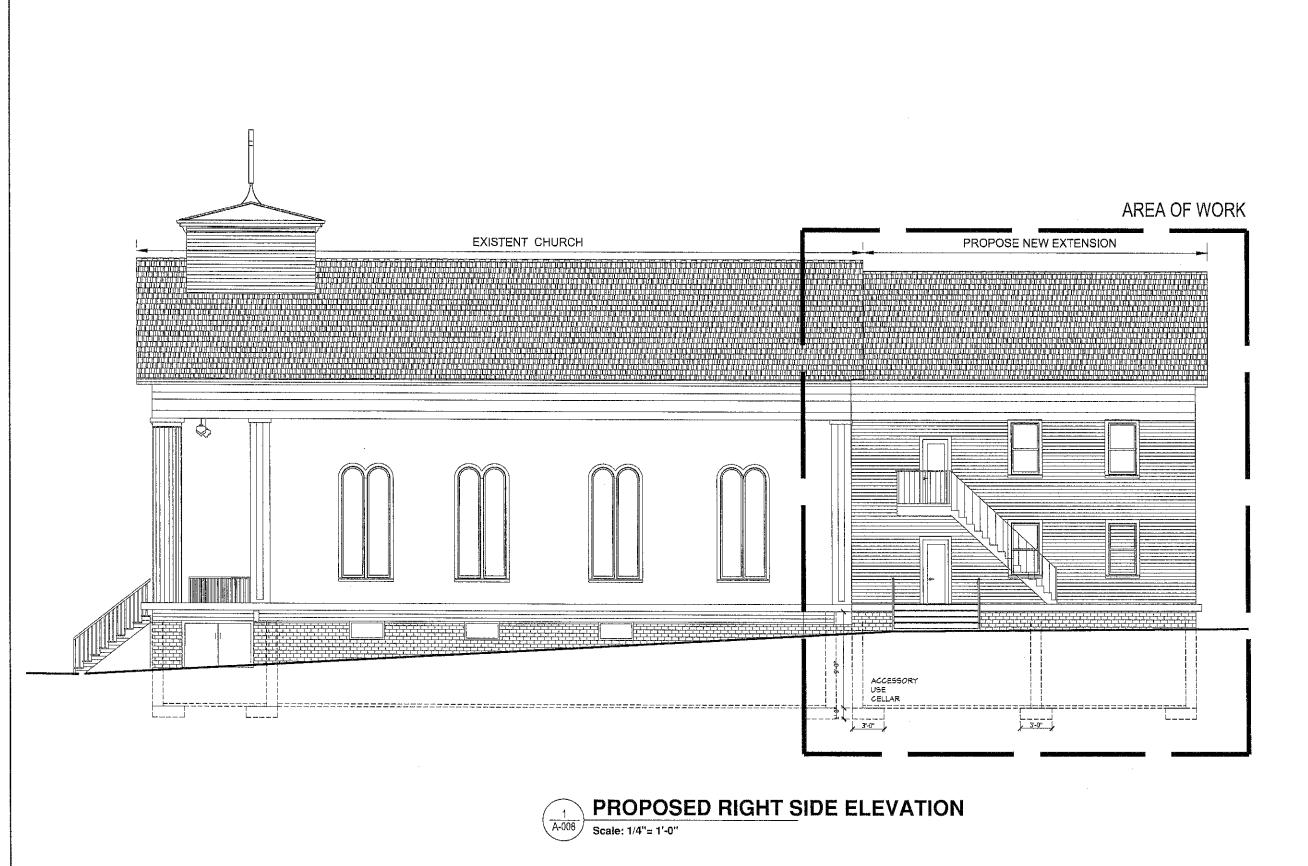

COPYRIGHT ®

THIS AND ALL DOCUMENTS PRODUCED BY THIS FIRM UNDER THIS AGREEMENT, SHALL REMAIN THE SOLE PROPERTY OF THIS FIRM AND MAY NOT BE USED COPIED, CHANGED OR DISTRIBUTED BY THE CLIENT OR OTHERS WITHOUT WRITTEN CONSENT OF THIS FIRM.

SCOPE OF WORK:

NEW 2nd STORY & CELLAR ADDITION

REVISIONS	DATE	BY
	1	



HARVESTS

CHURCH
2368 ROUTE 90
WAPPINGER FALLS 12590
DUCHESS COUNTY NY

RIGHT SIDE ELEVATION




DATE: 11-17-2023

ROKCING:
DRAWING BY:
CHECKED BY:
DWG, No.:


A-010.00

SHEET OF

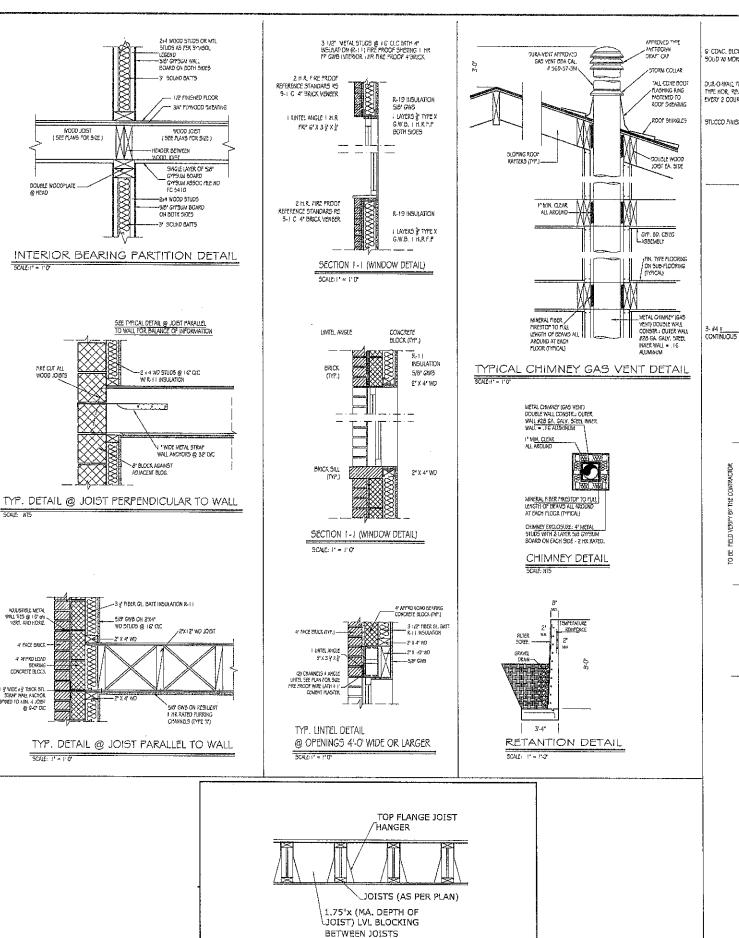



TJI JOIST BLOCKING DETAIL


SCALE: NTS

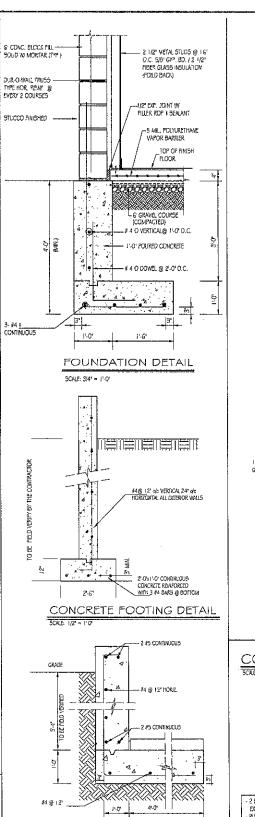

RETAINING WALL DET

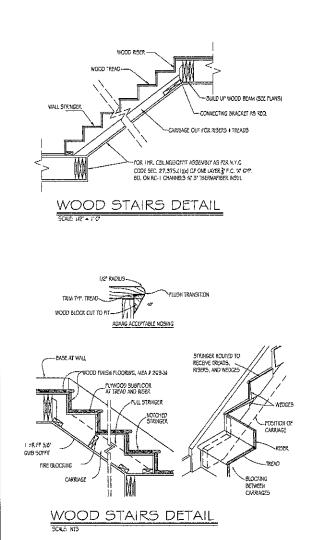


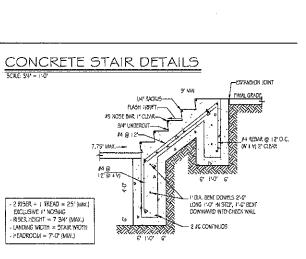

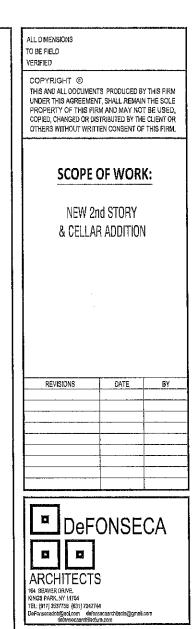





DETAILS

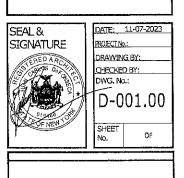


CONCRETE FOUNDATION DETAIL

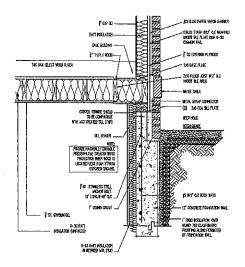


EXTERIOR WALL/ FLOOR CONNECTION DETAIL

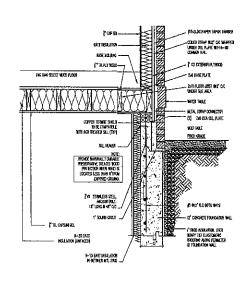


CONCRETE FOOTING UNDER STEEL COLUMN DETAIL

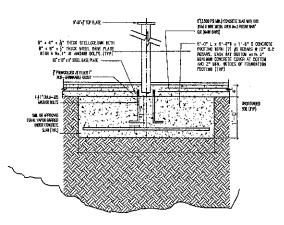

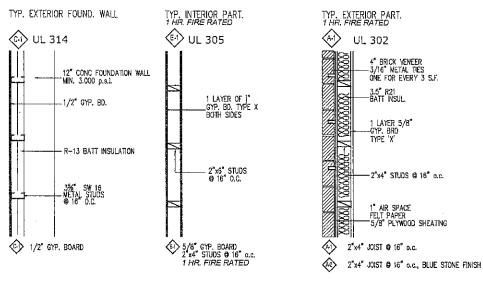

W TYPICAL WALL DETAIL

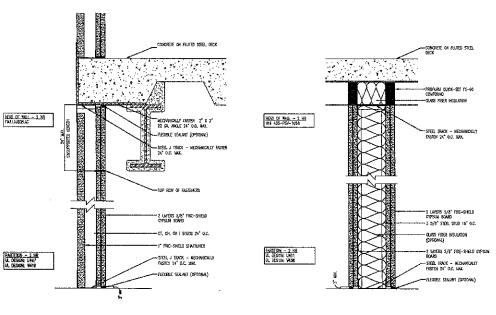

2 HR SHAFTWALL PARTITION

(3) 4/47 GPP, BANCH

(1) 1/5/47 GPP, BANCH


(2) 1/1 5/47 GPP, BANCH
(2) 1/1 5/47 GPP, BANCH
(3) 1/1 5/47 GPP, BANCH
(4) 1/1 5/47 GPP, BANCH
(5) 1/1 5/47 GPP, BANCH
(6) 1/1 5/47 GPP, BANCH
(7) 1/1 5/47 GPP, BANCH
(8) 1/1

(2) 5/8" on: SURED N.T.S.

(2) 5/8" on: SURED N.T.S.

(3) 5/8" on: SURED N.T.S.

(4) 5/8" on: SURED N.T.S.

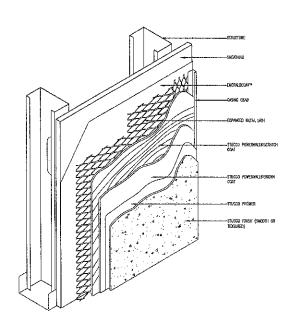

STUCCO FINISH EXTERIOR WALL

S-3-7/6" J 16 MEINS, STRESS © 10° ac.

ALL DIMENSIONS TO BE FIELD


VERIFIED COPYRIGHT ©

THIS AND ALL DOCUMENTS PRODUCED BY THIS FIRM UNDER THIS AGREEMENT, SHALL REMAIN THE SOLE PROPERTY OF THIS FIRM AND MAY NOT BE USED, COPIED, CHANGED OR DISTRIBUTED BY THE CLIENT OR THERS WITHOUT WRITTEN CONSENT OF THIS FIRM.

SCOPE OF WORK:

NEW 2nd STORY & CELLAR ADDITION

REVISIONS	DATE	BY
	1	
	+ +	
	· · · · · · · · · · · · · · · · · · ·	

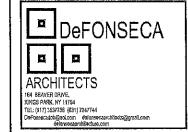

PROJECT

HARVESTS

CHURCH
2368 ROUTE 90
WAPPINGER FALLS 12590
DUCHESS COUNTY NY

DETAILS



DATE: 11-07-2023
PROJECT No.:


DRAWING BY:

CHECKED BY:

DWG. No.:

D-002.00

SHEET
No. OF

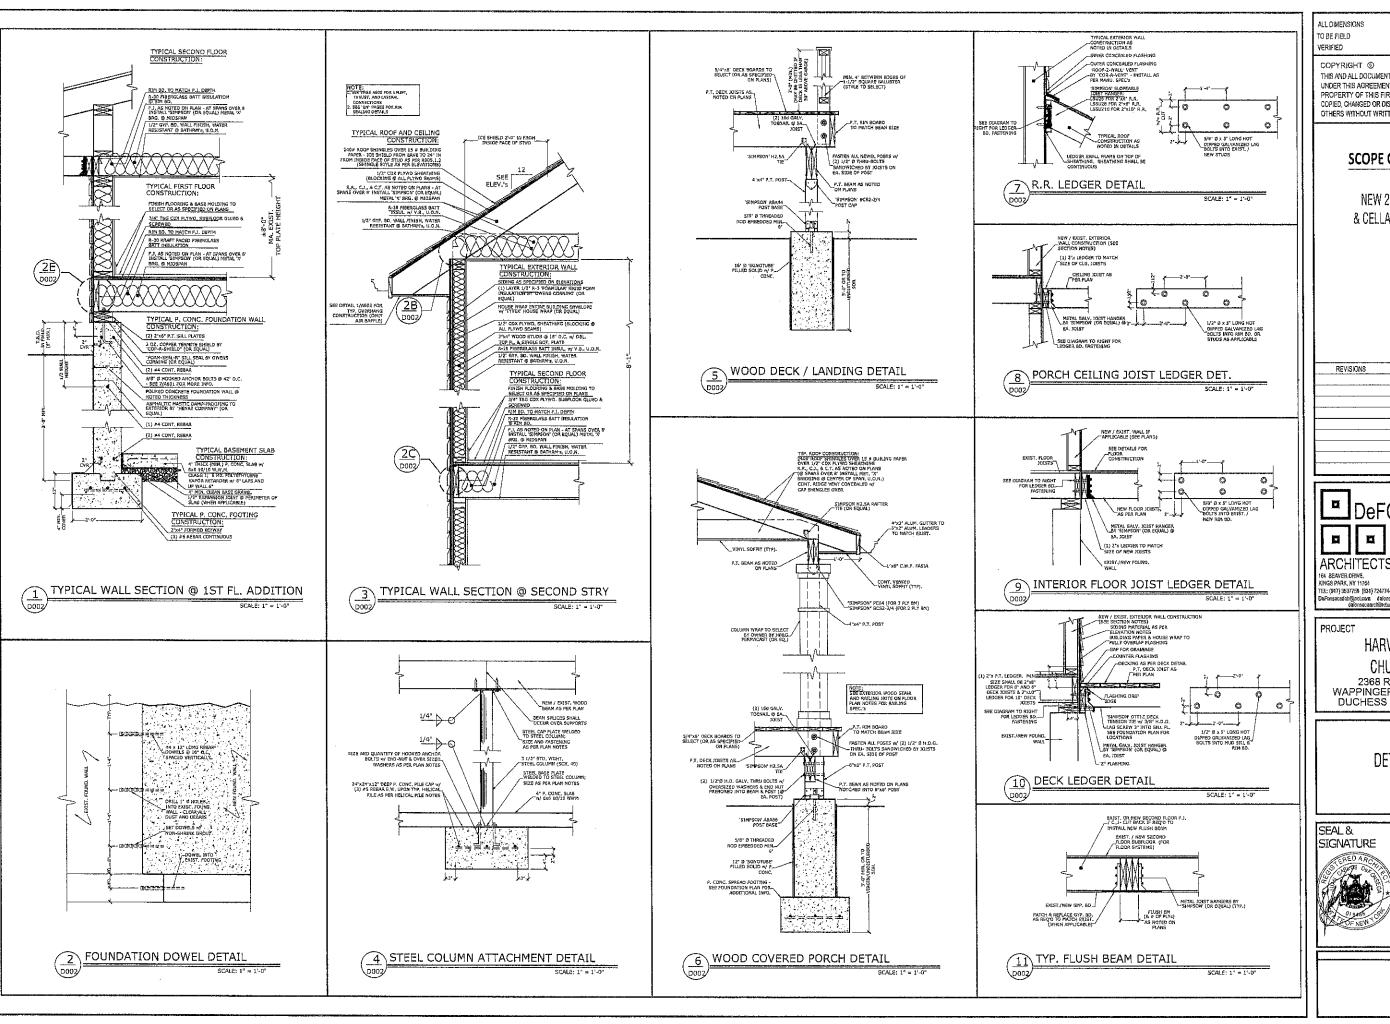

THIS AND ALL DOCUMENTS PRODUCED BY THIS FIRM UNDER THIS AGREEMENT, SHALL REMAIN THE SOLE PROPERTY OF THIS FIRM AND MAY NOT BE USED. COPIED, CHANGED OR DISTRIBUTED BY THE CLIENT OR OTHERS WITHOUT WRITTEN CONSENT OF THIS FIRM.

SCOPE OF WORK:

NEW 2nd STORY & CELLAR ADDITION


DATE	BY
ļ	
· · · · · · · · · · · · · · · · · · ·	
	DATE



HARVESTS CHURCH 2368 ROUTE 90 WAPPINGER FALLS 12590 DUCHESS COUNTY NY

DETAILS



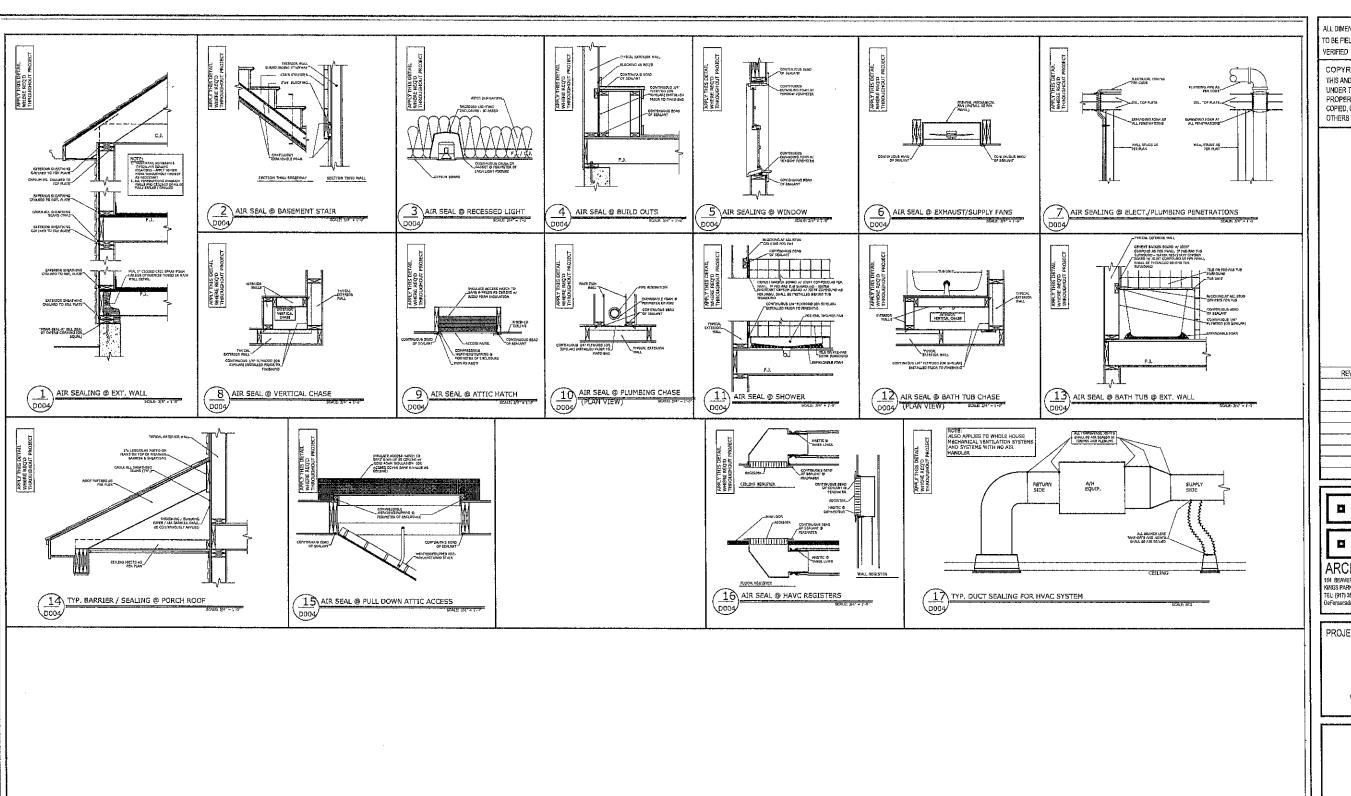

ALL DIMENSIONS TO BE FIELD

COPYRIGHT @

THIS AND ALL DOCUMENTS PRODUCED BY THIS FIRM UNDER THIS AGREEMENT, SHALL REMAIN THE SOLE PROPERTY OF THIS FIRM AND MAY NOT BE USED, COPIED, CHANGED OR DISTRIBUTED BY THE CLIENT OR OTHERS WITHOUT WRITTEN CONSENT OF THIS FIRM.

SCOPE OF WORK:

NEW 2nd STORY & CELLAR ADDITION

REVISIONS	DATE	BY
	1	
	1	
	1	
	+	



PROJECT

HARVESTS CHURCH

2368 ROUTE 90 WAPPINGER FALLS 12590 DUCHESS COUNTY NY

DETAILS



DATE: 11-07-2023 PROJECT No.: DRAWING BY: CHECKED BY: DWG. No.: D-004.00 SHEET No. OF

FASTENING SCHEDULE

NOTE: THIS SCHEDULE DOES NOT INCLUDE NAILING FOR UPLIFT CONNECTIONS (SEE PAGE A601 FOR NAILING OF UPLIFT CONNECTIONS) ALL NAILING IS A GENERAL SPECIFICATION, IT APPLIES UNLESS NOTED OTHERWISE

DESCRIPTION	FASTENER SPEC. AND QUANTITY	FASTENER SPACING
ROOF & C		
RAFTER TO TOP PLATE (TOE-NAIL)	SEE 4A TO 4G / A600	PER RAFTER
CSILING JOIST TO TOP PLATE (TDS-NAIL)	SEE 4A TO 4G / AGOII	PER JOIST
CEILING JOIST TO PARALLEL PAFTER (FACE-HAIL)	SEE 4A TO 4G / A600	SACH LAP
CEILING JOIST LAPS OVER PARTITIONS (FACE-KAIL)	SEE 4A TO 4G / A500	EACH LAP
COLLAR THE TO RAFTER (FACE-MAIL)	3-15d COMMON	PER 17.5
BLOCKING TO RAFTER (TOS-KAIL)	2-84 COMMON	BACH END
RIM BOARD TO SAFTER (END-NAIL)	SEF 4A TO 4G / A600	EACH RAFTER

WALL	FRAMING
------	---------

SEE 4A TO 4G / A609	PER FOOT
4-164 EDMMON	JOISTS - BA. SIDE
2-16d COMMON	24° O.C.
T-169 COMMON	16" O.C. ALONG EDGES
SEE 4A TO 4G / AGOD	PER STUD
2-16d COMMON	PER FOOT
	4-164 COMMON 2-164 COMMON 1-164 COMMON S66 4A TO 45 / ASDD

FLOOR FRAMING

JOIST TO SILL, FOP PLATE or GIRDER (TOE-MAIL)	4-64 COMMON	PER JOIST
PRIDGING TO JOIST (TOE-KAIL)	2-Ud COMMON	EACH END
MUCK(NE TO JOIST (TOF-NAIL)	2-8d COMMON	EACH END
NOCKING TO SILL OF TOP PLATE (TOE-NAIL)	3-16d COMHON	SACH BLOCK
EDGER STRIP TO BEAM (FACE-MAIL)	3-16d COMMON	SACH JOIST
OST ON LEDGER TO BEAM (TOE-VAIL)	3-8d COMMON	72IOL FISS
BAND JOIST TO JOIST (END-HAIL)	3-164 CDMMON	PER JOIST
RAND JUIST TO SILL OF TOP PEATE (TOE-NAIL)	2-164 COMMON	PER FOOT

ROOF SHEATHING

	WOOD STRUCTURAL PANELS (PLYWOOD SHEATHING)	8d COMMON	6" EDGE / 12" FIELD
	CEILING S	HEATHING	
ı	GYPSUM WALLBOARD	SH COOLERS	7" EDGE / 10" FIELD

WALL SHEATHING		
WOOD STRUCTURAL PAMPLS (PLYWOOD SHEATHING)	ad COMMON	6' EDGE / 12" FIELD UNLESS OTHERWISE NOTED FOR INCREASED SHEARWALL CAPACITY, SEE FLOOR PLANS FOR NOTING WHEN APPLICABLE
GYPSUM WALLSCARD	S4 COOLERS	7" EDGE / 10" PIELD
FLOOR SHE	ATHING (SUBFLOOF	U .

WOOD STRUCTURAL PANELS (PLYWD SUBPLOOR):		
1° or LESS	84 COMMON	6" EDGE / 12" FIELD
GREATER THAN 1*	184 COMMON	6" EDGE / 12" PIELD
	l l	l l
	 	

\D005


TYPICAL JOIST HANGERS

FOR JOISTS FLUSH FRAMED TO BEAM - DIMENSIONAL LUMBER		
JOIST SIZE	HANGER	
2"x6"	'SIMPSON' LUSZE (OR EQUAL)	
2"x8"	'SIMPSON' HUS28 (OR EQUAL)	
2'x10"	'SIMPSON' HUSZIO (OR EQUAL)	
2'x12"	'SIMPSON' HU5210 (OR EQUAL)	

FOR RAFTERS FLUSH FRAMED TO BEAM - DIMENSIONAL LUMBER		
RAFTER SIZE	E HANGER	
Z"x6"	'SIMPSON' LRUZ6Z (OR EQUAL)	
Z"x6"	'SIMPSON' LRUZBZ (OR EQUAL)	
2"x10"	"SIMPSON: LRUSSOZ (OR EQUAL)	
2"×12"	'SIMPSON' LRUZIZZ (DR EQUAL)	

FOR 'I'-JOISTS FLUSH FRAMED TO BEAM - PRE ENGINEERED JOISTS		
joist size	HANGER	
	•	
-	-	
<u> </u>	-	
-	-	

BEAM CONNECTIONS 0005/

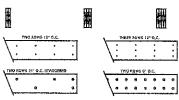


CONNECTION PATTERN SCHEDULE		
CONNECTION PATTERN	DESCRIPTION	
А	(2) ROWS 184 NATLS & 12" D.C.	
В	(3) POWS LEIS NAILS IP LZ* D.C.	
¢	(2) ROWS (/2 ' & BOLTS (3) (2' O.C. STAGGERED) Del. ' 9'	
U	(S) ROWS (/2" % BOLTS © 16" O.C.	
ŧ	(21 ROWS 1/2" 2 BOLTH @ 24" O.C.	
F	SCREMED ON (1) SIDE OF MEMBER	
G	SCREMED ON (1) SLOE OF MEMBER	
li .	SCREWED ON (1) SIDE OF MEMBER	
j	Z ROWS S PLATEOX SCREWS \$ 12" O.C. SCREWED ON BOTH SIDE OF MEMBER	
ĸ	(Z) NOWE S' FLYICOR' SCHEWE & 16 D.C. SCREWED ON BOTH SIDE OF MEMBER	
L	(2) ROY'S S' FLATCOK SCREWS (9 24" D.C., SCREWED ON BOTH SIDE OF MEMBER	

WHEN SCREWING OR KANING FROM BOTH SIDES OF MEMBER - OFFSET FASTSREES 1/2" FROM ONE SIDE TO THE OTHER

0005

CONTINUOUS BUILT-UP GIRDERS

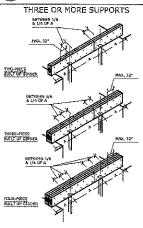


ASSEMBLY REQUIREMENTS:
WHEN TITGERS MADE UP OF DISTS NABED TOGETHER.
WHO IT STORES MADE UP OF DISTS NABED TOGETHER.
WHO IS SHOWN AND CONTINUED SHAT THERE OF MORE
SUPPORTS, JOINTS ARE TO BE LICATED SETWERS ORE
SUPPORTS, JOINTS ARE TO BE LICATED SETWERS ORE
SUPPORTS, JOINTS ARE TO BE LICATED SETWERS OR THE
HER STATE OF THE STATE OF THE STATE OF THE
TO BE JOINTED ON THE SAME SIDE OF THE SUPPORT.

OTHERS STAGGERED WITH A DISTANCE OF 16 INCLES BETWEEN NARS IN A HONIZONTAL LINE; OR GROBES ARE TO BE NAILED FROM BACK SIZE WY IOM NAILS, TWO NEAR EACH END OF EACH JOIST, OTHERS STAGGERED WY A DISTANCE OF 32" BETWEEN NAILS IN A HORIZONTAL LINE.


A DISTANCE OF NOT MORE THAN 32" BETWEEN HALLS IN A HORIZONTAL LINE.

FOUR-PIECE GIOERS ANE TO BE ASSEMILED AS SHOWN, AND NAILED M/ 20d MAILS AS SPECIFIED FOR THE THREE-PIECE GIRDER.

ANCHORING; GROERS ARE TO BE SECURELY ANCHORED TO MASONRY PIERS, MAILEO TO WOOD POSTS OR BOLTEO TO STEEL COLUMNS.

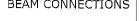



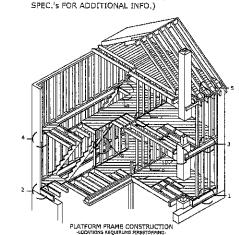

1. FOR PLATFORM FRAME CONSTRUCTION; THE SOLE SERVES AS FIRE-STOPPING

2. FOR PLATFORM FRAME CONSTRUCTION; THE DOUBLE TOIST SERVES AS FIRESLOPPING,

3, FOR PLATFORM FRAME CONSTRUCTION; THE SOLE AND DOUBLE PLATE SERVE AS FIRESTOPPING.

4, POR PLATFORM FRAME CONSTRUCTION: THE OQUBLE 10157 SERVES AS FIRESTOPPING. S, FIRESTOPPING SHALL BE 2 (RICHES OF WOOD BLOCKING OR OF NONCOM-BUSTIBLE PILL.


6, FOR PLATFORM FRAME CONSTRUCTION: THE SOLE AND 2 INCHES OF WOOD BLOCKING PLACED BETWEEN DISTS SERVE AS FIGETOPPING.

POR PLATIOFITI FRAME CONSTRUCTION; THE SOLE AND INCHES OF WOOD BLOCKING PLACED BETWEEN JOISTS

8. THE HEADER SERVES AS FIRE-STOPPING.

9. TWO-INCH WOOD BLOCKING OR THE EQUIVALENT SHALI

RESTOPPING SHALL NOT BE REQUIRED WHEN THE ROTTOM OF

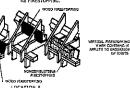



NONCOMBUSTIBLE PLASSTOPPLE APPROX. 1 SNOW THICK

6 REQUIREMENTS FOR WINDBORNE 0005/ **DEBRIS REGIONS**

IF PROJECT IS WITHIN ONE MILE OF ANY BODY OF WATER IN 130mph WIND ZONE, THEN THIS SECTION APPLIES -IT IS THE RESPONSIBILITY OF THE GENERAL CONTRACTOR TO CARRY OUT REQUIREMENTS AS SPECIFIED BELOW

2020 RESIDENTIAL CODE OF NEW YORK STATE:

KRULLIZ FOR ISCHINGO U COMINGO DIO TOTO MINISTRATION DE BRIS REGIONS SHALL BE PROTECTED FROM WINDEDDRIC DEBRIS, GLAZED D'ENTINE PROTECTION FOR WINDEDDRIC DEBRIS.
SHALL REET THE REQUIREMENTS OF THE LARGE HISBLIZ TEST OF ASTIME 1996 AND ASTIME 1886 AS NODIFICO IN SECTION 301.2.1.2.1. GRADE ODOR GLAZED OPENING PROTECTION
FOR WINDEDDRIC DEBRIS SHALL METH IS REQUIREMENTS OF AN APPROVED IMPACT, RESISTING STANDARD OR ANAEVASIAN 1.15.

EXCEPTION: WOOD STRUCTURAL PARIES WITH A THICKNIESS OF NOT LESS THAN 1/16 INCH AND A SPAN OF NOT NORE THAN 8 PEET SHALL BE PERMITTED FOR OPENING PROTECTION, PARIES SHALL BE PRECUIT AND ATTACHED TO THE FRANKIS SURROUNDING THE OPENING CONTAINING THE PRODUCT WITH THE GLAZED OPENING, PRINCE, PRINC

NOTE: THE GENERAL CONTRACTOR IS TO PROVIDE THIS STRUCTURE #/ 1/2* COX PLYWOOD SHEATHING PAKELS M/ PRE-DRILLED HOLES FOR THE PASTERING HARDWARE (SCREWS-SEE TABLE R301.2,1.2) (SCREWS-SEE TABLE R301.2,1.2)
FOR ALL WINDOWS AND DODES,
TO BE STORED ON SITE. THE PASTEMERS
SHALL BE PREINSTALLED READY FOR
RYMYDOD PARILES TO BE APPLIED PRIOR
TO A STORM EVENT.

		NE DEBRIS FASTENIN ANELS (PLYWOOD SH		
		PASTENING SPACING		
FASTENING TYPE	PANEL SPAN ≤ 4 FOOT	4 FOOT < PANEL SPAN	6 FOOT < PANEL SPAN ≤ 8 FOOT	
No. 8 wood screw based anchor with 2-inch embedment length	15 IN, O,C,	10 IN. O.C.	B IN, O.C.	
No. 10 wood screw based anchor with 2-inch embedment length	16 IN. D.C.	12 [N, O.C,	9 IN. O.C.	
1/4-inch wood screw based arichor with 2-inch embedment length	16 IN. O.C.	18 IN, O.C.	16 IN. O.C.	


- THIS TRABLE IS MASO ON 180 MPG LITHANTE DESIGN WIND SPESION AND 33-YOUT HEAN NOOF HEIGHT.

 FASTERIERS SHALL BE HISTALLED AT OPPOSING EXIOS OF THIS WOOD STRUCTURA PARKEL, PRISTRIERS SHALL SELECATED NOT LESS THAN 1 INCH FROM THE EDGE OF THE PARKEL,
 ARCHORS SHALL PRINCIPANT THROUGHT THE INTERIOR WALL COMMENTAL WITH AN EMBEROMENT LEWIST OF MOT LESS THAN 2 INCHES MITO THE BUILDING FRANCE, PASTERIERS SHALL
 LOCATED FOR LESS THAN 2 INCHES TO THE BOSE OF CONCUSES BUILDING VITAL PRINCIPANT AND THE SALL PRINCIPANT A

0005

ENGINEERED WOOD PLACARD

BUILDING AS PER PART 1265 OF TITLE 19 NYCRR.

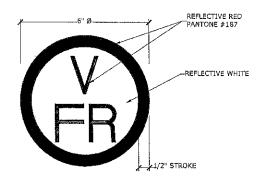

STRUCTURAL CRITERIA

0005

MINIMUM UNIFORMLY DISTRIBUTED DESIGN LOADS [LIVE LOADS AS PER TABLE R301,5 AND SNOW LOAD AS PER FIGURE R301.2(6) OF 2020 RESIDENTIAL CODE OF NEW YORK STATE?

USE	LIVE LOAD	DEAD LOAI
UMINKABITABLE ATTICS WITHOUT STORAGE	10 psf	10 psf
uninhabiyable attics with Limited Storage	20 psf	10 psf
HABITABLE ATTICS AND ATTICS SERVED WITH FIXED STAIRS	30 psf	10 psf
EXT, BALCOMIES AND DECKS	40 psf	15 psf
FIRE ESCAPES	40 psf	AS PER PLAN
GUARDITAILS AND HANDITAILS	200 psf	
GUARDRAILS (NFILL COMPONENTS	50 psf	
Passenger Vehicle Garages	50 psf	AS PER PLAN
ROOMS OTHER THAN SLEEPING ROOMS	40 psf	15 psf
SLEEPING ROOMS	30 psf	15 psf
STAIRS	40 psf	15 psf
ROOF LOADING (LIVE = GROUND SNOW LOAD)	20 psf	12 psf FOR ATTIC 15 psf FOR CATH.

ALLOWABLE DEFLECTION OF STRUCTURAL MEMBERS (TABLE R301.7 OF 2020 RESIDENTIAL CODE OF NEW

STRUCTURAL MEMBER	ALLOWABLE DEFLECTION
RAFTERS HAVING SLOPES GREATER THAN 3/12 WITH NO FINISHED CEILING ATTACHED TO RAFTERS	1/180
INTERIOR WALLS AND PARTITIONS	H/180
FLOORS	L/360
CENLINGS WITH BRITTLE FINISHES (INCLUDING PLASFER AND STUCCO)	L/360
CEILINGS WITH FLEXIBLE FINISHES (INCLUDING GYPSUM BOARD)	L/240
ALL OTHER STRUCTURAL MEMBERS	L/240
EXTERIOR WALLS - WIND LUADS WITH PLASTER OR STUCCO FINISH	H/360
EXTERIOR WALLS - WIND LOADS WITH OTHER ORITILE FINISHES	H/240
EXTERIOR WALLS - WIND LOADS WITH PLEXIBLE FINISHES	H/120
LINTELS SUPPORTING MASONRY VENEER WALLS	1,400

NOTE: L = SPAN LENGTH H = SPAN HEIGHT SEE CODE FOR FOOTNOTES

MINIMUM SPECIFIED COMPRESSIVE STRENGTH OF CONCRETE [TABLE R402.2 OF 2020 RESIDENTIAL CODE OF NEW

TYPE OR LOCATIONS OF CONCRETE CONSTRUCTION	MIN. SPECIFIED COMPRESSIVE STRENGTH (fc)
	WEATHERING POTENTIAL - SEVERE
ALL BASEMENT WALLS, FOUNDATION WALLS, EXTERIOR WALLS AND OTHER VERTICAL CONCRETE WORK	3,000
PORCHES, CARPORT SLADS ANO STEPS EXPOSED TO WEATHER, AND GARAGE FLOOR SLADS	3,500

SEE CODE FOR FOOTNOTES

PRESUMPTIVE LOAD-BEARING VALUES OF FOUNDATION MATERIALS [TABLE R401.4.1 OF 2020 RESIDENTIAL CODE OF NEW

YORK STATE	
CLASS OF MATERIAL	LOAD BEARING PRESSURE (PSF)
CRYSTALLINE BEDROCK	12,000
SEDEMENTARY AND FOLIATED ROCK	4,000
SANDY GRAVEL ARD/OR GRAVEL (GVI AND GP)	3,000
SAND, SILTY SAND, CLAYEY SAND, SILTY GRAVEL, AND CLAYEY GRAVEL (SYY, SP, SM, SC, GM, AND GC)	2,000
CLAY, SANDY, SILTY CLAY, CLAYEY SILT, SILT, AND SANDY SILTCLAY (CL, ML, MH, AND CH)	1,500

SEE CODE FOR FOOTNOTES

TO BE FIELD VERIFIED

COPYRIGHT @

ALL DIMENSIONS

THIS AND ALL DOCUMENTS PRODUCED BY THIS FIRM UNDER THIS AGREEMENT, SHALL REMAIN THE SOLE PROPERTY OF THIS FIRM AND MAY NOT BE USED. COPIED, CHANGED OR DISTRIBUTED BY THE CLIENT OR OTHERS WITHOUT WRITTEN CONSENT OF THIS FIRM,

SCOPE OF WORK:

NEW 2nd STORY & CELLAR ADDITION

REVISIONS	DATE	BY
11411010110	1 01112	<u>51</u>
	1	
	1	
	 	
	+	•
	1	

DeFONSECA ARCHITECTS KINGS PARK, NY 11754 TEL: (917) 3537758 (631) 7247744 adob@aol.com defonsecaarchilec.s@gmail.com defonsecaarchitecture.com

PROJECT

HARVESTS CHURCH 2368 ROUTE 90 WAPPINGER FALLS 12590 DUCHESS COUNTY NY

DETAILS



DATE: 11-07-2023 PROJECT No.: DRAWING BY: CHECKED BY: DWG. No.: D-005.00

SHEET